



140 Stonewall Avenue West, Ste 204 Fayetteville, GA 30214 Phone: 770-305-5420 www.fayettecountyga.gov

January 13, 2020

Subject: RFQ #1763-A: Crosstown Raw Water Pump VFD Replacement - Addendum #1

Gentlemen/Ladies:

Below, please find responses to questions, clarification, or additional information for the above referenced request for quote. You will need to consider this information when preparing your quote.

- Where are the drives currently getting the "call to run" signal from?
 The "call to run" signal originates at the Horner PLC in the filter building.
- 2. Have the motors been checked since the drives failed?

 The motors have not been tested since the drives have failed. Prior to installing new drives, vendor shall perform a Megger test to determine condition of each motor.
- 3. Do the motors have any protectors on them?
 The motors have thermal protection wire into the system.
- 4. Does the drive need to be heavy duty or normal duty? The drive should be a normal drive.
- 5. Can we get the part number for the Eaton Variable Frequency Drive? Cutler-Hammer 40HP VFD Nameplate:



Cutler-Hammer 200 HP Nameplate:

Cutler-Hammer
Milwaukee WI, USA
SV9000 Series
POWER CONVERSION EQUIPMENT
s no 9328884

6. Is there a set of drawings available? If yes, can we get them? Drawings are attached.

- 7. The successful company who is awarded a contract for the performance of this work shall be in compliance with all requirements of the Georgia Construction Industry Licensing Board's Division of Utility Contractors, Georgia Code Title 43, and any other regulations or requirements for the performance of this work. Companies submitting a quote shall include a copy of their Georgia Certificate of Registration or other acceptable license or documentation, as appropriate.
- 8. The Checklist of Required Documents has been updated and is attached for your use.

Received by (Name):				 Company								

Note: If this addendum is not returned to the Fayette County Purchasing Department or if it is returned not signed, responding individuals, companies or other organizations will still be responsible for the requirements of this addendum and the specifications or changes herein.

The opening date for this RFQ has not changed. Quotes must be received by the Purchasing Department at the address above, Suite 204, at or before the opening date and time.

The deadline for inquiries has passed, so the Purchasing Department will not be able to accept any additional questions after this time.

If you have questions, please contact Natasha Duggan, Contract Administrator at (770) 305-5150 fax (770) 719-5534 or email at nduggan@fayettecountyga.gov.

Sincerely,

Ted L. Burgess

Director of Purchasing

CROSSTOWN TREATMENT PLANT RAW WATER FLOW MODIFICATIONS

FOR

FAYETTE COUNTY WATER SYSTEM


TONY V. PARROTT, DIRECTOR

AUTHORIZED BY:

FAYETTE COUNTY BOARD OF COMMISSIONERS

HAROLD BOST, CHAIRMAN
GREG DUNN, VICE-CHAIRMAN
HERB FRADY
GLEN GOSA
LINDA WELLS

8

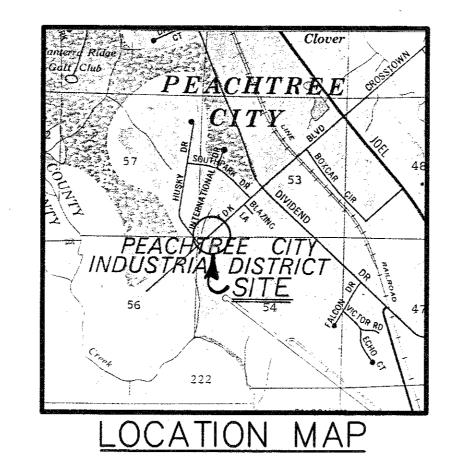




CROSSTOWN TREATMENT PLANT
RAW WATER FLOW MODIFICATIONS
for FAYETTE COUNTY WATER SYSTEM

	COVER SHEET	
LAND LOT - 53 & 54	DESIGN PES	SCALE NTS
DISTRICT - 6TH	DRAWN	DATE
SECTION - XXX	PES	11/2/99
CITY — PEACHTREE CITY	CHECK	FILE NO.
COUNTY - FAYETTE	APPROVED	99127 SHEET ND.

BY APP'D STATE - GEORGIA

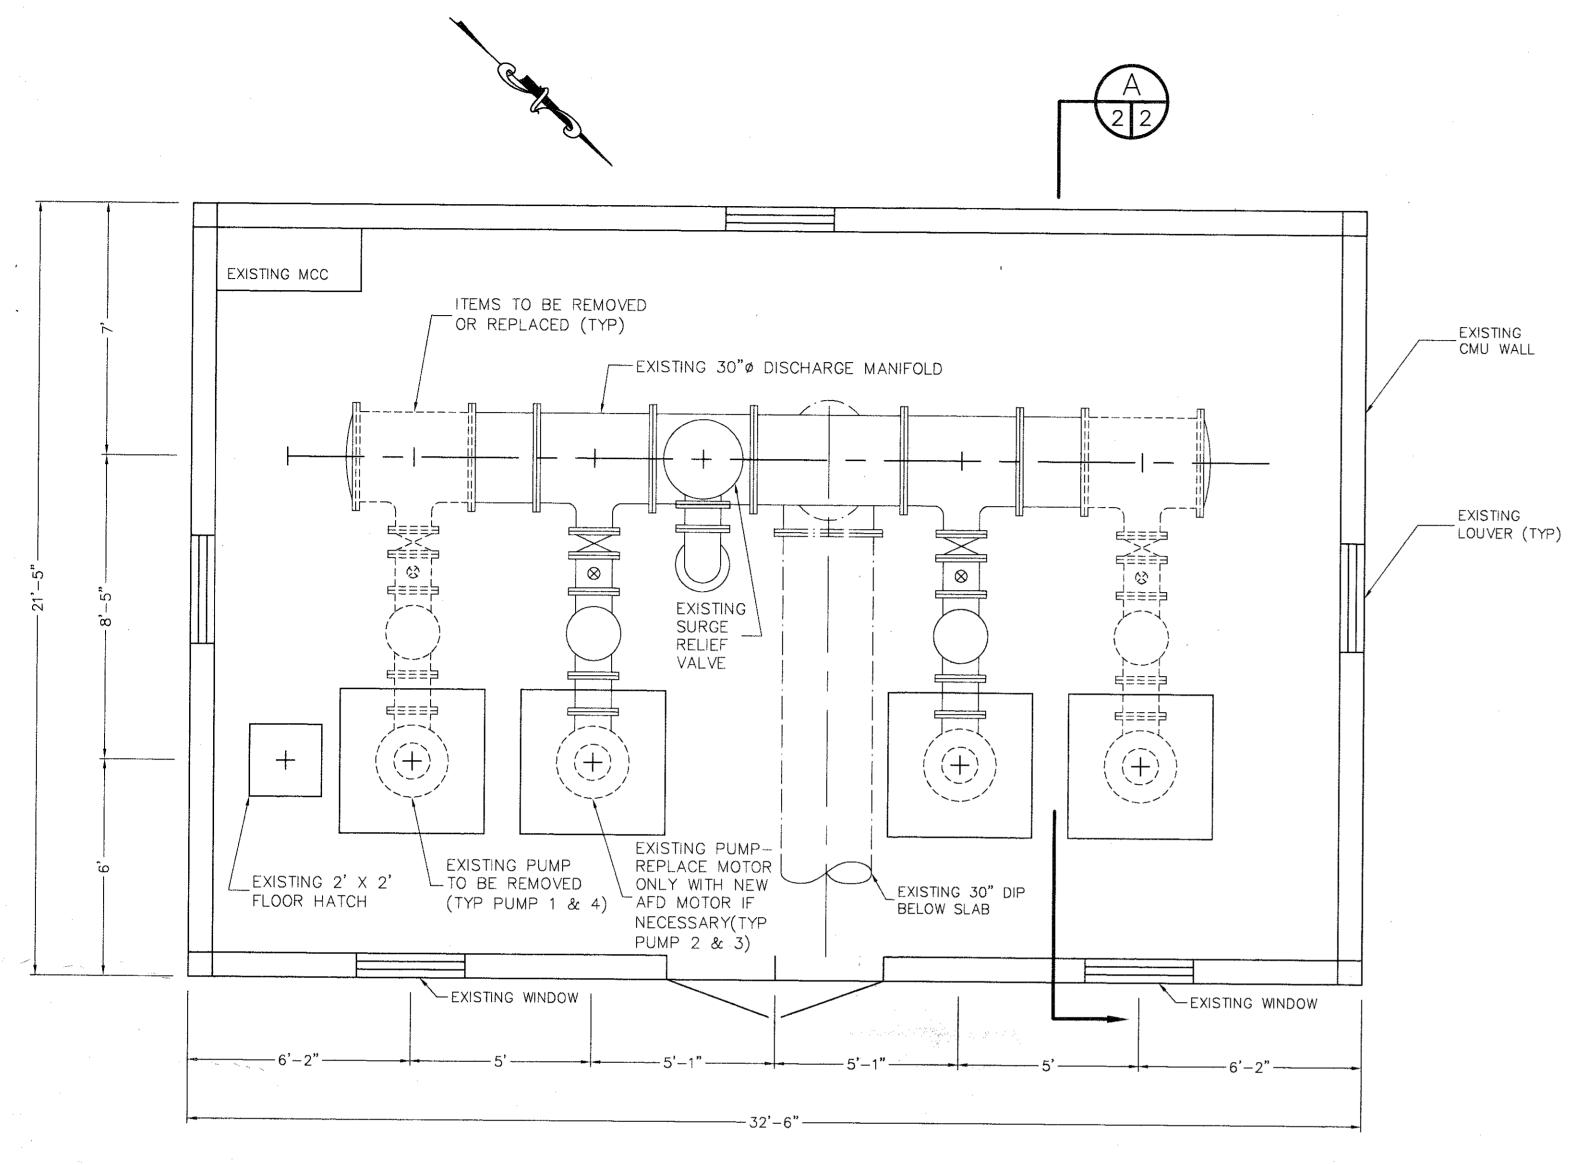

PLAN VIEW — EXISTING RAW WATER PUMP STATION 3/8" = 1'-0"

NOTES:

CONTRACTOR SHALL FIELD VERIFY ALL DIMENSIONS AND ELEVATIONS PRIOR TO ORDERING EQUIPMENT AND MATERIALS.

CONTRACTOR SHALL ADJUST HEIGHT OF EXISTING CONCRETE PUMP PAD AS REQUIRED TO ALIGN PROPOSED PUMP DISCHARGE FLANGE, CHECK VALVE AND PIPING WITH NEW 16" ISOLATION VALVE AND 30" X 16" TEE.

ALL PIPE & FLANGES SHALL BE DUCTILE IRON, CLASS 53, 125 LB. STD.

ALL NEW AND EXISTING PIPING, VALVES & EQUIPMENT SHALL BE PAINTED PER CONTRACT SPECIFICATIONS. COLOR SHALL MATCH EXISTING PIPING, VALVES & EQUIPMENT.

CONTRACTOR SHALL NOT OPERATE OR ADJUST EXISTING PUMPS, VALVES OR OTHER EQUIPMENT WITHOUT PRIOR AUTHORIZATION FROM WATER TREATMENT PLANT OPERATORS.

EXISTING PIPING, VALVES, PUMPS, MOTORS, AND ALL MISC. EQUIPMENT SHOWN TO BE REMOVED SHALL REMAIN THE PROPERTY OF THE OWNER. CONTRACTOR SHALL TRANSPORT AND STORE AT OWNER'S STORAGE FACILITY LOCATED APPROXIMATELY 5 MILES FROM JOB SITE.

CONTRACTOR SHALL SEQUENCE PUMP REMOVAL AND INSTALLATION AS FOLLOWS:


I. REPLACE PUMP #1 WHILE MAINTAINING OWNER'S ABILITY TO OPERATE EXISTING PUMPS #2, #3 AND #4.


2. REPLACE PUMP #4 WHILE MAINTAINING OWNER'S ABILITY TO OPERATE NEW PUMP #1 AND PUMPS #2 AND #3.


3. IF NECESSARY, REPLACE MOTORS FOR PUMPS #2 AND #3 WHILE MAINTAINING OWNER'S ABILITY TO OPERATE NEW PUMPS #1 AND #4.

(PERIODS REQUIRING COMPLETE SHUTDOWN OF PUMP STATION SHALL BE KEPT TO A MINIMUM AND SHALL BE COORDINATED WITH THE OWNER)

FOR PURPOSES OF ADDITIVE ALTERNATE NO. I, SUBSTANTIAL COMPLETION SHALL BE WHEN ONE OF THE NEW IO MGD PUMPS IS IN OPERATION AND THE OWNER MAY OPERATE THE PUMP STATION CONTINUOUSLY WITH THE NEW PUMP, EXCEPT FOR POSSIBLE MINOR PERIODS OF DOWN TIME FOR FINAL TIE - INS, ELECTRICAL CONNECTIONS, ETC.

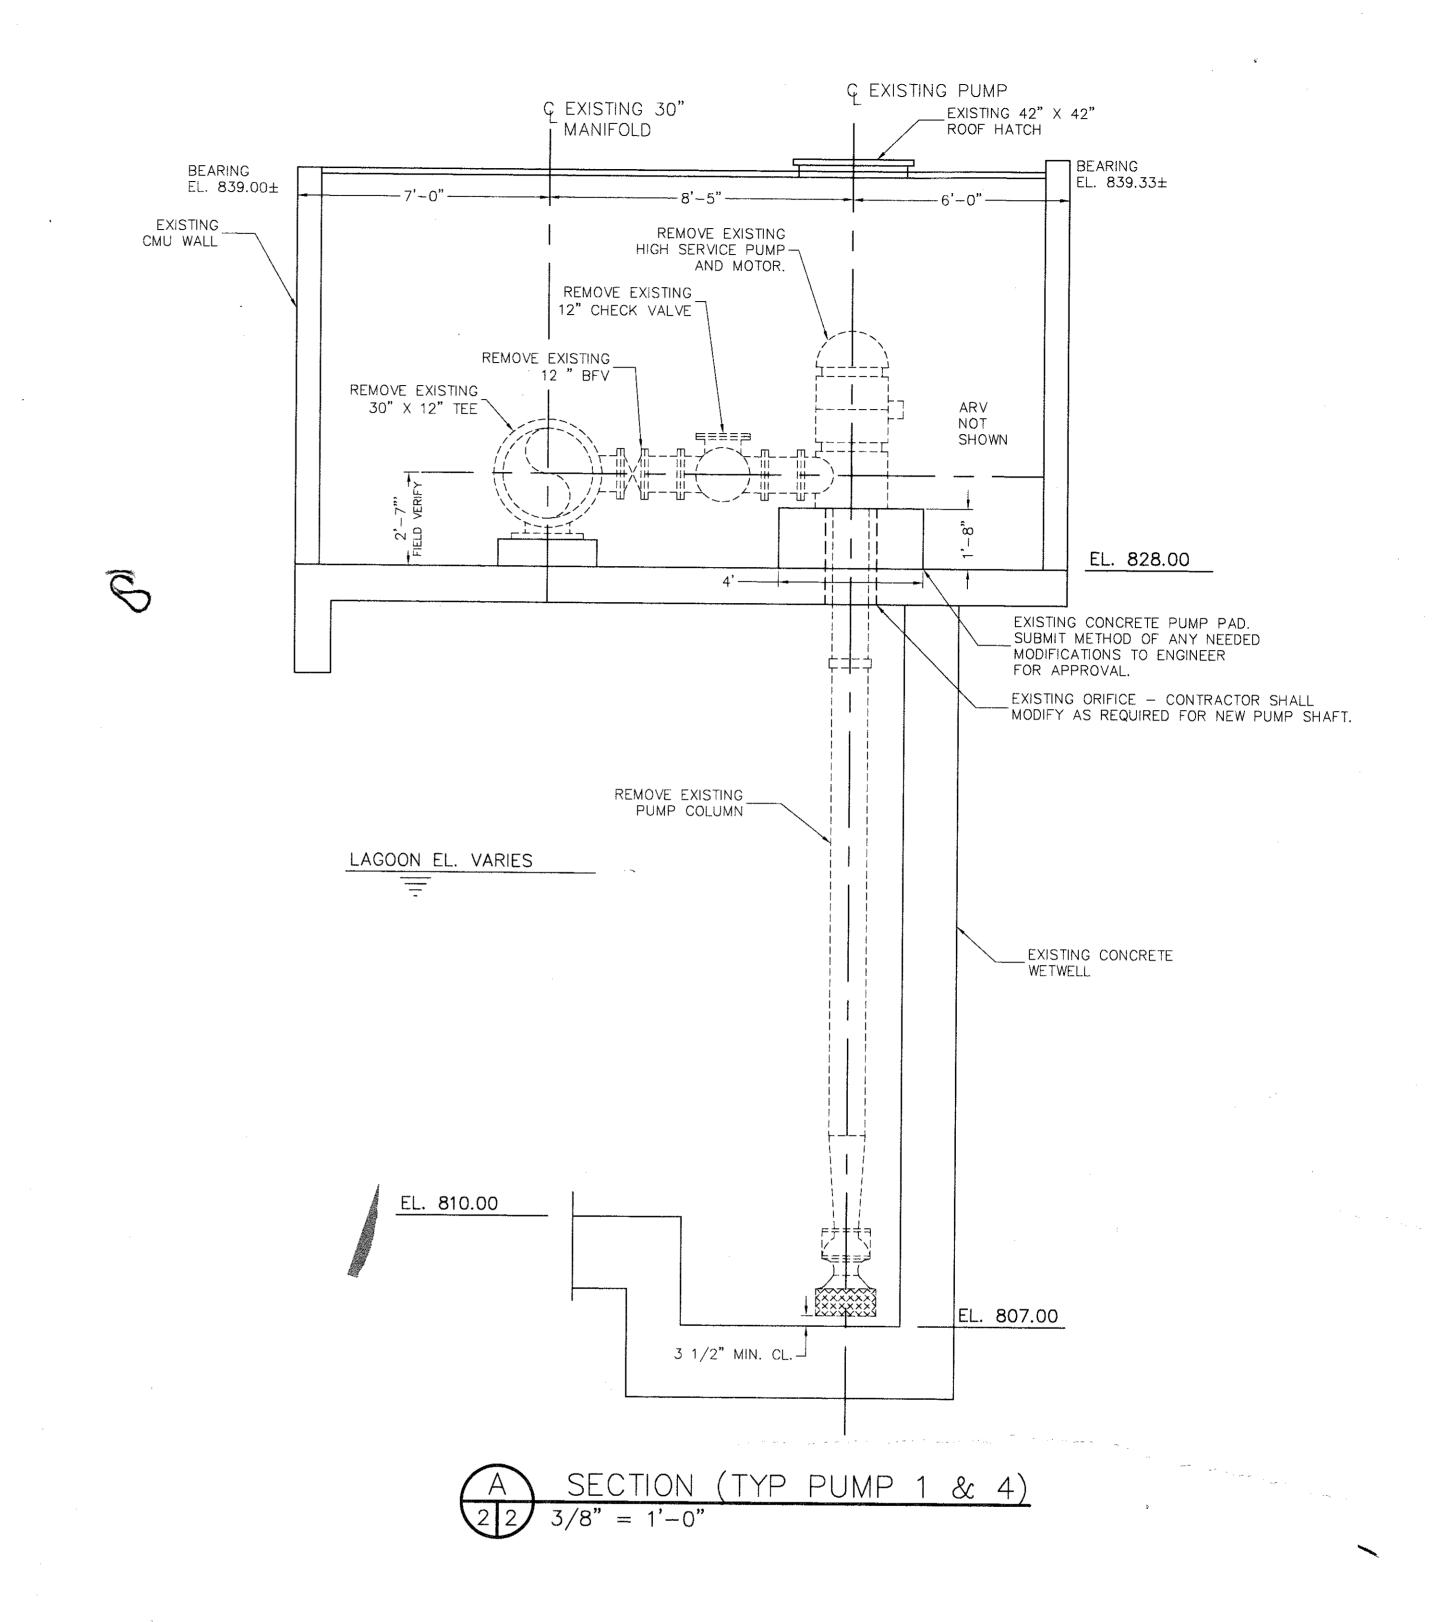

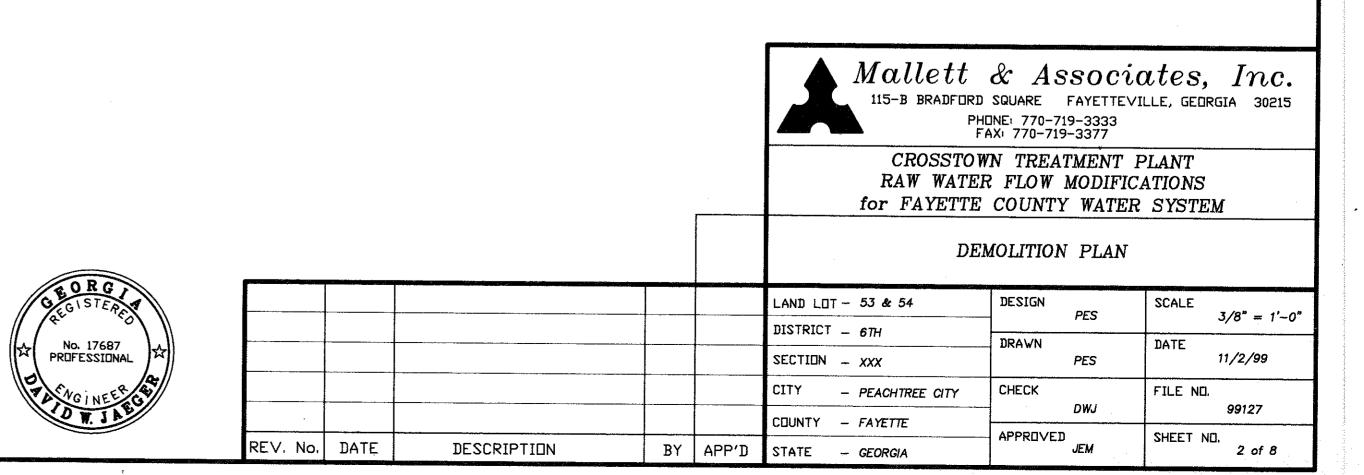


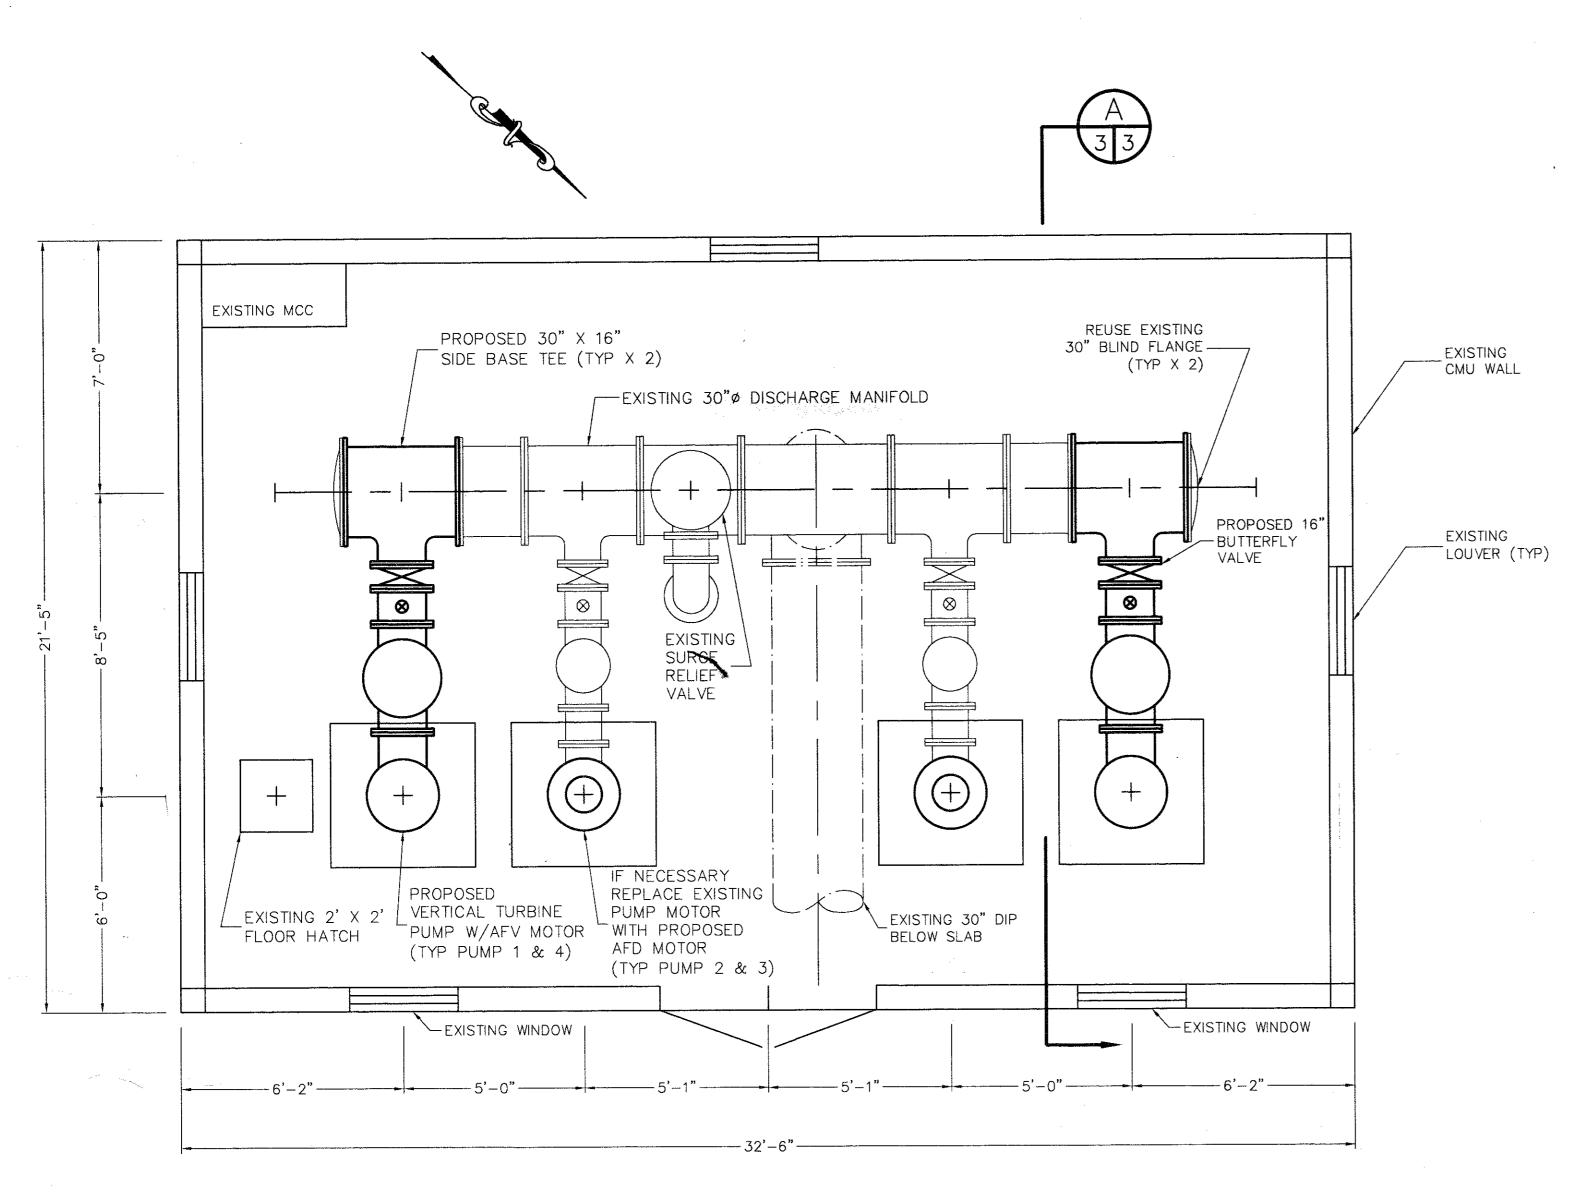


PLAN VIEW — PROPOSED MODIFICATIONS TO


RAW WATER PUMP STATION

3/8" = 1'-0"

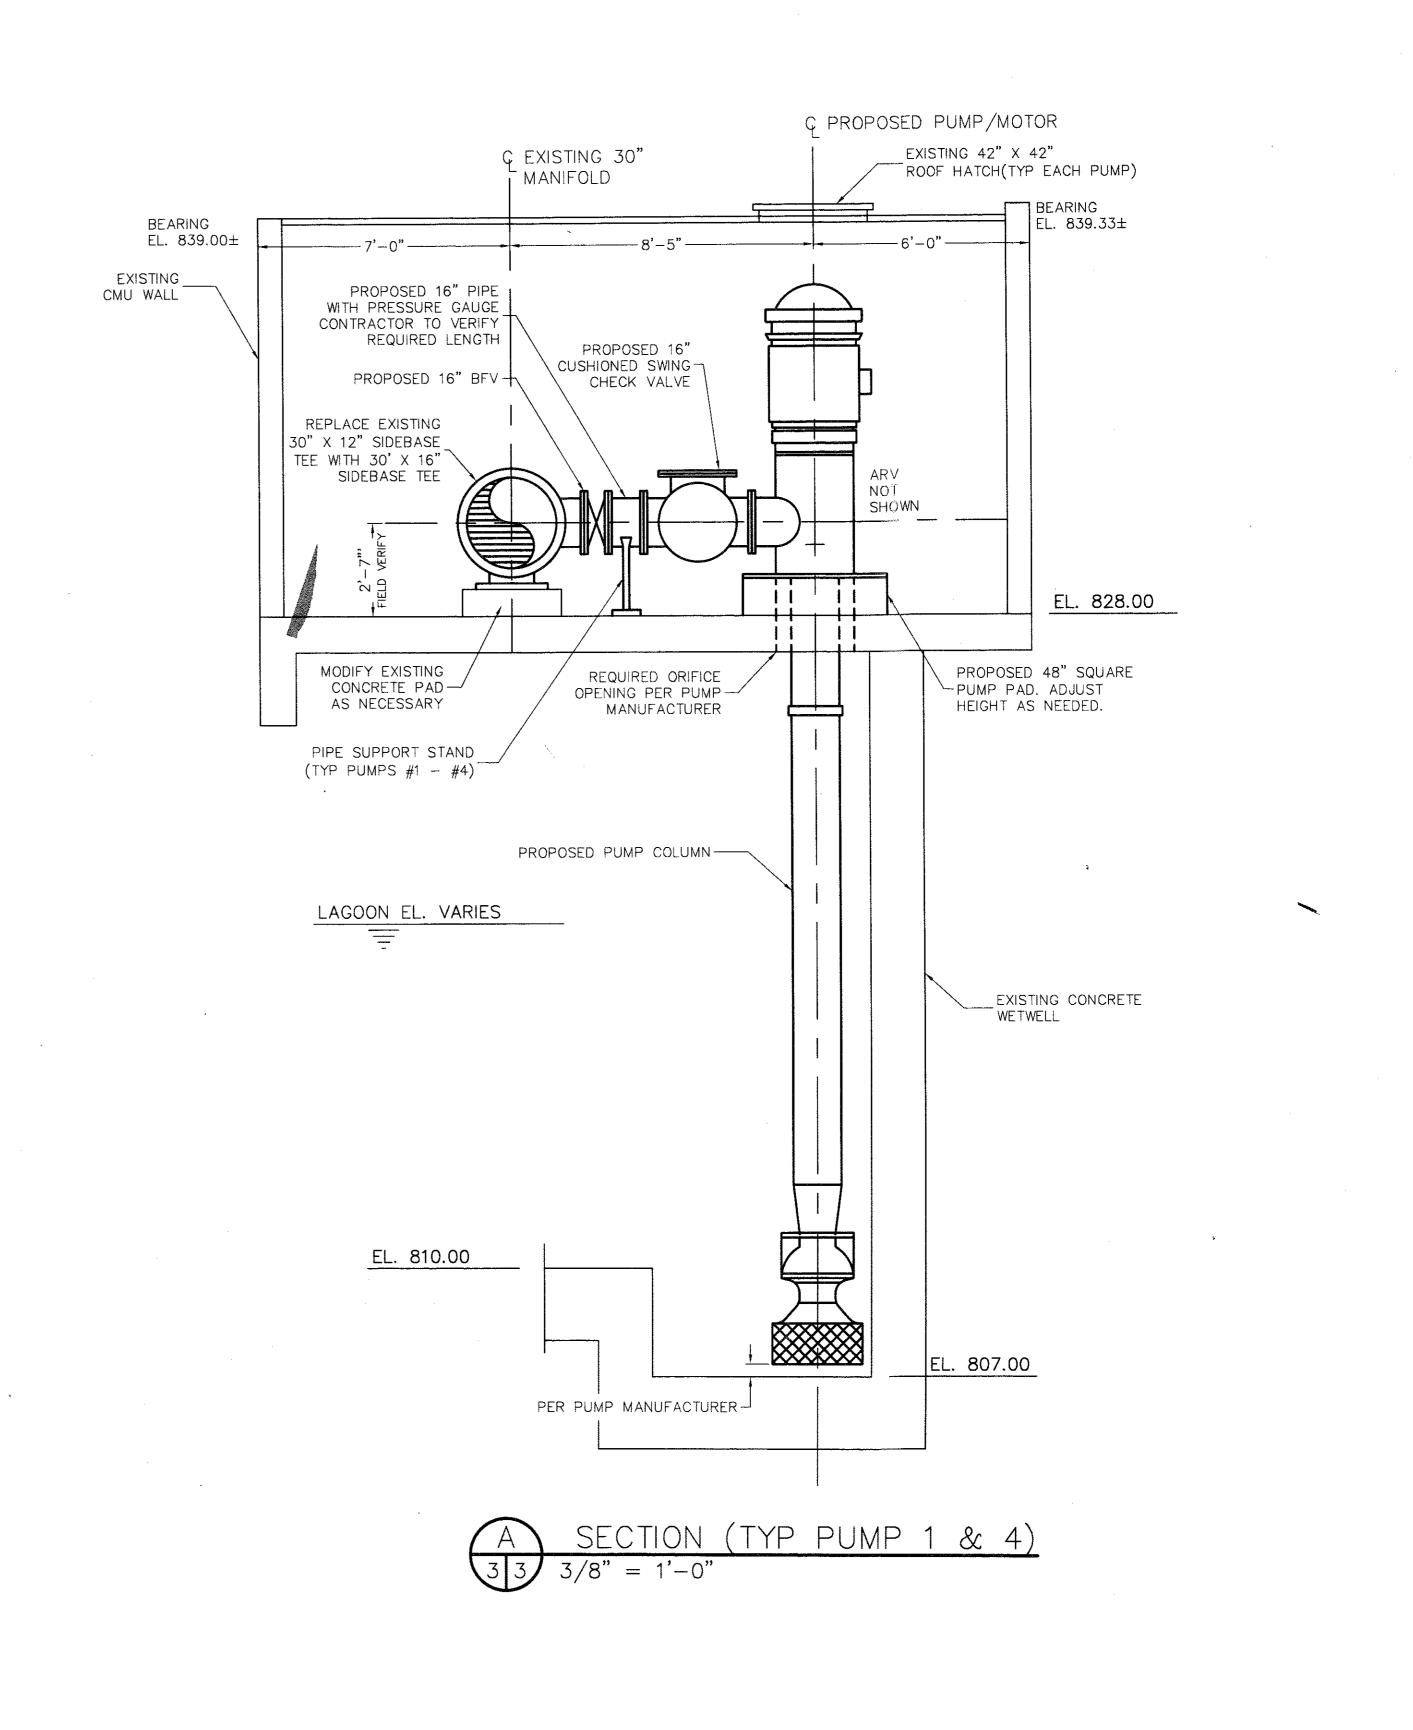

B

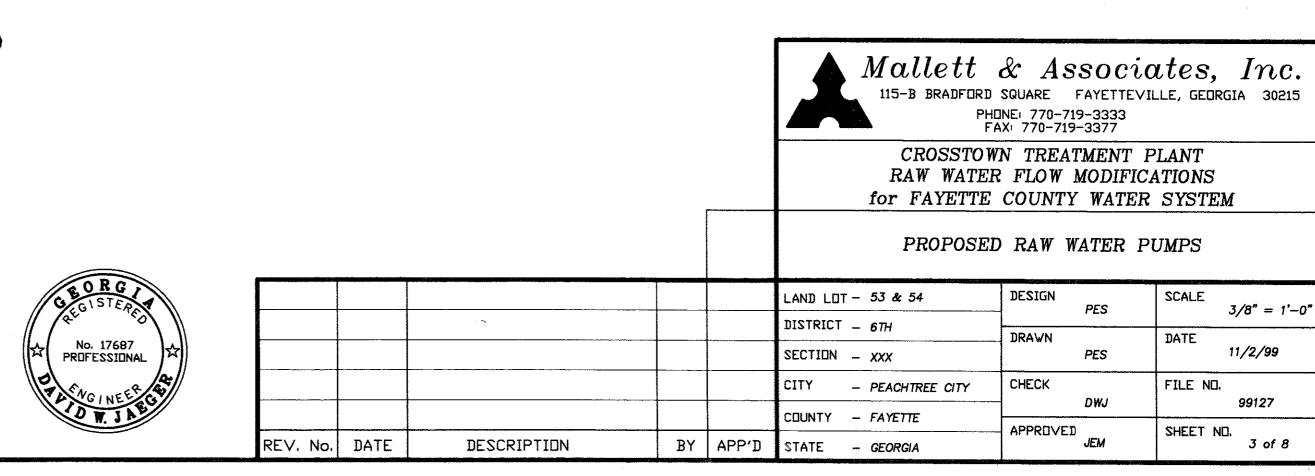

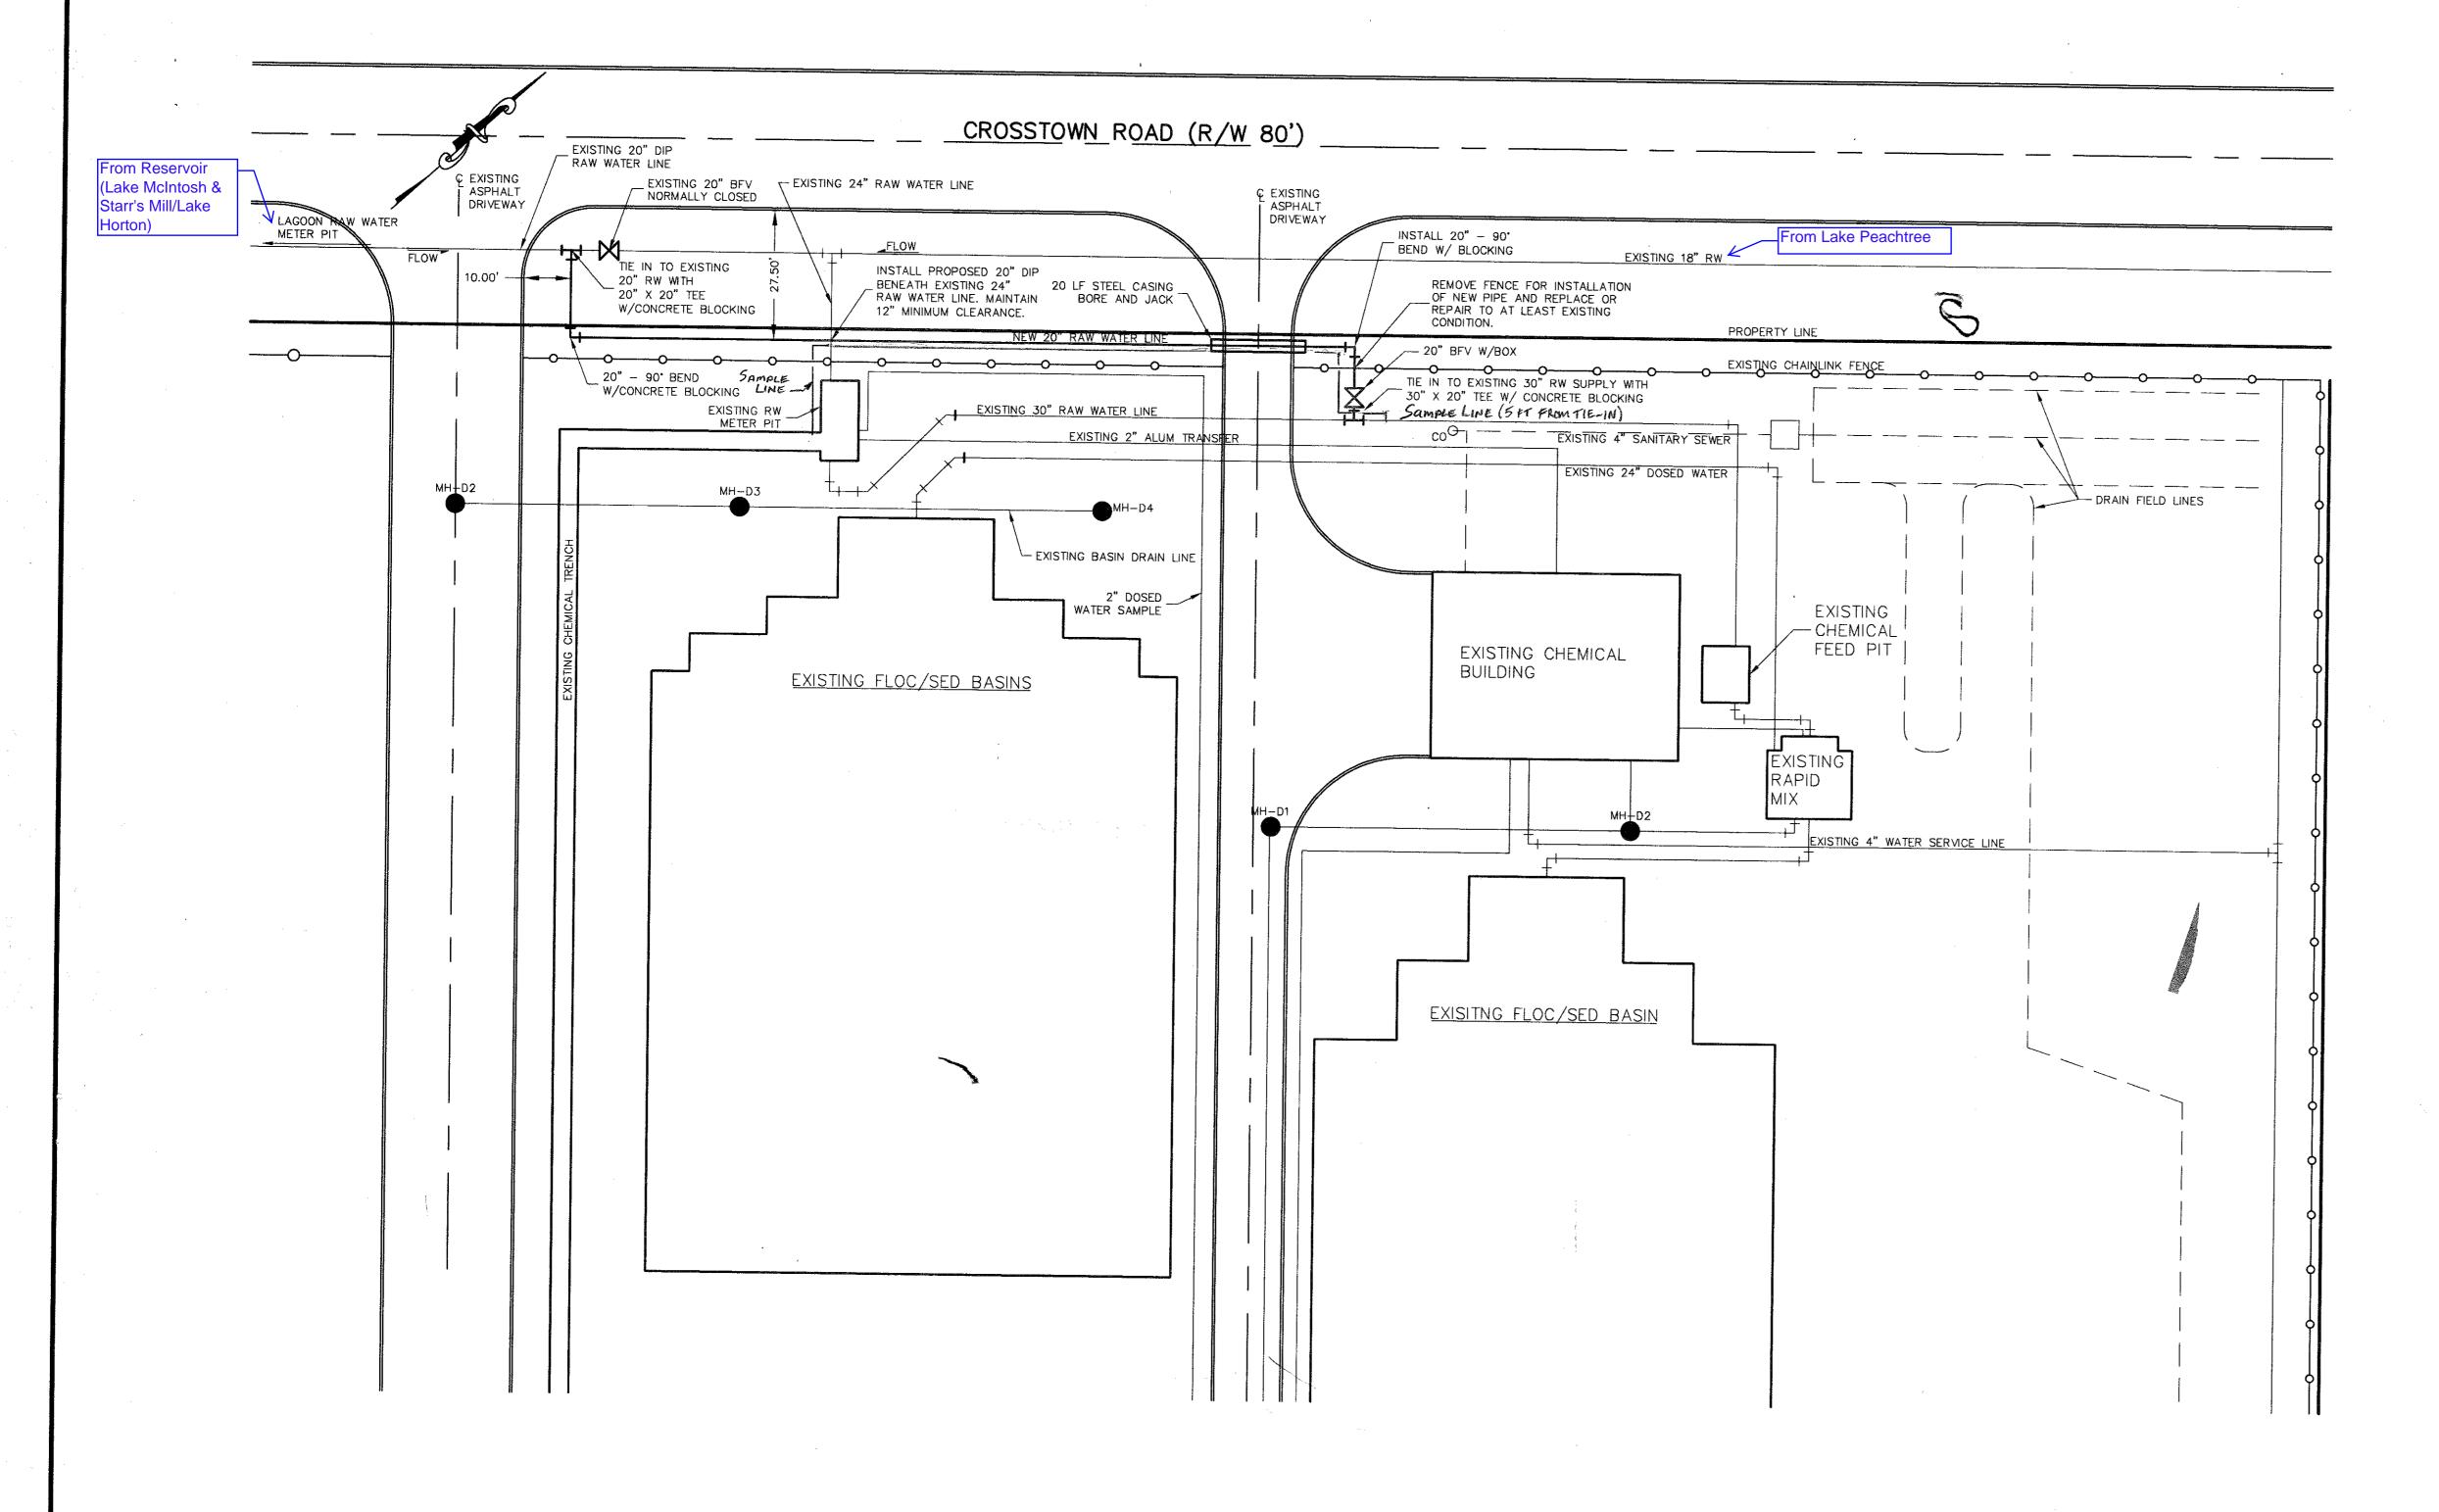

GENERAL NOTES - WATER LINE INSTALLATION

- ALL CONSTRUCTION TO BE IN ACCORDANCE WITH GEORGIA DEPARTMENT OF TRANSPORTATION AND FAYETTE COUNTY STANDARDS, SPECIFICATIONS, AND REGULATIONS (PER GEORGIA DEPARTMENT OF TRANSPORTATION JURISDICTION).
- 2. ANY EXISTING UTILITIES SHOWN ARE APPROXIMATE AND DO NOT NECESSARILY REPRESENT ALL EXISTING UTILITIES. CONTRACTOR TO VERIFY LOCATION OF ALL EXISTING UTILITIES PRIOR TO BEGINNING CONSTRUCTION. ANY DAMAGED UTILITIES SHALL BE REPAIRED AT NO ADDITIONAL COST TO FAYETTE COUNTY WATER SYSTEM. NO COMPENSATION WILL BE MADE FOR DELAYS DUE TO EXISTING UTILITIES.
- 3. ALL TIE-INS TO BE COORDINATED WITH FAYETTE COUNTY WATER SYSTEM. SCHEDULING FOR TIE-INS TO BE DETERMINED BY FAYETTE COUNTY WATER SYSTEM. CONTACT MR. TONY PARROTT AT 770-461-1146 FOR SCHEDULING.
- 4. ALL EXISTING VALVES TO BE OPENED AND CLOSED BY FAYETTE COUNTY WATER SYSTEM EMPLOYEES ONLY.
- 5. ALL WATER LINES TO BE MINIMUM PRESSURE CLASS 300 CEMENT MORTAR LINED, PUSH-ON JOINT, DUCTILE IRON PIPE PER ANSI CI51/A21.51. ALL FITTINGS SHALL BE MECHANICAL JOINT DUCTILE IRON.
- 6. CONTRACTOR IS ADVISED TO VISIT THE PROPOSED WATER ROUTE IN ORDER TO FAMILIARIZE HIMSELF WITH FIELD CONDITIONS, UTILITY LOCATIONS, AND AREAS OF POSSIBLE ROCK EXCAVATION.
- 7. THE WATER LINE CONTRACTOR SHALL CONFORM TO ALL APPLICABLE GEORGIA DEPARTMENT OF TRANSPORTATION AND FAYETTE COUNTY SEDIMENT AND EROSION CONTROL MEASURES IN THE PERFORMACE OF THE INDICATED WORK.
- 8. EROSION CONTROL WILL BE STRICTLY ENFORCED THROUGHOUT THE WORK. CONTRACTOR SHALL SUPPLY AND INSTALL SILTING FENCING, HAY BALES, MULCH MATS, SLOPE STABILIZATION FABRIC, RIP RAP, TEMPORARY AND PERMANENT GRASSING AS REQUIRED TO PREVENT EROSION UNTIL PERMANENT GRASSING HAS BEEN FULLY ESTABLISHED. ALL EROSION CONTROL MEASURES SHALL BE MAINTAINED, REINSTALLED OR RESEEDED AS DIRECTED BY THE ENGINEER. COST FOR EROSION CONTROL REQUIREMENTS SHALL BE INCLUDED IN THE UNIT PRICE BID FOR SIZE AND CLASS OF PIPE.
- 9. TIE-INS TO EXISTING WATER LINES SHALL BE DONE AS SHOWN ON THE DRAWINGS. ANY ADDITIONAL FITTINGS, SLEEVES, CONCRETE BLOCKING AND/OR RESTRAINING DEVICES REQUIRED FOR THESE TIE-INS SHALL BE PROVIDED AND INSTALLED BY THE CONTRACTOR AT NO ADDITIONAL COST. SCHEDULING OF TIE INS SHALL BE COORDINATED WITH THE OWNER.
- IO. DRIVEWAYS DESIGNATED AS "GRAVEL" WHICH HAVE BEEN PAVED PRIOR
 TO WATER LINE INSTALLATION SHALL BE FREE-BORED (NO CASING) AT
 NO ADDITIONAL COST.
- II. CONTRACTOR SHALL PRESERVE, REPAIR AND/OR REPLACE ALL PROPERTY PINS, SIGNS, DRIVEWAYS, MAILBOXES, CULVERTS, GRASSING, FENCES, LANDSCAPING, SOD, AND MISC. PLANTINGS OR STRUCTURES SUCH THAT THE DISTURBED AREAS ARE RETURNED TO THEIR ORIGINAL CONDITION OR BETTER. THIS SHALL BE DONE AT NO ADDITIONAL COST, UNLESS SPECIFIED IN THE BID SCHEDULE.
- 12. PORTIONS OF THIS PROJECT MAY REQUIRE CLEARING AND GRUBBING. NO ADDITIONAL CONTRACT TIME OR ADDITIONAL PAYMENT WILL BE MADE TO MEET THIS REQUIREMENT. ALL TIMBER, BRUSH AND DEBRIS RESULTING FROM CLEARING SHALL BE REMOVED FROM THE SITE AT NO ADDITIONAL COST TO THE CONTRACT.
- 13. NO ADDITIONAL COMPENSATION WILL BE PAID FOR EQUIPMENT, MATERIALS AND LABOR REQUIRED FOR PRESSURE TESTING.
- 14. CONTRACTOR SHALL MAINTAIN ACCESS TO ALL RESIDENTIAL AND COMMERCIAL PROPERTIES THROUGHOUT THE WORK.
- 15. CONTRACTOR SHALL COORDINATE WITH GEORGIA POWER COMPANY AND/OR COWETA-FAYETTE EMC FOR TEMPORARY POWER POLE SUPPORT IN AREAS WHERE GUY WIRES CONFLICT WITH WATER LINE INSTALLATION. THIS WILL BE DONE AT NO ADDITIONAL COST.
- 16. CONTRACTOR WILL COORDINATE WITH GEORGIA POWER COMPANY AND/OR COWETA-FAYETTE EMC FOR SHIELDING OF POWER LINES AND/OR TEMPORARY REMOVAL AND REPLACEMENT OF OVERHEAD LINES OR POLES WHICH MAY CONFLICT WITH PIPE INSTALLATION. THIS SHALL BE DONE AT NO ADDITIONAL COST.
- 17. FINAL GRADING SHALL BE DONE BY LANDSCAPE TRACTOR OR BY SIMILAR EQUIPMENT TO PROVIDE A SMOOTH, UNIFORM SURFACE FREE OF ROCKS, DIRT CLODS, AND OTHER DEBRIS. NO ADDITIONAL PAYMENT WILL BE MADE TO MEET THIS REQUIREMENT.

18. Raw Water Sample Live was
tapped five feet after the new holding
pond raw water line tie-in. The new
Sample line connects to the existing sample line
in the chemical pipe trench. The small
value outside the existing RW meter pit
Will shut off the water to the raw water
sample spigot.




Mallett & Associates, Inc. 115-B BRADFORD SQUARE FAYETTEVILLE, GEORGIA 30215 PHONE: 770-719-3333 FAX: 770-719-3377


CROSSTOWN TREATMENT PLANT
RAW WATER FLOW MODIFICATIONS
for FAYETTE COUNTY WATER SYSTEM

MODIFICATIONS TO YARD PIPING




								11 11 1	
					LAND LOT - 53 & 54	DESIGN	DEC	SCALE	4
					DISTRICT - 6TH		PES		1" = 20'
					SECTION _ XXX	DRAWN	PES	DATE	11/2/99
					CITY — PEACHTREE CITY	CHECK		FILE NO.	
					COUNTY - FAYETTE		DWJ	-	99127
REV, No,	DATE	DESCRIPTION	BY	APP'D	STATE - GEORGIA	APPROVED	JEM	SHEET NO	l. 4 of 8

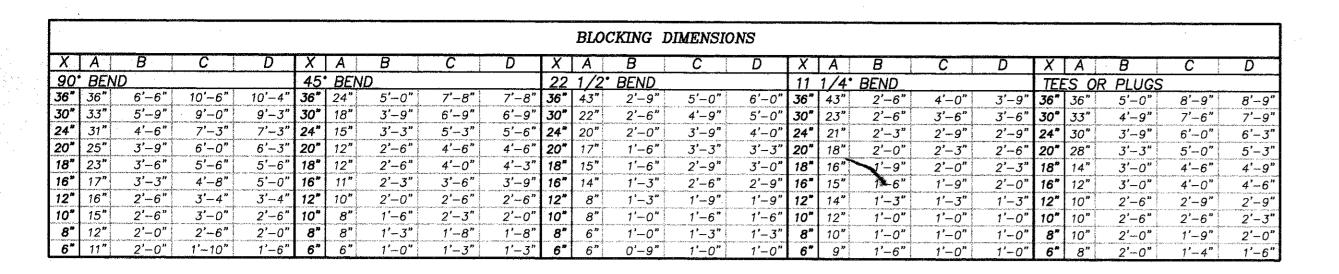


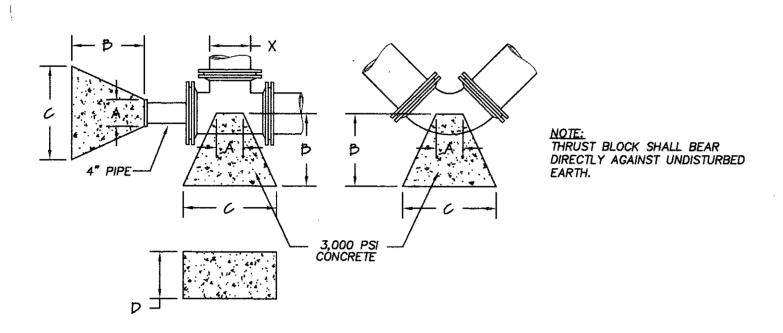



THRUST BLOCKING CHART


(NOT TO SCALE)

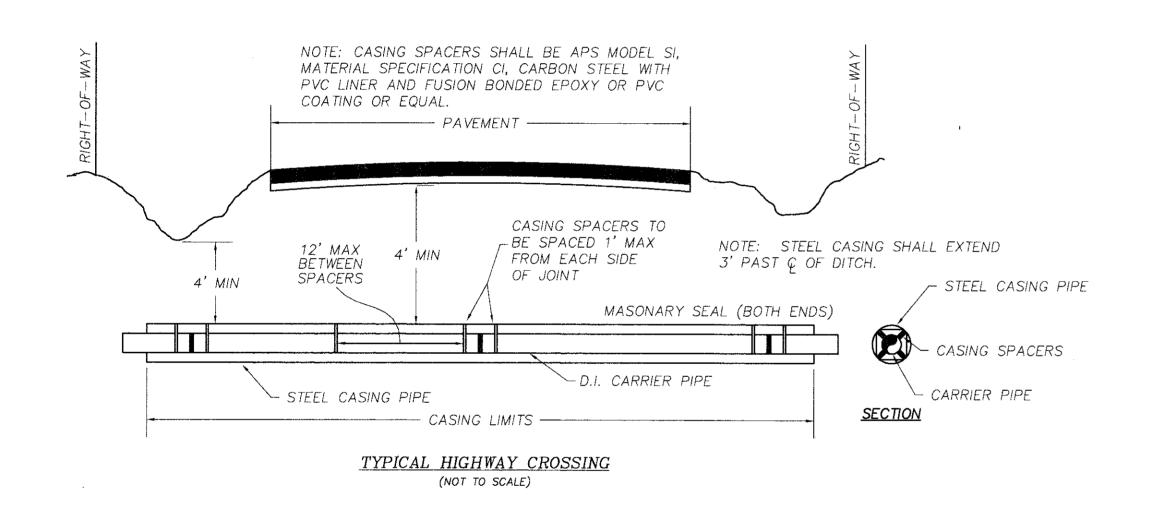

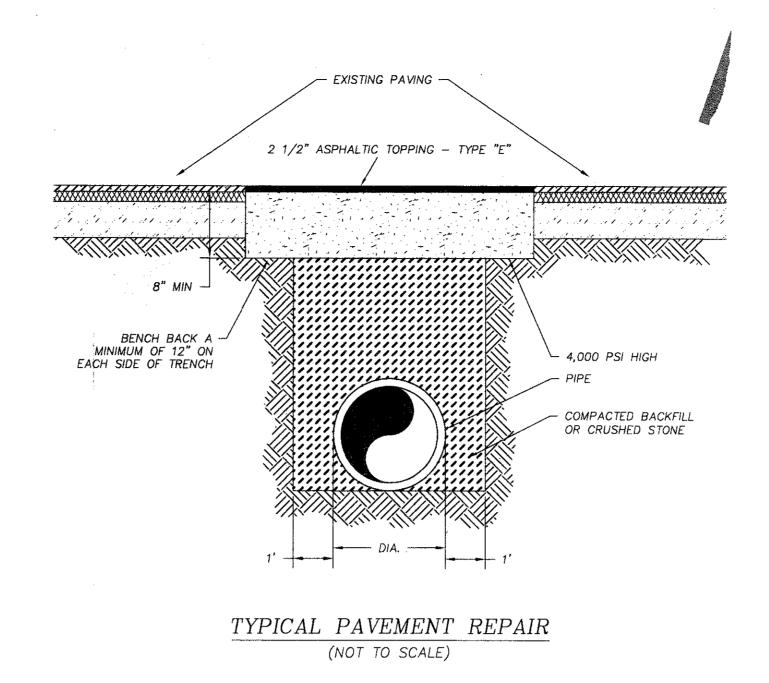


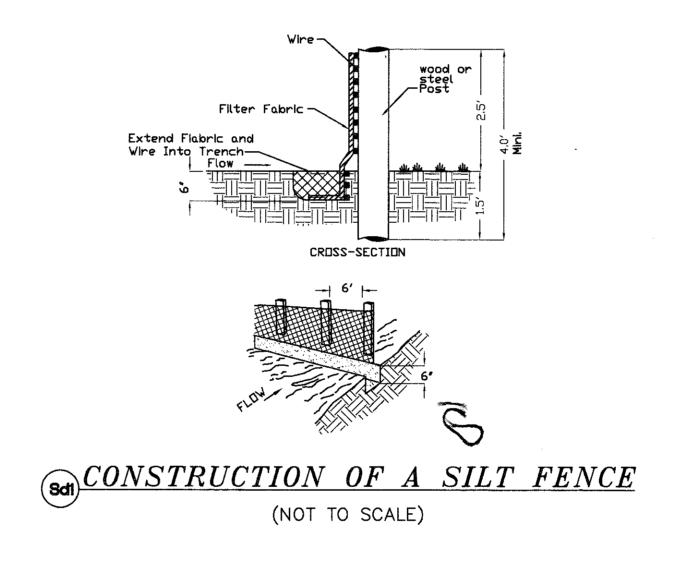

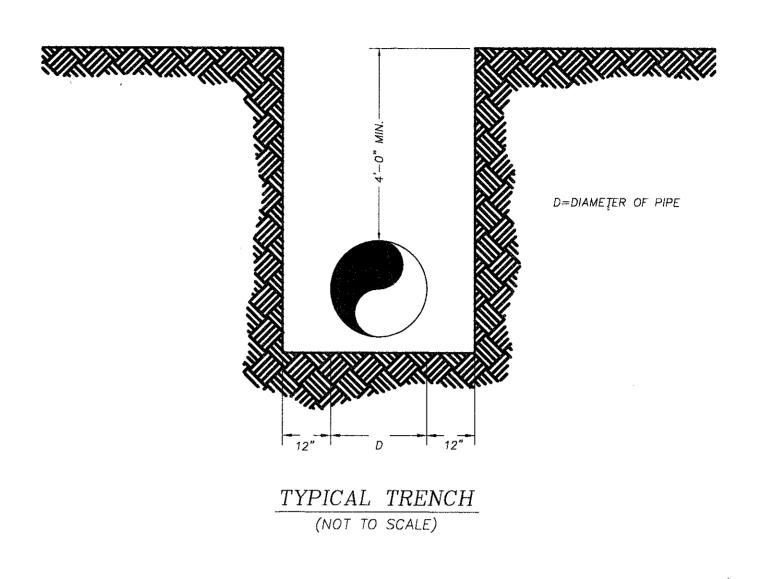

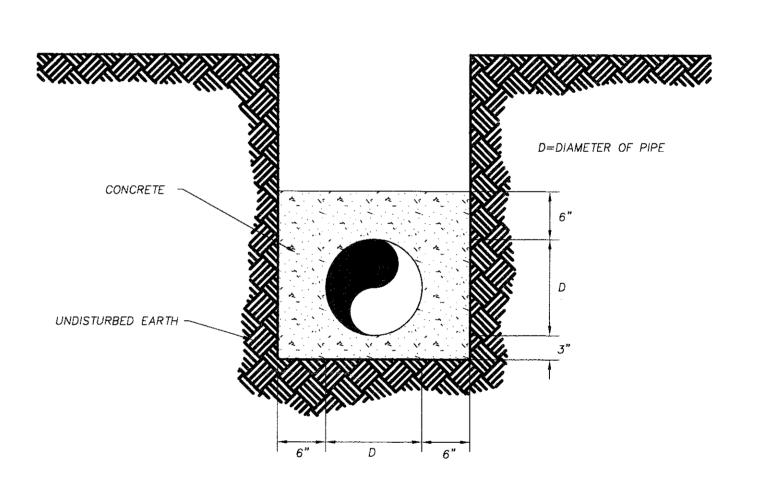

TYPICAL TRENCH WITH CASING (NOT TO SCALE)

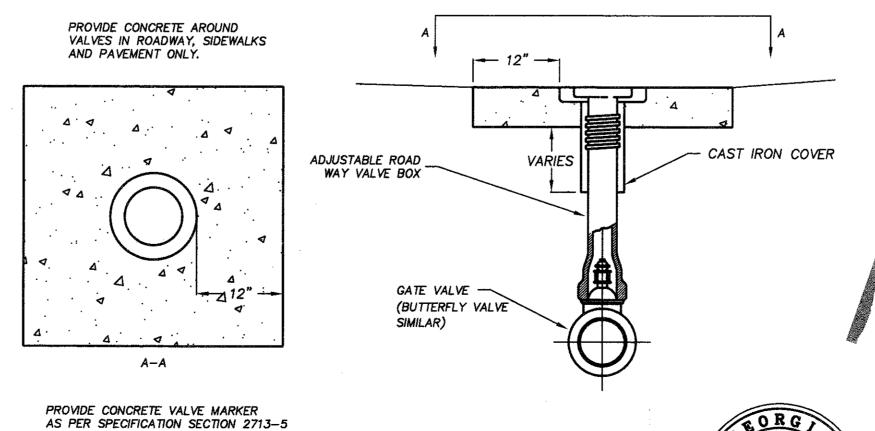

TYPICAL VALVE INSTALLATION
(NOT TO SCALE)



Mallett & Associates, Inc.


115-B BRADFORD SQUARE FAYETTEVILLE, GEORGIA 30215


PHONE: 770-719-3333
FAX: 770-719-3377

CROSSTOWN TREATMENT PLANT
RAW WATER FLOW MODIFICATIONS
for FAYETTE COUNTY WATER SYSTEM

PIPING DETAILS		PIPING	DETAILS	
----------------	--	--------	---------	--

					PIPING DETAILS				
				A 1 A 1 A 1 A 1 A 1 A 1 A 1 A 1 A 1 A 1	LAND LOT - 53 & 54	DESIGN	PES	SCALE NTS	
		N.			DISTRICT — 6TH	DRAWN		DATE	
					SECTION - XXX		PES	11/2/99	
					CITY - PEACHTREE CITY	CHECK	5	FILE NO.	
					COUNTY - FAYETTE	AD0051/FE	DWJ	99127	
REV. No.	DATE	DESCRIPTION	BY	APP'D	STATE - GEORGIA	APPROVED	JEM ·	SHEET ND. 5 of 8	

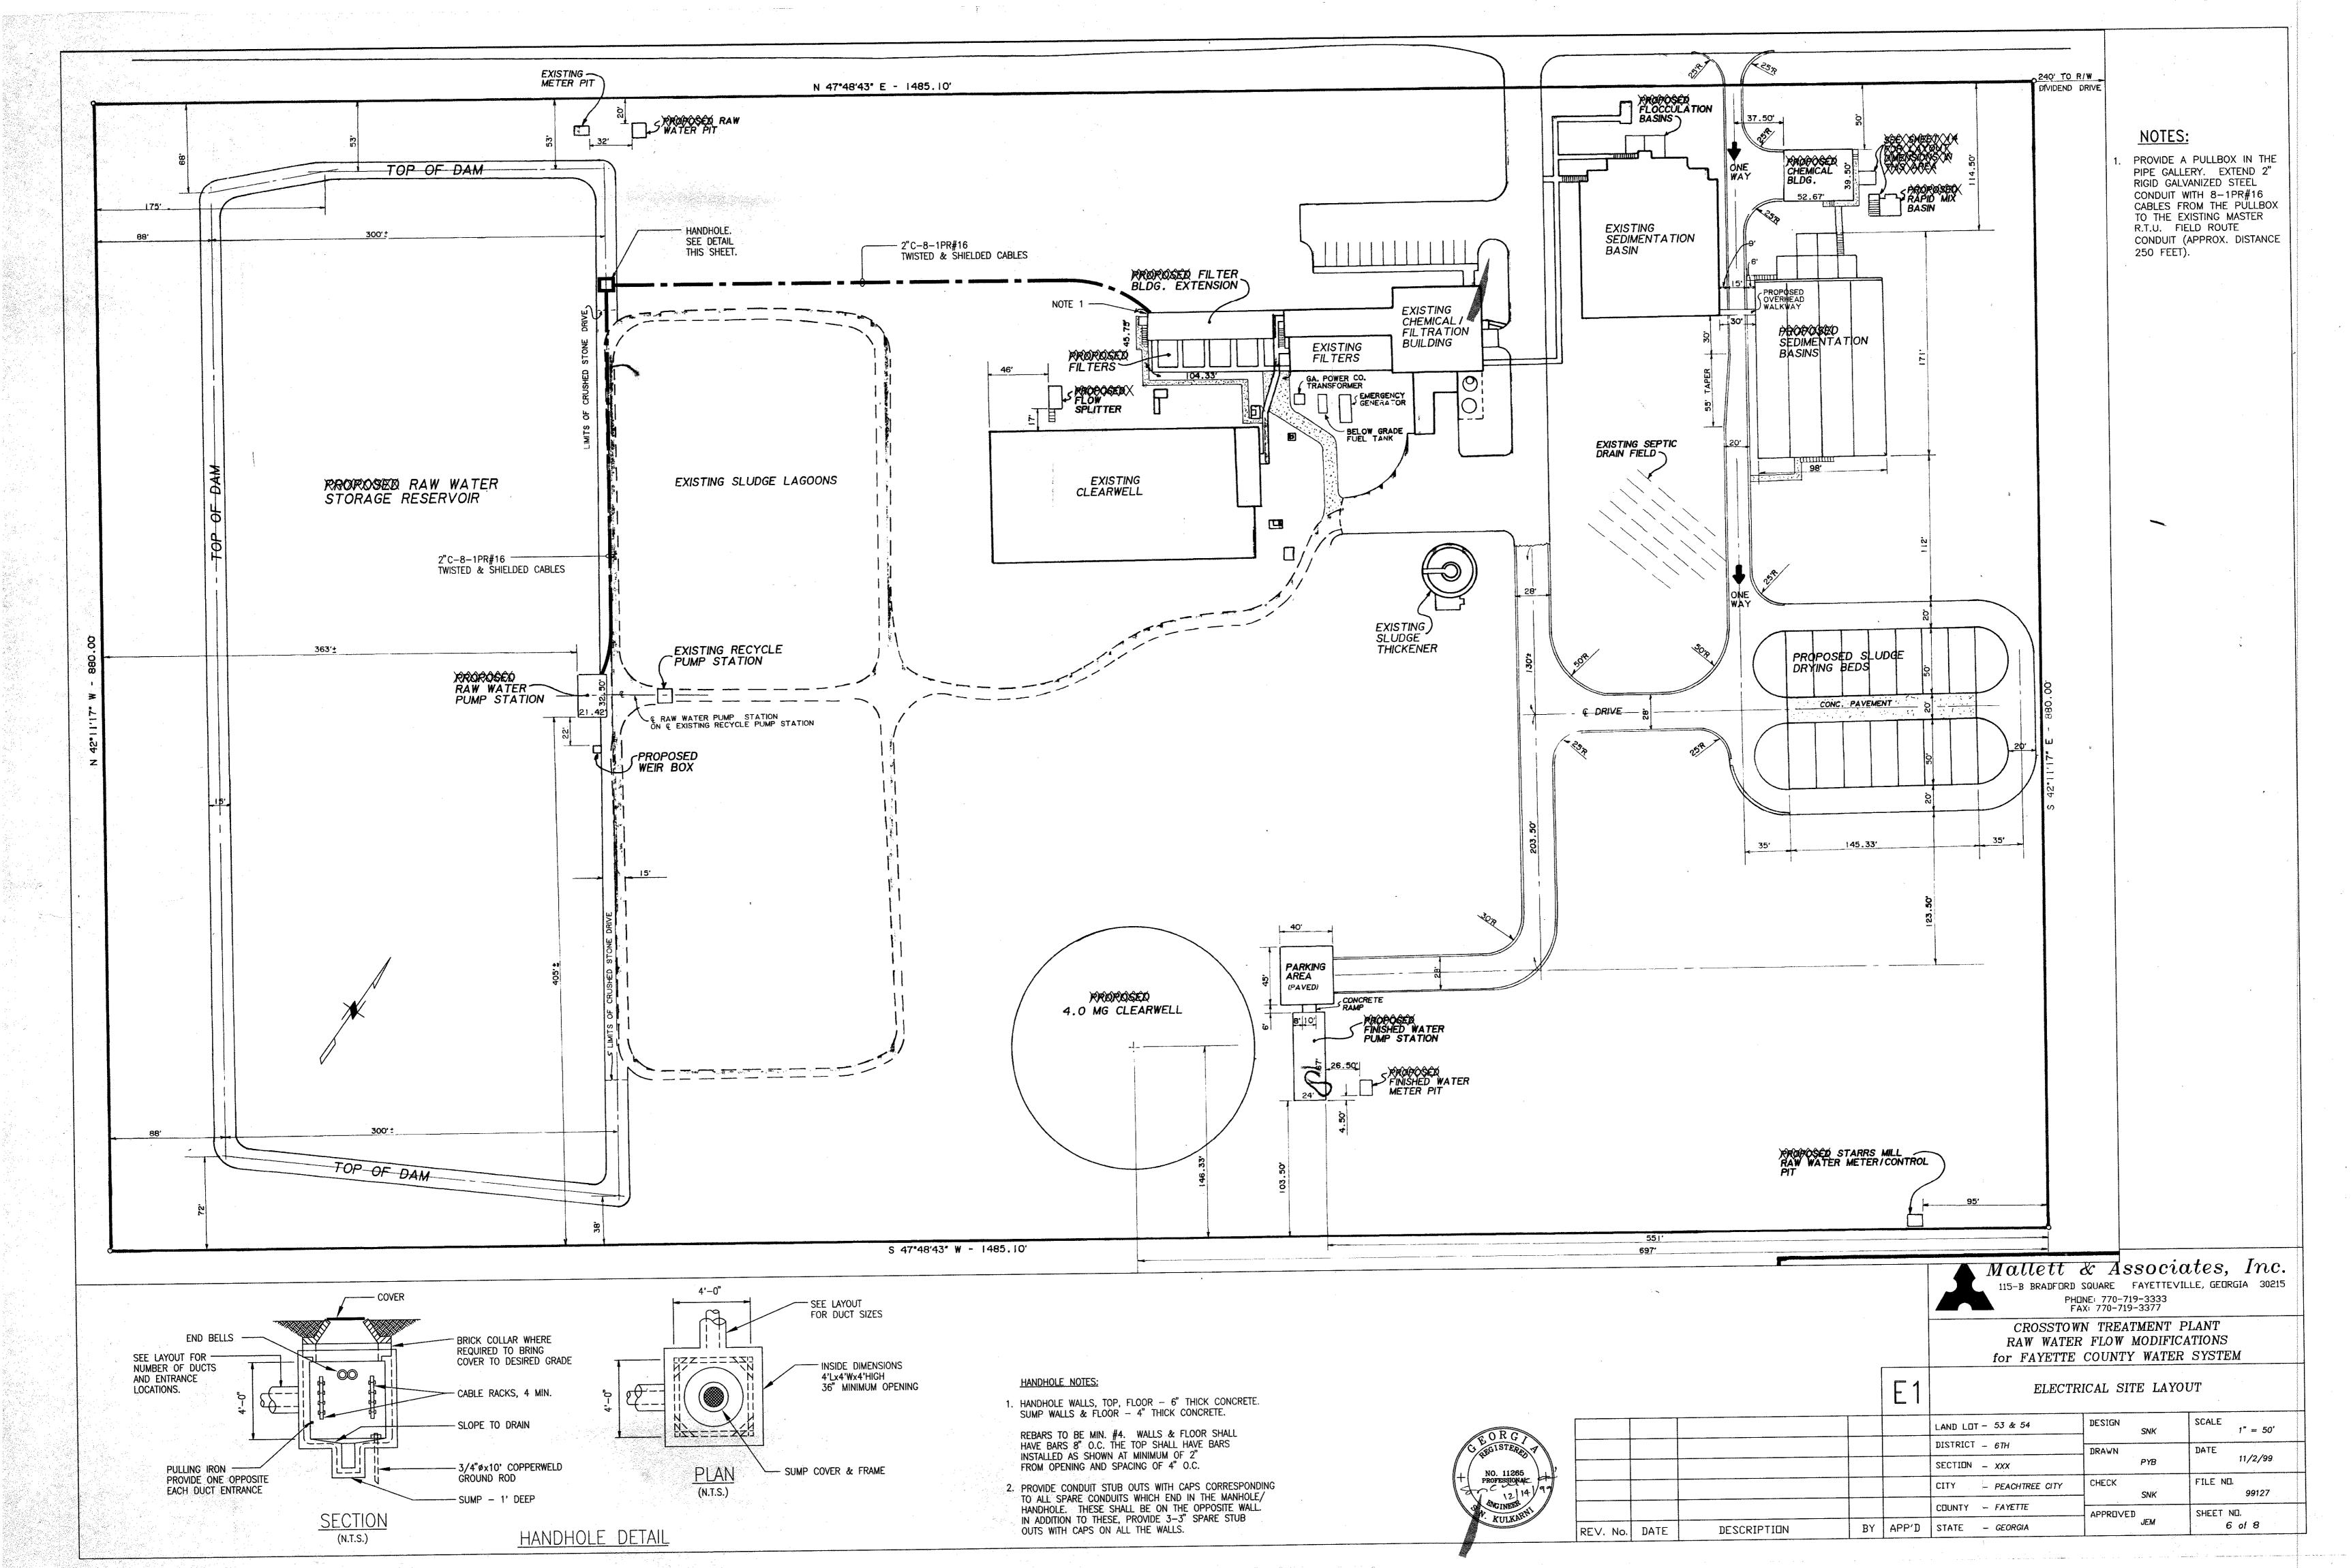

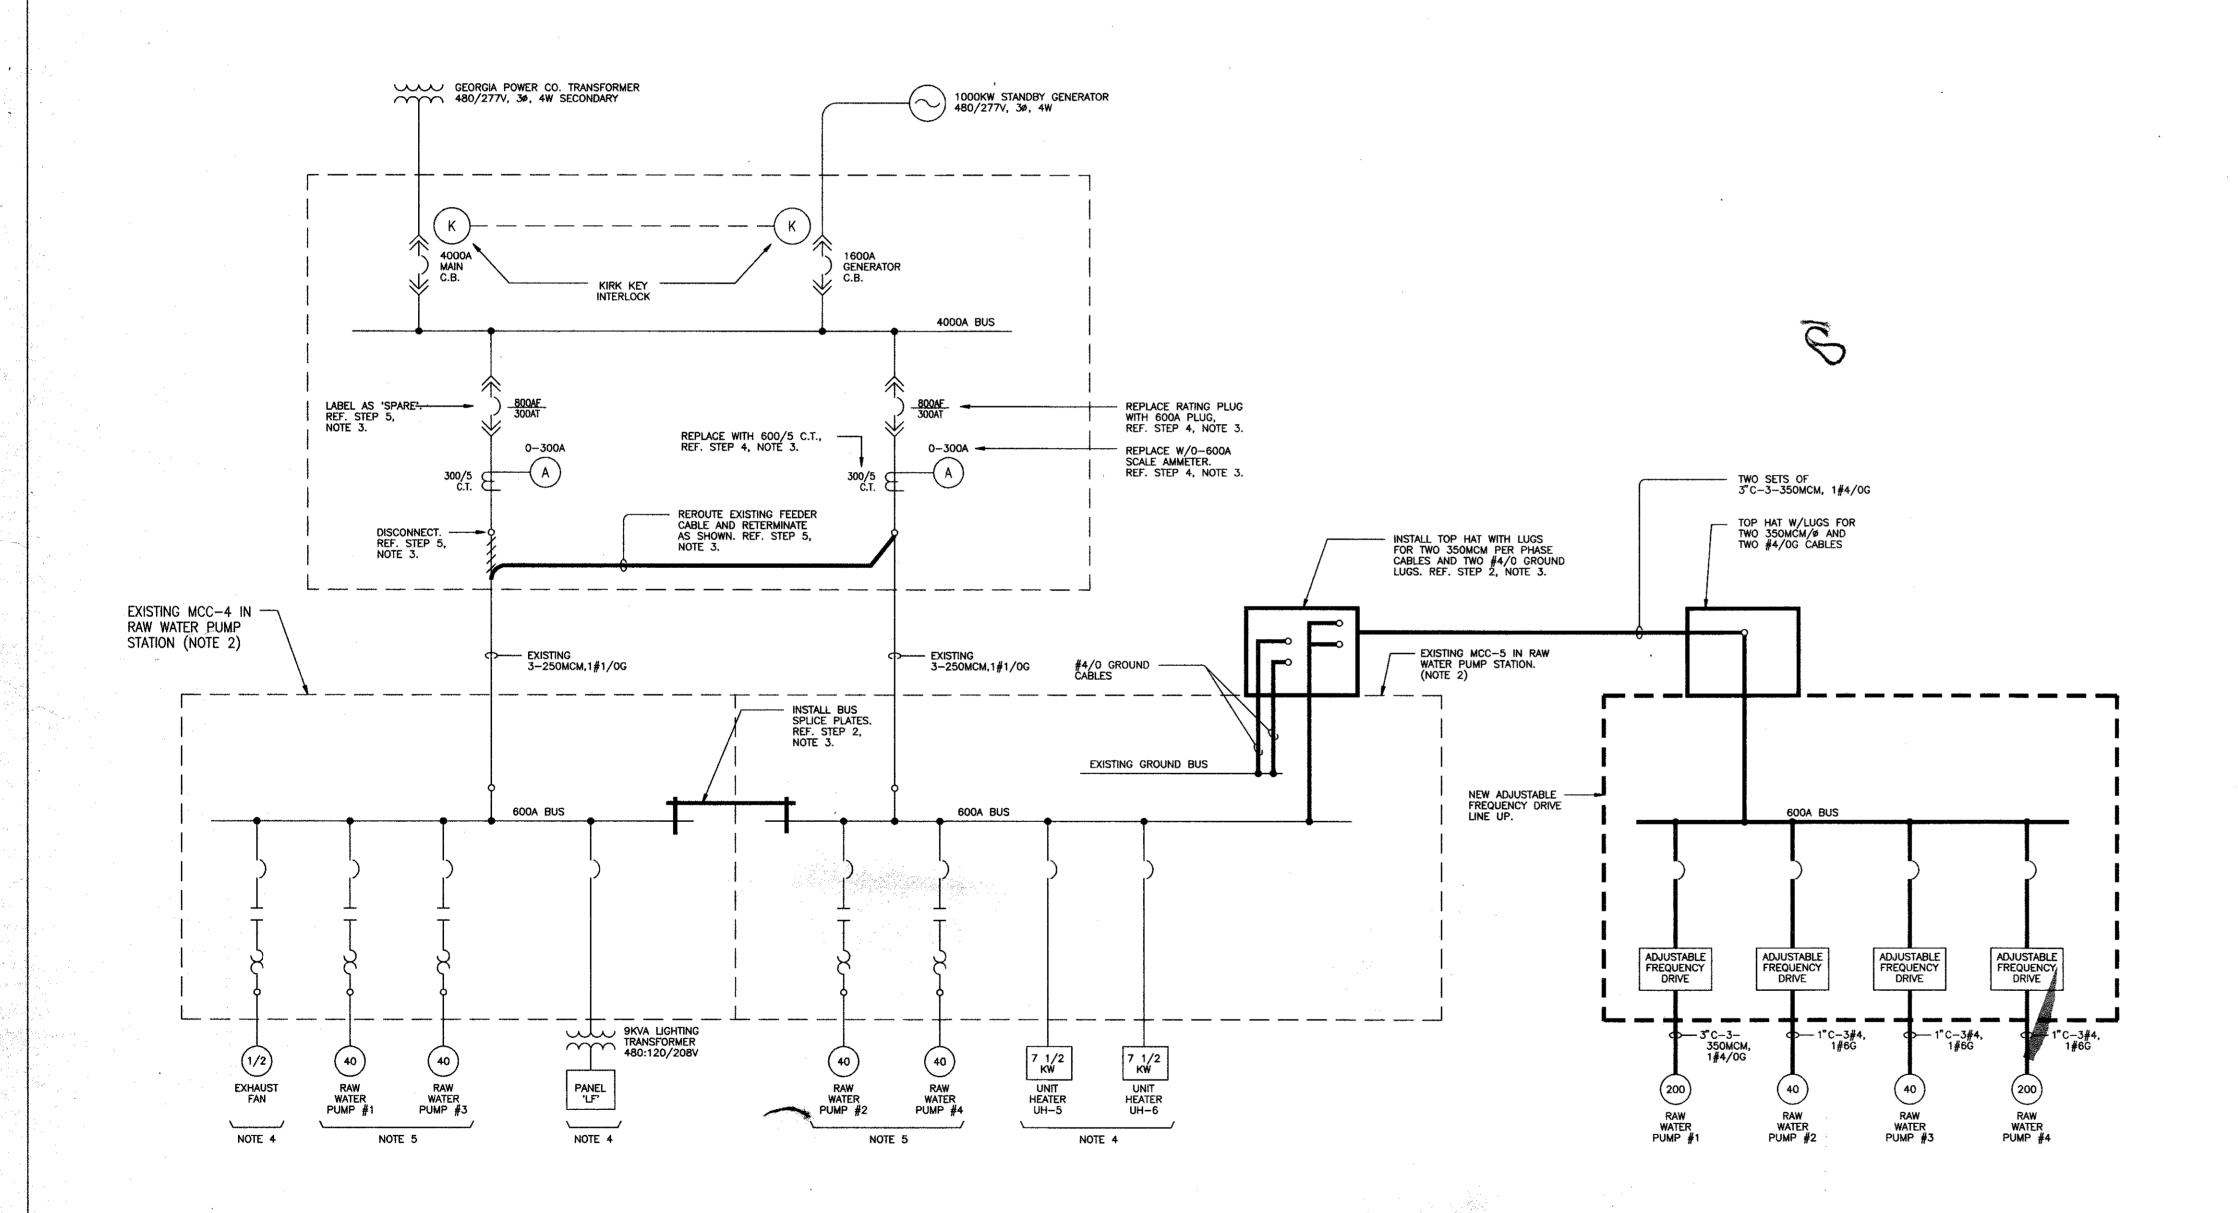

PARTIAL SINGLE LINE DIAGRAM (NOTE 1)

NOTES.

	NOTES	<u>S:</u>		
١.		ING EQUIPMENT AND CABLES ARE SHOWN IN LIGHT HE REQUIRED MODIFICATIONS ARE SHOWN IN HEAVY		LEGEND UNDERGROUND DUCT BANK
2.	EXISTING (G.E. SHO CENTERS (G.E. REQ	MAIN SWITCHGEAR IS GENERAL ELECTRIC TYPE AKD-8 P ORDER NO. 919663). EXISTING MOTOR CONTROL MCC-4 AND MCC-5 ARE GENERAL ELECTRIC TYPE 8000 PUISITION NO. 35197982 — ITEM 1 AND ITEM 2	,	ELECTRICAL HANDHOLE
3.		STRIBUTION MODIFICATION WORK SHALL BE CARRIED OUT		CONDUIT RUN EXPOSED
	STEP 1	TEPS BELOW: TURN THE FEEDER C.B.'S FOR MCC-4 AND MCC-5 IN 'OFF' POSITION. COORDINATE THIS WITH THE OWNER.		POWER CIRCUIT BREAKER
	STEP 2	GENERAL ELECTRIC TO MAKE THE 600A BUS FOR EXISTING MCC-4 & MCC-5 CONTINUOUS. PROCURE TOP HAT WITH INDICATED LUGS, BUSBAR EXTENSION HARDWARE AND OTHER NECESSARY		MOLDED CASE CIRCUIT BREAKER MCP DENOTES MOTOR CIRCUIT PROTECTOR
	STEP 3	MATERIALS FORM GENERAL ELECTRIC AND INSTALL AS INDICATED. TURN THE FEEDER C.B. FOR MCC-4 'ON', THIS FEEDER C.B. SHALL TEMPORARILY POWER BOTH	\$.	MAGNETIC STARTER—CONTACTOR WITH THERMAL ELEMENT
	STEP 4	MCC-4 & MCC-5.	(125) (M)	MOTOR-NUMBER INSIDE INDICATES HORSEPOWER RATING ,
	STEP 5	COORDINATE WITH THE OWNER FOR POWER OUTAGE TO RAW WATER PUMP STATION. TURN THE FEEDER C.B. FOR MCC-4 'OFF'. DISCONNECT THE FEEDER CABLES FROM THIS C.B.) }{	CONTROL POWER TRANSFORMER
		AND TERMINATE ON THE MODIFIED MCC-5 C.B. PROVIDE ADDITIONAL LUGS FOR THIS CABLE TERMINATION. TURN THE MCC-5 C.B. 'ON'. THE RAW WATER PUMP STATION WILL NOW OPERATE		FUSE
		FROM THIS CIRCUIT BREAKER. LABEL THE MCC-4 C.B. AS 'SPARE'.	OL'S	OVERLOAD RELAY CIRCUIT OPENS ON OVERLOAD
		LOADS SHALL CONTINUE TO OPERATE AS BEFORE.		NORMALLY OPEN (N.O.) CONTACT
Ď.		WATER PUMPS SHALL BE TRANSFERRED TO NEW LE FREQUENCY DRIVES IN THE FOLLOWING SEQUENCE:	11	NORMALLY OPEN (N.O.) CONTACT
	b) RA c) RA	W WATER PUMP #1 W WATER PUMP #4 W WATER PUMP #2 W WATER PUMP #3	****	SELECTOR SWITCH THREE POSITION H-O-A: HAND-OFF-AUTO L-O-R: LOCAL-OFF-REMOTE

LABEL EXISTING STARTERS AS 'SPARE' AFTER ALL THE PUMPS ARE TRANSFERRED TO ADJUSTABLE FREQUENCY DRIVES.




Mallett & Associates, Inc.

115-B BRADFORD SQUARE FAYETTEVILLE, GEORGIA 30215


PHONE: 770-719-3333
FAX: 770-719-3377

CROSSTOWN TREATMENT PLANT RAW WATER FLOW MODIFICATIONS for FAYETTE COUNTY WATER SYSTEM

F2 SINGLE LINE DIAGRAM & LEGEND

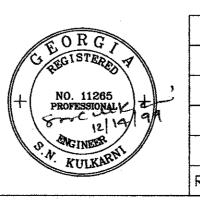


				LZ	DINGER III	VE DIAGRAM & L	EQEND .
					LAND LOT - 53 & 54	DESIGN SNK	SCALE NONE
					DISTRICT _ 6TH	DRAWN	DATE
					SECTION _ XXX	PYB	11/2/99
					CITY - PEACHTREE CITY	CHECK SNK	FILE NO. 99127
,					COUNTY - FAYETTE	APPROVED	SHEET NO.
EV, No.	DATE	DESCRIPTION	BY	APP'D	STATE - GEORGIA	JEM	7 of 8

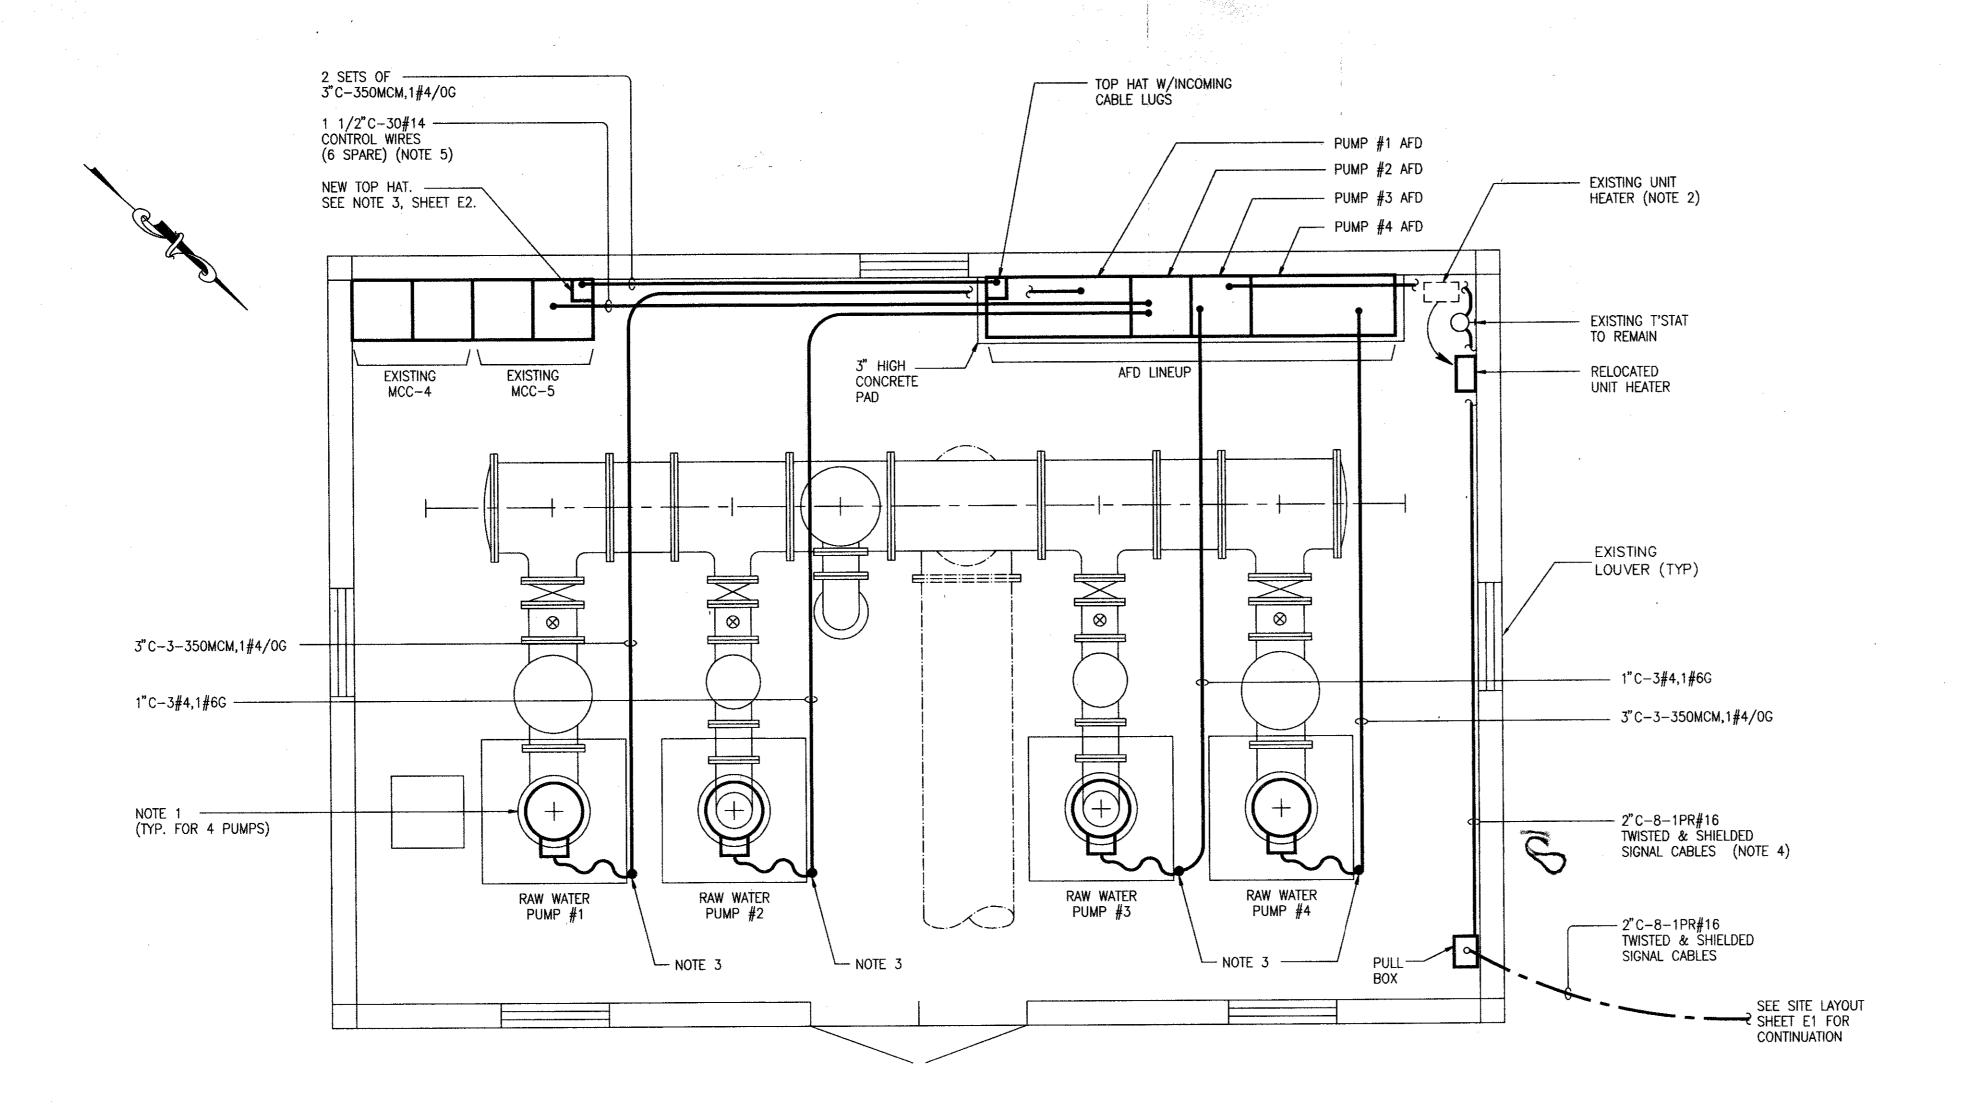

ELECTRICAL LAYOUT
RAW WATER PUMP STATION

3/8" = 1'-0"

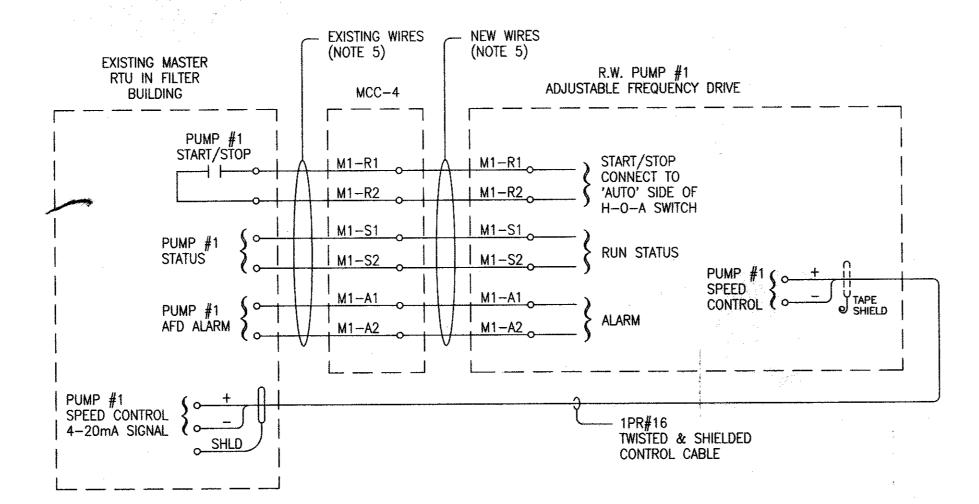

SCHEMATIC DIAGRAM
ADJUSTABLE FREQUENCY DRIVE
RAW WATER PUMP #1

TYP. FOR 4 PUMPS - CHANGE WIRE NUMBER PREFIX FROM M1 TO M2, M3 & M4)



Mallett & Associates, Inc.

115-B BRADFORD SQUARE FAYETTEVILLE, GEORGIA 30215

1. DISCONNECT AND REMOVE EXISTING CABLES FROM

MCC-4 & MCC-5 TO THE PUMP MOTORS.

2. RELOCATE EXISTING UNIT HEATER AND RECONNECT

3. DROP CONDUIT VERTICALLY DOWN AND CONNECT TO

4. LEAVE 4-1PR#16 CABLES COILED UP AND LABELED

5. EXTEND CONTROL WIRES FROM EACH EXISTING R.W. PUMP STARTER TO THE RESPECTIVE ADJUSTABLE

FREQUENCY DRIVE FOR THE FOLLOWING:

2#14 PUMP RUN STATUS TO SCADA

2#14 PUMP AFD FAIL ALARM

FREQUENCY DRIVE.

AT CEILING AND FROM PUMP CONCRETE

MOTOR WITH FLEXIBLE CONDUIT. SUPPORT CONDUIT

2#14 PUMP START/STOP CONTROL FROM SCADA

IDENTIFY EXISTING CONTROL WIRES FROM MASTER
RTU TO THE STARTERS AND RELABEL AS SHOWN ON '
TYPICAL SCHEMATIC DIAGRAM FOR THE ADJUSTABLE

POWER & T'STAT CABLES.

'SPARE' AT BÖTH THE ENDS.

FOUNDATION.

CROSSTOWN TREATMENT PLANT
RAW WATER FLOW MODIFICATIONS

for FAYETTE COUNTY WATER SYSTEM

ELECTRICAL LAYOUT & DETAILS



					LAND LOT - 53 & 54	DESIGN SNK	SCALE NONE
					DISTRICT - 6TH	DRAWN	DATE
					SECTION - XXX	PYB	11/2/99
					CITY - PEACHTREE CITY	CHECK SNK	FILE ND. 99127
					COUNTY - FAYETTE	APPROVED	SHEET NO.
REV. No.	DATE	DESCRIPTION	BY	APP'D	STATE - GEORGIA	JEM	8 of 8

Checklist of Required Documents – updated 1/13/2020

(Be Sure to Return This Checklist and the Required Documents in the order listed below)

RFQ #1763-A: Crosstown WTP Raw Water VFD

Company information – on the form provided	
Contractor Affidavit under O.C.G.A. § 13-10-91(b)(1)	
Pricing sheet	
List of exceptions, if any – on the form provided	
Copy of GA Certificate of Registration or other acceptable license or documentation	
References – on form provided	
Addenda, if Any	
COMPANY NAME:	