PROPOSED PROJECT FOR: FAYETTE COUNTY SHERIFF'S OFFICE 155 JOHNSON AVE FAYETTEVILLE, GA 30214

03.20.2024 PERMIT SET

OWNER

FAYETTE CO. SHERIFF'S DEPT. 155 JOHNSON AVENUE FAYETTEVILLE, GA 30214 PHONE: CONTACT:

ARCHITECT

57 PERRY STREET

NEWNAN, GA 30263

GENERAL NOTES (CONT.)

ABBREVIATIONS

ACT ADA AFF ALUM ASST AUTO BLDG BM BO BO BOT	ACOUSTICAL CEILING TILE AMERICAN DISABILITIES ACT ABOVE FINISH FLOOR ALUMINUM ASSISTANT AUTOMATIC BUILDING BEAM BOTTOM OF BOTTOM OF TRUSS	ELEC ELEV EOS EQ EW EXIST EXP EXP JT	EACH ELECTRIC (AL) ELEVATION EDGE OF SLAB EQUAL EACH WAY EXISTING EXPOSED EXPANSION JC EXTERIOR
CL CLG COL CONC CONF CONF CORR CMU	CONTROL JOIST CENTERLINE CEILING CLEAR COLUMN CONCRETE CONFERENCE CONTINUOUS CORRIDOR CONCRETE MASONRY UNIT	FD FE FEC FFE FLR FRP FRT FOB GA	FIRE DEPARTM FLOOR DRAIN FIRE EXTINGUIS FIRE EXTINGUIS FINISH FLOOR FLOOR FIBERGLASS RE FIRE RETARDEN FACE OF BRIC GAUGE GAUGE GALVANIZED
obl dia dim ds dwg	DOUBLE DIAMETER DIMENSION DOWNSPOUT DRAWING	GC	GALVANIZED GENERAL CON GYPSUM WALI

GENERAL NOTES

THE GC SHALL BE RESPONSIBLE FOR FIELD VERIFYING ALL DIMENSIONS AND ONDITIONS OF CONTRACT DOCUMENTS PRIOR TO ORDERING ALL MATERIALS AND PROCEEDING WITH THE WORK. THE GC IS TO NOTIFY THE ARCHITECT OF ALL DISCREPANCIES, AND QUESTIONS AND OBTAIN REQUIRED CLARIFICAITON PRIOR TO PROCEEDING WITH THE 20. WORK

DO NOT SCALE THE DRAWINGS. DIMENSIONS GOVERN.

ALL PLUMBING CHASES ARE TO BE VENTED INTO SOFFITS WHERE POSSIBLE AND REQUIRED WHERE UNVENTED SOFFITS ARE INDICATED, REFER TO ELEVATIONS FOR LOCATIONS.

GC SHALL PROVIDE AND INSTALL EQUIPMENT AND/OR APPLIANCES SPECIFIED UNLESS OTHERWISE NOTED. GC SHALL PROVIDE INSTALLATION OF OWNER FURNISHED EQUIPMENT AND/OR APPLIANCES WHERE DESIGNATED. GC TO VERIFY WITH OWNER ALL PLUMBING AND ELEC. REQUIREMENTS FOR OWNER FURNISHED EQUIPMENT AND/OR APPLIANCES.

GC TO UNDERCUT DOORS AS REQUIRED FOR FLOOR FINISHES, BUT NO MORE THAN CODE ALLOWS FOR RATING REQUIREMENTS. VERIFY ALL UNDERCUT LOCATION WITH ANY 26. CONTRACTOR IS RESPONSIBLE FOR OBTAINING ANY OTHER RE NOTED REQUIREMENTS. VERIFY ALL UNDERCUT LOCATION WITH ANY NOTED REQUIREMENTS | STRUCTURAL, ELECTRICAL, MECHANICAL, PLUMBING, AND/OR CIVIL PER MECHANICAL DRAWINGS.

PROVIDE BRACING ABOVE GLAZED OPENING FRAMES, CEILING HEIGHT PARTITIONS 27. PARTITIONS ARE DIMENSIONED TO FACE OF WALL UNLESS NO WHEN LONG UNBRACED LENGTHS OCCUR AND AT ALL DOORS AND GLAZED OPENING JAMBS AND MULLIONS IN ACCORDANCE WITH MANUFACTURES SPECIFICATIONS.

FLOOR TOLERANCE: IN LAYING OUT AND DETAILING THE WORK TO BE COMPLETED, CONSIDERATION SHALL BE GIVEN TO VARIATIONS IN THE FLOOR LEVELNESS RESULTING FROM CONTRUCTION QUALITY AND LIVE/ DEAD LOADS IMPOSED ON THE STRUCTURE. FIELD VERIFICATIONS SHALL BE MADE OF CONDITIONS TO VERIFY CONSTRUCTION TOLERANCES. 29. THE DRAWINGS ILLUSTRATE GENERAL WORK SCOPE REQUIREM ALIGNMENT OF DOOR HEADS AND OTHER HORIZONTAL ELEMENTS SHALL BE MAINTAINED AT | ELABORATE ON INSTALLATION TECHNIQUES. WORK PERFORMED SHAL A CONSTANT LEVEL AND SHALL NOT FOLLOW VARIATIONS IN FLOOR PLANE.

ALL WOOD USED AS STUDS, BLOCKING, OR BRACING SHALL BE FIRE TREATED AS REQUIRED BY CODE. GC IS RESPONSIBLE FOR PROVIDING ALL NECESSARY BLOCKING TO ACCOMMODATE INTERIOR FINISHES AND EQUIPMENT AS DESCRIBED IN THE DOCUMENTS.

"TYPICAL" MEANS THE REFERENCED DETAIL SHALL APPLY FOR ALL SIMILAR CONDITIONS UNLESS NOTED OTHERWISE.

ALL HEIGHTS FOR HANDICAP ELEMENTS ARE TO BE IN ACCORDNACE WITH THE ADA 32. SPRINKLER AND ALARM MODIFICATIONS TO BE REVIEWED AN FOR MAKING FACILITIES ACCESSIBLE AND USABLE FOR PHYSICALLY HANDICAPPED PEOPLE. | CITY OF NEWNAN FIRE MARSHAL. THE GC IS RESPONSIBLE FOR COORDINATION AND PROPER INSTALLATION OF ALL RELATED ELEMENTS.

FURNISH ACCESS PANELS IN WALLS AND NON-ACCESSIBLE TYPE CEILINGS WHERE SERVICE OR ADJUSTMENT TO MECHANICAL, PLUMBING, AND ELECTRICAL EQUIPMENT MAY BE REQUIRED. ACCESS PANELS SHALL BE EQUAL IN FIRE RATING TO SURFACE IN WHICH THEY OCCUR. REFER TO CONSULTANT DRAWINGS FOR ANY SPECIFIC REQUIREMENTS. FINAL LOCATIONS OF PANELS NOT SHOWN ON ARCHITECTURAL CEILING PLANS SHALL BE APPROVED BY THE ARCHITECT.

12. PROVIDE CONTROL JOINTS IN GYPSUM WALL BOARD SURFACES AS REQUIRED BY MANUFACTURERS SPECIFICATIONS.

13. ALL EXTERIOR LUMBER EXPOSED TO MOISTURE SHALL BE PRESSURE TREATED, UNLESS OTHERWISE SPECIFIED ON PLANS.

14. THE CONTRACTOR IS RESPONSIBLE FOR ALL MECHANICAL AND ELECTRICAL ITEMS INDICATED ON ALL CONSTRUCTION DOCUMENTS. ALL ITEMS INDICATED ON ANY DRAWING ARE TO BE INCLUDED AS A COMPLETE SYSTEM.

15. WHERE ELECTRICAL, MECHANICAL, OR OTHER WALL MOUNTED DEVICES OCCUR AT THE SAME LOCATION BUT AT DIFFERENT HEIGHTS, THEY SHALL BE CENTERED ABOVE EACH OTHER.

16. OWNER HAS FINAL APROVAL OF BUILDING MATERIALS, FINISH CHOICES, FIXTURE, AND APPLIANCE CHOICES.

17. CONTRACTOR WILL BE RESPONSIBLE FOR ACQUIRING AND FOLLOWING MANUFACTURERS SPECIFICATIONS FOR ALL EQUIPMENT, MATERIALS, AND CONSTRUCTION SYSTEMS.


CONTRACTOR WILL BE RESPONSIBLE FOR ALL TEMPORARY STRUCTURE FOR 18. WEATHERPROOFING, SECURITY, PRIVACY, AND SUPPORT.

K. A. OLDHAM DESIGN, INC.

HONE: F	NEWNAN, GA 30263 PHONE: 770.683.9170 CONTACT: KIP OLDHAM KOLDHAM@KAOD.COM		
GENERAL NOTES (C	CONT.)	ARCHITECTURAL SYM	ABOLS
19. ALL ADVERSE CONDITIONS OF MUST BE REPORTED TO THE OWNER/A	F SITE AND BUILDING DISCOVERD DURING WORK RCHITECT IMMEDIATELY.		
20. CONTRACTOR WILL BE RESPO DEBRIS	NSIBLE FOR THE DISPOSAL OF ALL CONSTRUCTION		CEILING HEIGHT, A.F.F.
21. ALL MATERIALS STORED ON SI	TE MUST BE SECURED BY CONTRACTOR.	Ŷ	
22. ALL MATERIALS STORED OFF S	ITE SHALL BE STORED IN A BONDED WAREHOUSE	↔ WALL TYPE	FINISH FLOOR ELEVATION TAG
23. CONTRACTOR MUST LOCATE CONSTRUCTION AND/OR DEMOLITIC	AND MARK ALL EXISTING UTILITIES PRIOR TO N.		HEIGHT, A.F.F.
24. ALL UTILITIES AND EQUIPMENT BEFORE JOB IS DEEMED COMPLETE.	WILL BE TESTED AND PROVED IN WORKING ORDE		ROOM NAME
25. CONSTRUCTION SHALL CONFORM STATE, AND LOCAL CODES.	A TO THE REQUIREMENTS OF GOVERNING FEDERA	AL,	ROOM ROOM TAG
	E FOR OBTAINING ANY OTHER REQUIRED CAL, PLUMBING, AND/OR CIVIL INFORMATION NO	DT PT-1 INTERIOR FINISHES TAG	
DIMENSIONS SHOWN ON DRAWINGS RESPONSIBILITY OF THE CONTRACT TO	D TO FACE OF WALL UNLESS NOTED OTHERWISE. SHALL BE CONSIDERED CRITICAL. IT SHALL BE THE NOTIFY THE ARCHITECT OF DEVIATIONS IN THE	CHANGE IN ELEVATION	SHEET NUMBER
PLACEMENT OF WORK PER THESE DIM28.SEPARATE DISSIMILAR METALS	AS DIRECTED TO PREVENT GALVANIC ACTION.	(113) DOOR TAG	DETAIL/CALL-OUT SYMBO
ELABORATE ON INSTALLATION TECHN INDUSTRY STANDARDS, BE PERFORME	ENERAL WORK SCOPE REQUIREMENTS AND DO N IQUES. WORK PERFORMED SHALL MEET OR EXCEE D IN ACCORDANCE WITH MANUFACTURES		DETAIL NUMBER
	ONFORM TO ALL APPLICABLE BUILDING CODES.	A4.01 2 INTERIOR ELEVATION	SHEET NUMBER
	t and sizing of steel members & structural vings.	DETAIL NUMBER	
32. SPRINKLER AND ALARM MODI CITY OF NEWNAN FIRE MARSHAL.	FICATIONS TO BE REVIEWED AND APPROVED BY	SHEET NUMBER	
ABBREVIATIONS			
ACT ACOUSTICAL CEILING TILE ADA AMERICAN DISABILITIES ACT AFF ABOVE FINISH FLOOR ALUM ALUMINUM ASST ASSISTANT	EA EACH ELEC ELECTRIC(AL) ELEV ELEVATION EOS EDGE OF SLAB EQ EQUAL	HCP HANDICAPPED HM HOLLOW METAL INSUL INSULATION INT INTERIOR	PLAM PLASTIC LAMINATE PL PLATE PLY PLYWOOD PT PRESSURE TREATED PTD PAINTED
AUTO AUTOMATIC BLDG BUILDING BM BEAM BO BOTTOM OF	EW EACH WAY EXIST EXISTING EXP EXPOSED EXP JT EXPANSION JOINT EXT EXTERIOR	JBE JOIST BEARING ELEVATION JT JOINT LAV LAVATORY	RD ROOF DRAIN REQ REQUIRED REINF REINFORCED RCP REFLECTED CEILING PLAN
BOT BOTTOM OF TRUSS CJ CONTROL JOIST CL CENTERLINE CLG CEILING CLR CLEAR COL COLUMN CONC CONCRETE CONF CONFERENCE	FDCFIRE DEPARTMENT CONNECTIONFDFLOOR DRAINFEFIRE EXTINGUISHERFECFIRE EXTINGUISHER CABINETFFEFINISH FLOOR ELEVATIONFLRFLOORFRPFIBERGLASS REINFORCED PANEL	MAX MAXIMUM MECH MECHANICAL MFR MANUFACTURER MIN MINIMUM MTL METAL NA NOT APPLICABLE NFWH NON-FREEZE WALL HYDRANT	RO ROUGH OPENING SAB SOUND ATTENUATION BATTS SCW SOLID CORE WOOD SIM SIMILAR SOG SLAB ON GRADE STN STAIN STRUCT STRUCTURAL
CONT CONTINUOUS CORR CORRIDOR CMU CONCRETE MASONRY UNIT	FRT FIRE RETARDENT TREATED FOB FACE OF BRICK	NEWH NON-FREEZE WALL HTDRANT NIC NOT IN CONTRACT NOM NOMINAL NTS NOT TO SCALE	TO TOP OF TYP TYPICAL
DBL DOUBLE DIA DIAMETER	GA GAUGE GALV GALVANIZED GC GENERAL CONTRACTOR GWB GYPSUM WALL BOARD	OC ON CENTER OPP OPPOSITE	UNO UNLESS NOTED OTHERWISE
DIM DIMENSION DS DOWNSPOUT DWG DRAWING	GTT SOINT WALL BOARD	OPT OPTION(AL) ORD OVERFLOW ROOF DRAIN	VIF VERIFY IN FIELD WD WOOD

WWF WELDED WIRE FABRIC

LOCATION MAP

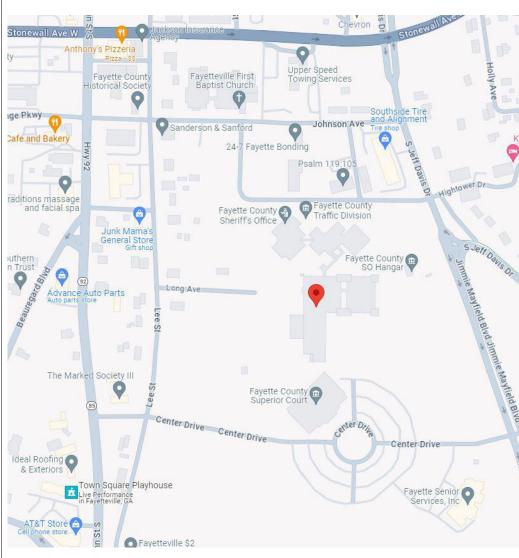

CODE SUMMARY

BUILDING DEPARTMENT FAYETTE COUNTY BUILDING DEPARTMENT 140 STONEWALL AVE W. FAYETTEVILLE GA, 30214

APPLICABLE CODES AND REGULATIONS

BUILDING MECHANICAL PLUMBING ELECTRICAL FIRE GAS ENERGY	2018 INTERNATIONAL BUILDING CODE W/ GA AMENDMENTS 2018 INTERNATIONAL MECHANICAL CODE W/ GA AMENDMENTS 2018 INTERNATIONAL PLUMBING CODE W/ GA AMENDMENTS 2020 NATIONAL ELECTRICAL CODE W/ GA AMENDMENTS 2018 INTERNATIONAL FIRE CODE W/ GA AMENDMENTS 2018 INTERNATIONAL FUEL GAS CODE W/ GA AMENDMENTS 2015 INTERNATIONAL ENERGY CONSERVATION CODE W/ GA AMEND
	2018 NFPA 101: LIFE SAFETY CODE 2014 GEORGIANS WITH DISABILITES ACT 2010 ANSI 117.1 AMERICANS WITH DISABILITES ACT

OCCUPANCY CLASSIFICATION OCCUPANCY GROUPS: [NFPA 101 & IBC 2018]

LSC: BUSINESS IBC: BUSINESS

CONSTRUCTION CLASSIFICATION CONSTRUCTION TYPE: IIIB SPRINKLED [IBC TABLE 601]

FIRE RESISTANCE RATING - TYPE IIIB (IBC TABLE 601)

STRUCTURAL FRAME:	0 HOUR(S)
BEARING WALLS - EXTERIOR:	2 HOUR(S)
BEARING WALLS - INTERIOR:	0 HOUR(S)
FLOOR CONSTRUCTION:	0 HOUR(S)
ROOF CONSTRUCTION:	0 HOUR(S)

ALLOWABLE HEIGHT

HEIGHT ALLOWED [IBC TABLE 504.3]:	75'- 0''
HEIGHT PROVIDED:	UNCHANGED

ALLOWABLE AREA

AREA ALLOWED [IBC TABLE 506.2]:	76,000 SF
AREA PROVIDED:	22,950 SF

BUILDING OCCUPANT SUMMARY

OCCUPANT LOAD [NFPA 7.3.1.2]:

AREA: 22,950 SF OCCUPANCY BUSINESS @ 150 SF/PERSON (GROSS) OCCUPANT LOAD: 153 PEOF

EGRESS REQUIREMENTS		
EGRESS WIDTH FACTOR [NFPA 7.3.3.1]:	LEVEL COMPONENTS =	= 0.2"/ PERSON
	EGRESS WIDTH REQUR EGRESS WIDTH PROVID	•
MAXIMUM TRAVEL DISTANCE [NFPA 38.2.6.3]:		REQUIRED: 30 PROVIDED: 1
COMMON PATH OF EGRESS TRAVEL [NFPA 38.]	2.5.3.1]:	REQUIRED: 10 PROVIDED: 30
DEAD END CORRIDOR [NFPA 7.5.1.5]:		REQUIRED: 50 PROVIDED: 0'
NUMBER OF EXITS:		EXITS REQUIRI EXITS PROVID
MINIMUM EXIT SEPARATION DISTANCE [NFPA 7	7.5.1.3.2]:	72'-0"

PLUMBING FIXTURE REQUIREMENTS (PER IBC TABLE 2902.1) PLUMBING FIXTURE- BUSINESS OCCUPANCY

PLUMBING FIXTURE- BUSINESS OCCUPANCY							
OCCUPANT LOAD: 153 PEOPLE	MEN (50%- 77)		WOMEN (50%- 77)				
	W/C	LAV.	W/C	LAV.	DRINKING FOUNTAIN	SERVIO	
REQUIRED	3	2	3	2	1	1	
PROVIDED	5	3	5	3	2	1	

S1.01 S S1.02 S LSP1.01 L AD1.01 E AD1.01 E A1.03 F A2.01 E A3.02 N A3.10 S A4.01 F A4.02 F A4.01 F A6.01 E A8.02 S E1 E CREATING F A8.03 S E1 E CREATING F A5.03 S E1 E SPRIN CREATING THE GENER WILL INCLU	SHEET NAME	S S S S S S S S S S S S S S S S S S S	DEV.	ADDING A WE ARE C CE FROM TH IG THESE IN G BULLETP REA. FYING THE MODIFICA	SET	RAL	ICH		57 PERRY NEWNAN, TELEPHON FAX: (770) E-MAIL: in WEBSITE: W	, GEORGIA 30263 NE: (770) 683-9170) 683- 9171 Ifo@kaod.com www.kaod.com
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ſ	<u>ME</u>	TAL STUDS AN	ID JOISTS (COLD	FORM FRAMING	6) CONTINUED:		
	10.	MEMBER		THICKNESS	(MILS)		
		S (STUD) T (TRACK)		33 33			
	11.					GE (33 TO 43 MILS) SHAL S) SHALL BE 50 KSI.	L BE 33 KSI. MINIMUM YIELD
	12.	DESIGN OR R	ECOGNIZED DES G SCREWS UNLI	SIGN STANDARD.	ALL SCREWS SHA	PLIANCE WITH ASTM C15 LL BE NON-CORROSIVE INGS (DO NOT USE STAI	
	13.			TENERS (PAF) SH NED SLABS TO E		. DIAMETER POWDER AG	CTUATED FASTENERS.
	14.			ED NO CLOSER REWS SHALL BE		R UNLESS NOTED OTHE	RWISE ON DRAWINGS.
	15.			ED TO SUPPORT		WS OR PINS AT 16" O.C.	MAX. STUDS OR JOISTS
	16.	ALL BRIDGING		FINUOUS FOR FU	LL LENGTH OF WA	LL OR PROPERLY SPLIC	ED WITH AN APPROVED
	17.	PROVIDE FUL	L DEPTH BLOCK	ING OR OTHER N	IEANS OF RESTRA	INT AT JOIST BEARING S	SUPPORTS.
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	Consulting Structural Engineers	JOB NO.:	224021	SCALE:	3/4" = 1'-0"	- n-n
	3528 Habersham at Northlake Tucker, Georgia 30084 Phone: (770) 270-9484	DATE:	03/25/2024	BY:	Author	
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CONCRETE: CODE: AMERICAN CONCRETE INSTITUTE (ACI) 318 (LATEST ADDITION)

- CONCRETE SHALL HAVE A 28-DAY COMPRESSIVE STRENGTH IN ACCORDANCE WITH THE FOLLOWING: 3000 PSI FOOTINGS & SLABS ON GRADE
- ALL CONCRETE SHALL HAVE A DENSITY OF 145 PCF UNLESS NOTED OTHERWISE.
- CONCRETE SHALL BE ENTRAINED AS REQUIRED TO CONFORM TO DURABILITY REQUIREMENTS OF ACI 318.
- CONTRACTOR SHALL SUBMIT CONCRETE MIX DESIGNS FOR ALL UNIQUE CONCRETE APPLICATIONS FOR REVIEW WELL IN ADVANCE OF CONCRETE PLACEMENT. CONCRETE MIX DESIGN SHALL BE CERTIFIED BY AN ENGINEER REGISTERED IN THE PROJECT STATE. MIX DESIGN TEST DATA SHALL COMPLY WITH ACI 318 AND SHALL INCLUDE (AT A MINIMUM) AVERAGE 28 DAY STRENGTH, NUMBER OF SAMPLES, AND STANDARD DEVIATION (IF APPLICABLE). TEST RESULTS SHALL NOT BE MORE THAN 24 MONTHS OLD AT TIME OF SUBMITTAL.
- REINFORCING SHALL CONFORM TO ASTM A615, GR60, UNLESS NOTED OTHERWISE.
- ALL REINFORCING SHALL BE DETAILED, FABRICATED AND PLACED IN ACCORDANCE WITH THE LATEST ADDITION OF THE ACI DETAILING MANUAL.
- ALL MIXING, TRANSPORTING, PLACING AND CURING OF CONCRETE SHALL BE DONE IN ACCORDANCE WITH THE RECOMMENDATIONS OF THE AMERICAN CONCRETE INSTITUTE.
- PROVIDE STANDARD BAR CHAIRS WITH PROTECTIVE TIPS AND SPACERS AT 5'-0" CENTERS FOR ALL SLABS AND BEAMS ABOVE GRADE. PROVIDE 3" X 6" X 20 GAGE SHEET METAL BAR CHAIRS AT 4'-0" MAXIMUM CENTERS EACH WAY FOR ALL TOP REINFORCING FOR SLABS-ON-GRADE.
- 0. SUBMIT REINFORCING PLACEMENT AND DETAIL (SHOP) DRAWINGS FOR REVIEW. NO REINFORCING BARS SHALL BE INSTALLED UNTIL THE SHOP DRAWINGS HAVE BEEN REVIEWED AND RETURNED.
- . PRODUCTS AND MATERIALS:
- A. TYPE I/II PORTLAND CEMENT SHALL CONFORM TO ASTM-C150. B. AGGREGATES SHALL CONFORM TO ASTM C-33.
- C. REINFORCING BARS SHALL CONFORM TO ASTM A-615 (GRADE 60).
- D. FORMING SHALL BE OF WOOD, STEEL, OR FIBERGLASS OF SATISFACTORY QUALITY AND CONDITION. E. NO ADMIXTURES SHALL BE ADDED TO THE CONCRETE UNLESS APPROVED BY THE ENGINEER. F. NON-SHRINK GROUT SHALL BE READY TO USE NON-METALLIC AGGREGATE AND DEVELOP A 7-DAY COMPRESSIVE STRENGTH OF 5000 PSI.
- 2. ALL REINFORCING SHALL BE SUPPORTED IN FORMS SPACED WITH NECESSARY ACCESSORIES AND SHALL BE SECURELY WIRED TOGETHER IN ACCORDANCE WITH LATEST ADDITION OF THE CRSI "MANUAL OF STANDARD PRACTICE".
- 13. MINIMUM CONCRETE COVER (UNLESS NOTED OTHERWISE) SHALL BE: CONCRETE CAST AGAINST AND PERMANENTLY EXPOSED TO EARTH....... 3 INCHES CONCRETE EXPOSED TO EARTH OR WEATHER: #5 BARS AND SMALLER... 1-1/2 INCHES
- 4. SCHEDULED OR DETAILED REINFORCING STEEL SHALL NOT BE TACK WELDED FOR ANY REASON. WELDED REINFORCING STEEL SPLICES ARE NOT PERMITTED WITHOUT ENGINEER'S APPROVAL. WHERE WELDING IS APPROVED IT SHALL CONFORM TO AWS D1.4 STRUCTURAL WELDING CODE - REINFORCING STEEL.
- 5. BASE PLATES, ANCHOR BOLTS, SUPPORT ANGLES, ETC. BELOW GRADE SHALL BE COVERED WITH A MI 4" OF CONCRETE.
- 6. PROVIDE A MINIMUM OF 3" COVER FOR ANCHOR BOLTS AND LOCATE HORIZONTAL REINFORCEMENT TO THE OUTSIDE FOR ANCHOR BOLT CONTAINMENT, UNLESS NOTED OTHERWISE.

7. PLACEMENT OF CONCRETE, COLD WEATHER AND HOT WEATHER PRECAUTIONS, MATERIAL AND PROPORTIONING REQUIREMENTS, REBAR COVER AND DETAILING SHALL CONFORM TO THE REQUIREMENTS OF THE ACI 318.

Willett Company Consulting Structural Engineers	PROJECT: DESCRIPTION: JOB NO.:	CONCRETE N		OFFICE 3/4" = 1'-0"	SK-3
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1.	 CONTRACTOR SHALL SUBMIT THE FOLLOWING AS A COMPLETE PACKAGE, DELAYED SUBMITTAL: A. SHOP DRAWINGS SEALED BY AN ENGINEER LICENSED IN THE PROJECT STATE INCLUDING PLACEMENT PLANS, ELEVATIONS, AND SECTIONS. a. INCLUDE LAYOUT, SPACINGS, SIZES, THICKNESSES, AND TYPES OF COLD-FORMED STEEL FRAMING; FABRICATION; AND FASTENING AND ANCHORAGE DETAILS, INCLUDING MECHANICAL FASTENERS. b. INDICATE REINFORCING CHANNELS, OPENING FRAMING, SUPPLEMENTAL FRAMING, STRAPPING, BRACING, BRIDGING, SPLICES, ACCESSORIES, CONNECTION DETAILS, AND ATTACHMENT TO ADJOINING
	 WORK. B. CALCULATIONS SEALED BY AN ENGINEER LICENSED IN THE PROJECT STATE FOR REVIEW BY ENGINEER OF RECORD. C. PRODUCT CATALOG WITH PROPERTIES OF ALL FRAMING AND ACCESSORIES.
2.	DESIGN, FABRICATION, AND ERECTION SHALL CONFORM TO LATEST ADDITION OF THE AISI "NORTH AMERICAN SPECIFICATIONS FOR THE DESIGN OF COLD FORMED STEEL STRUCTURAL MEMBERS" INCLUDING SUBSEQUENT SUPPLEMENTS. ALL METAL STUDS SHALL BE GALVANIZED.
3.	ALL STUDS, JOISTS, TRACK, BRIDGING, END CLOSURES AND ACCESSORIES SHALL BE FORMED FROM STEEL THAT CORRESPONDS TO THE REQUIREMENTS OF AISI "SPECIFICATION FOR THE DESIGN OF COLD-FORMED STEEL STRUCTURAL MEMBERS" UNLESS NOTED OTHERWISE.
4.	ALL PRODUCTS TO BE MANUFACTURED BY A CURRENT MEMBER OF THE STEEL MANUFACTURERS ASSOCIATION.
5.	CONTRACTOR SHALL FURNISH COMPLETE FABRICATION AND ERECTION DRAWINGS PREPARED BY AN ENGINEER LICENSED IN THE PROJECT STATE FOR APPROVAL BY THE STRUCTURAL ENGINEER PRIOR TO THE COMMENCEMENT OF FABRICATION. INCLUDE PLACING DRAWINGS FOR FRAMING MEMBERS SHOWING SIZE AND GAGE DESIGNATIONS, NUMBER, TYPE, LOCATION AND SPACING. INDICATE SUPPLEMENTAL TRAPPING, BRACES, SPLICES, BRIDGING, ACCESSORIES AND DETAILS REQUIRED FOR PROPER INSTALLATION.
6.	 DELEGATED DESIGN: ENGAGE A QUALIFIED PROFESSIONAL ENGINEER TO DESIGN COLD-FORMED STEEL FRAMING CAPABLE OF WITHSTANDING DESIGN LOADS WITHIN LIMITS AND CONDITIONS INDICATED BELOW. A. DESIGN LOADS: AS INDICATED ON DRAWINGS OR COMPUTED USING DESIGN CRITERIA PROVIDED. B. DESIGN FRAMING SYSTEMS TO WITHSTAND DESIGN LOADS WITHOUT DEFLECTIONS GREATER THAN THE FOLLOWING: a. EXTERIOR WALL FRAMING: HORIZONTAL DEFLECTION OF 1/240 OF THE WALL HEIGHT, 1/360 OF THE WALL HEIGHT FOR SIMULATED STONE WALLS OR STUCCO FINISHES, 1/600 FOR BRICK OR STONE VENEER WALLS. b. ROOF RAFTER FRAMING: VERTICAL DEFLECTION OF 1/360 OF THE HORIZONTALLY PROJECTED SPAN FOR LIVE LOADS AND 1/240 FOR TOTAL LOADS OF THE SPAN. c. CEILING JOIST FRAMING: VERTICAL DEFLECTION OF 1/360 OF THE SPAN FOR LIVE LOADS AND 1/240 FOR TOTAL LOADS OF THE SPAN.
7.	DESIGN FRAMING SYSTEMS TO PROVIDE FOR MOVEMENT OF FRAMING MEMBERS LOCATED OUTSIDE THE INSULATED BUILDING ENVELOPE WITHOUT DAMAGE OR OVERSTRESSING, SHEATHING FAILURE, CONNECTION FAILURE, UNDUE STRAIN ON FASTENERS AND ANCHORS, OR OTHER DETRIMENTAL EFFECTS WHEN SUBJECT TO A MAXIMUM AMBIENT TEMPERATURE CHANGE OF 120 DEG F (67 DEG C).
8.	PROVIDE TEMPORARY SHORES, GUYS, BRACES, AND OTHER SUPPORTS DURING ERECTION TO KEEP STRUCTURAL FRAMING SECURE, PLUMB, AND IN ALIGNMENT AGAINST TEMPORARY CONSTRUCTION LOADS EQUAL IN INTENSITY TO DESIGN LOADS. REMOVE TEMPORARY SUPPORTS WHEN PERMANENT STRUCTURAL FRAMING CONNECTIONS AND BRACING ARE IN PLACE, UNLESS OTHERWISE INDICATED.
9.	DESIGN FRAMING SYSTEM TO MAINTAIN CLEARANCES AT OPENINGS, TO ALLOW FOR CONSTRUCTION TOLERANCES, AND TO ACCOMMODATE LIVE LOAD DEFLECTION OF PRIMARY BUILDING STRUCTURE AS FOLLOWS (INCLUDES SLIP TRACKS, SLIP CLIPS, & BYPASS CLIPS): A. UPWARD AND DOWNWARD MOVEMENT EQUALS 1/240 TIMES THE SPAN OF THE UPPER BOUND PRIMARY STRUCTURAL ELEMENT (BEAM).
	Willett PROJECT: FAYETTE SHERIFF'S OFFICE
	DESCRIPTION: COLD-FORM STEEL NOTES JOB NO.: 224021 SCALE: 3/4" = 1'-0"
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FOUNDATIONS:

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- FOUNDATION DESIGN IS BASED ON ASSUMED STABLE, NON-EXPANSIVE SOIL WITH AN ALLOWABLE NET BEARING PRESSURE OF 2.0 KSF UNDER FULL SERVICE LIVE AND DEAD LOAD WITH A MAXIMUM OF 1/2 INCH OF DIFFERENTIAL SETTLEMENT. A GEOTECHNICAL ENGINEER LICENSED IN THE PROJECT STATE SHALL DETERMINE THE VALIDITY OF THESE ASSUMPTIONS AND THE ENGINEER OF RECORD SHALL BE NOTIFIED IF THE SOIL DOES NOT MEET ANY OF THE MINIMUM CRITERIA.
- THE FOOTINGS HAVE BEEN POSITIONED AT THE ESTIMATED ELEVATION WHICH WILL PROVIDE SUITABLE BEARING. HOWEVER, IF ADEQUATE BEARING CAPACITY IS NON-EXISTENT AT THESE ESTIMATED ELEVATIONS, THE FOOTING SHALL BE LOWERED TO AN ELEVATION WHERE THE PRESCRIBED SAFE BEARING CAPACITY EXISTS.
- FOOTINGS MAY BE CAST INTO AN EARTH-FORMED TRENCH IF SOIL CONDITIONS PERMIT.

DATE: 03/25/2024 BY: Author

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- EXCAVATION FOR FOOTINGS SHALL BE CUT TO ACCURATE SIZES AND DIMENSIONS, AS SHOWN ON PLANS, ALL SOIL BELOW SLABS AND FOOTINGS SHALL BE PROPERLY COMPACTED AND SUBGRADE BROUGHT TO A REASONABLE TRUE AND LEVEL PLANE BEFORE PLACING CONCRETE.
- IN THE AREA OF CONSTRUCTION, EXISTING ORGANIC MATERIAL, UNSUITABLE SOIL, ABANDONED FOOTINGS AND ANY OTHER EXISTING UNSUITABLE MATERIALS AS IDENTIFIED BY THE GEOTECHNICAL INVESTIGATION REPORT SHALL BE REMOVED. ANY FILL MATERIAL REQUIRED AT THE SITE SHALL CONFORM TO THE REQUIREMENTS SET FORTH IN THE GEOTECHNICAL INVESTIGATION REPORT AND APPROVED BY A SOILS ENGINEER. ROCKS OF A DIAMETER GREATER THAN THAT SPECIFIED SHALL BE EXCLUDED FROM STRUCTURAL FILL LIFTS. FILL MATERIAL SHALL BE PLACED IN LOOSE LIFTS ACCORDING TO THE GEOTECHNICAL ENGINEER'S RECOMMENDATIONS AND COMPACTED TO A SPECIFIED MAXIMUM DRY DENSITY AS DETERMINED BY THE MODIFIED COMPACTION TEST (ASTM D1557). ADEQUATE FIELD DENSITY AND MOISTURE CONTENT TESTS SHALL BE PERFORMED TO ENSURE COMPLIANCE.
- FOOTING CONCRETE SHALL BE CAST ON THE SAME DAY THE EXCAVATION IS APPROVED. IF THE BEARING SURFACE IS ALLOWED TO BECOME DISTURBED IN ANY WAY, IT SHALL BE REWORKED TO THE SATISFACTION OF THE TESTING ENGINEER PRIOR TO CASTING THE CONCRETE.
- ALL BEARING MATERIAL SHALL BE INSPECTED BY THE INDEPENDENT TESTING AGENCY PRIOR TO CONCRETE PLACEMENT. THE INDEPENDENT TESTING AGENCY SHALL BE THE SOLE JUDGE AS TO THE SUITABILITY OF THE BEARING MATERIAL. FOOTING ELEVATIONS SHALL BE ADJUSTED AS REQUIRED.
- WHEN UNSATISFACTORY OR UNCONTROLLED FILL IS ENCOUNTERED, REMOVAL AND REPLACEMENT WILL BE PAID ON THE BASIS OF UNIT PRICES SET FORTH IN THE CONTRACT.
- BACKFILL AROUND AND OVER FOUNDATION ELEMENTS SHALL BE OF SUITABLE MATERIAL, INSPECTED AND PRE-APPROVED BY THE TESTING ENGINEER.
- 10. MAXIMUM SLOPE OF EXCAVATIONS SHALL BE IDENTIFIED IN THE GEOTECHNICAL INVESTIGATION REPORT AND ADHERED TO. PROVIDE SHORING AND PROTECTION FOR EXCAVATION BANKS AS NECESSARY TO PRESERVE SAFETY AND PREVENT CAVING.
- 11. ALL BEARING STRATA SHALL BE ADEQUATELY DRAINED BEFORE FOUNDATION CONCRETE IS PLACED.
- 12. THERE SHALL BE NO HORIZONTAL OR VERTICAL CONSTRUCTION JOINTS IN ANY FOOTING WITHOUT PRIOR WRITTEN APPROVAL FROM THE ENGINEER.

IINIMUM OF

Willett	PROJECT:	FAYETTE SHI	ERIFF'S (OFFICE	
Engineering	DESCRIPTION:	FOUNDATION NOTES			
Consulting Structural Engineers	JOB NO.:	224021	SCALE:	3/4" = 1'-0"	SK-2
3528 Habersham at Northlake Tucker, Georgia 30084 Phone: (770) 270-9484	DATE:	03/25/2024	BY:	Author	
www.WillettEngineering.com	CLIENT:	KAOD			

<u>DE</u>	DESIGN CRITERIA:								
BUILDING CODE - INTERNATIONAL BUILDING CODE 2018 WITH GEORGIA AMENDMENTS.									
1.			RY & IMPORTAN						
			ATEGORY FACTOR				IV 1.0		
			FACTOR				1.2		
			IC FACTOR				1.5		
2			LOADS:						
2.			LOADS.				12 PSF		
3.			_OADS*:				20 PSF		
	А.						THE BUILDING CODE.		
4.			ATE WIND SPEED	`			115 MPH		
			TIONALITY FACT				0.85		
	С.	EXPOS	SURE CATEGORY	/			C		
			SURE CLASSIFIC				ENCLOSED BUILDING		
	E. F.	COMP	EFFECT FACTOR ONENT AND CLA	DDING LOADS	 S		0.85		
			TIVE PRESSURE.				-63.0 PSF		
			IVE PRESSURE A				63.0 PSF ±80.0 PSF		
		1,4000	¬				100.01 01		
5.		LOADS							
			ND SNOW LOAD. ROOF SNOW LOA				5.0 PSF 5.0 PSF		
			MAL FACTOR (Ct)				1.2		
	D.	SNOW	EXPOSURE FAC	TOR (Ce)			1.0		
E. RAIN ON SNOW SURCHARGE F. UNIFORM ROOF SNOW LOAD									
G. DRIFTED SNOW LOAD				50.0 PSF					
			PROJECT:	FAYETTE SH					
		Villett eering	DESCRIPTION:	DESIGN CRI		ICE			
		npany	JOB NO.:	224021	1 1	/4" = 1	<u></u> SK-1		
	3528 Habersham at N Tucker, Georgia 3	lorthlake	DATE:	03/20/24		uthor			
	Phone: (770) 270- www.WillettEngineer	9484	CLIENT:	KAOD					

STRUCTURAL STEEL DETAILING, FABRICATION, AND ERECTION SHALL BE IN ACCORDANCE WITH THE LATEST EDITION OF THE "MANUAL OF STEEL CONSTRUCTION" OF THE AMERICAN INSTITUTE STEEL CONSTRUCTION. SHOP DRAWINGS SHALL SHOW COMPLETE WELDING INFORMATION, BOTH SHOP AND FIELD, USING AMERICAN WELDING SOCIETY SYMBOLS UNLESS OTHERWISE INDICATED OR SHOWN, BOLTED CONNECTION SHALL BE MADE USING 3/4" DIAMETER BOLTS CONFORMING TO ASTM A325 UNLESS OTHERWISE NOTED. THEY SHALL BE INSTALLED AND INSPECTED IN STRICT CONFORMANCE WITH LATEST EDITION RSCS "SPECIFICATION FOR STRUCTURAL JOINTS USING ASTM A325 OR A490 BOLTS." SPLICING OF STEEL MEMBERS UNLESS SHOWN ON THE DRAWINGS IS PROHIBITED WITHOUT WRITTEN APPROVAL OF THE ARCHITECT.

STRUCTURAL STEEL:

Willet

Engineering Čompar

28 Habersham at North Tucker, Georgia 30084 Phone: (770) 270-9484

CODE: LATEST EDITION OF THE AMERICAN INSTITUTE OF STEEL CONST STRUCTURAL STEEL BUILDINGS, ANSI/AISC 360. STEEL SHALL CONFOR	
STRUCTURAL TUBES	A500, GRADE B (Fy=46ksi)

	\dots Acco, CIABE D (I $y = +0.037$)
ANCHOR BOLTS	F1554, GRADE 36 (Fy=36ksi)
WELDING ELECTRODES	E70xx
HARDENED STEEL WASHERS	F436

NO HOLES SHALL BE CUT IN ANY STEEL ELEMENT UNLESS THEY ARE DETAILED ON THE DRAWINGS.

UNLESS OTHERWISE SHOWN ON THE DRAWINGS, THE SIZE OF WELDS SHALL NOT BE SMALLER THAN 1/4".

THE CONTRACTOR SHALL PROVIDE, AT NO ADDITIONAL COST, ALL ADDITIONAL STEEL CONNECTIONS, GUYING, ETC. REQUIRED FOR ERECTION.


OBTAIN ALL FIELD MEASUREMENTS REQUIRED FOR PROPER FABRICATION AND INSTALLATION OF WORK PRIOR TO DETAILING. PRECISE MEASUREMENTS ARE THE SOLE RESPONSIBILITY OF THE CONTRACTOR.


THE FABRICATOR SHALL BE RESPONSIBLE FOR ALL ERRORS OF DETAILING ON THE SHOP DRAWINGS, ERRORS IN FABRICATION, AND FOR THE CORRECT FITTING OF STRUCTURAL STEEL MEMBERS.

SK-4


PROJECT:	FAYETTE SHERIFF'S OFFICE			
CRIPTION:	STEEL NOTES	S		
JOB NO.:	224021	SCALE:	3/4" = 1'-0"	
DATE:	03/25/2024	BY:	Author	
	KAOD			


S7 PERRY STREET NEWNAN, GEORGIA 30263 TELEPHONE: (770) 683-9170 FAX: (770) 683-9171 E-MAIL: info@kaod.com WEBSITE: www.kaod.com
Revision Schedule Revision Number Date Description 11/27/23 CONCEPT DESIGN PHASE 3/20/24 PERMIT SET
KIPARD AN ANTICONTROL OF GEOD
This drawing is property of K.A. Oldham Design, Inc and may not be reproduced or used without the Architect's written permission. (c) 2024 FAYETTE COUNTY SHERIFF'S OFFICE 155 JOHNSON AVE FAYETTEVILLE, GA 30214 Prepared for FAYETTE COUNTY SHERIFF'S DEPT
COMMISSION NO: 2372.00 SHEET TITLE: STRUCTURAL NOTES SHEET NO: SHEET NO:

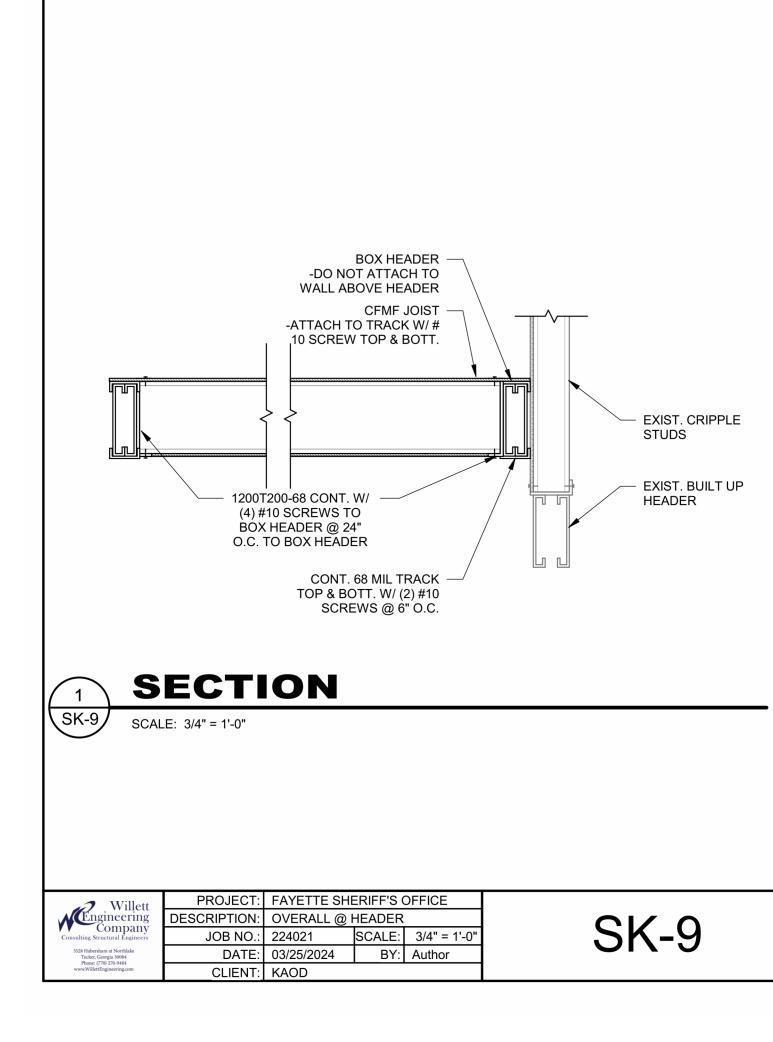


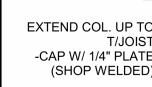


(8) #10 SCREWS EA SIDE OF COL -CAN SUBSTITUTE FOR 0.157" DIA. HILTI X-U P.A.F.

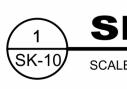

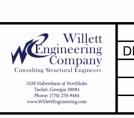

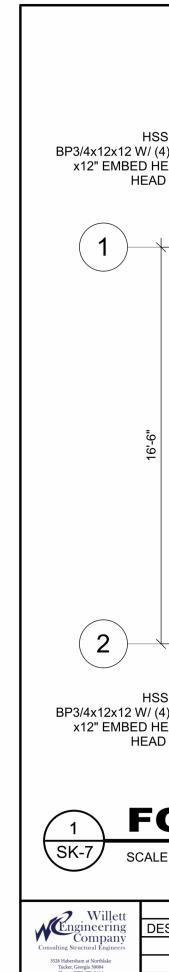

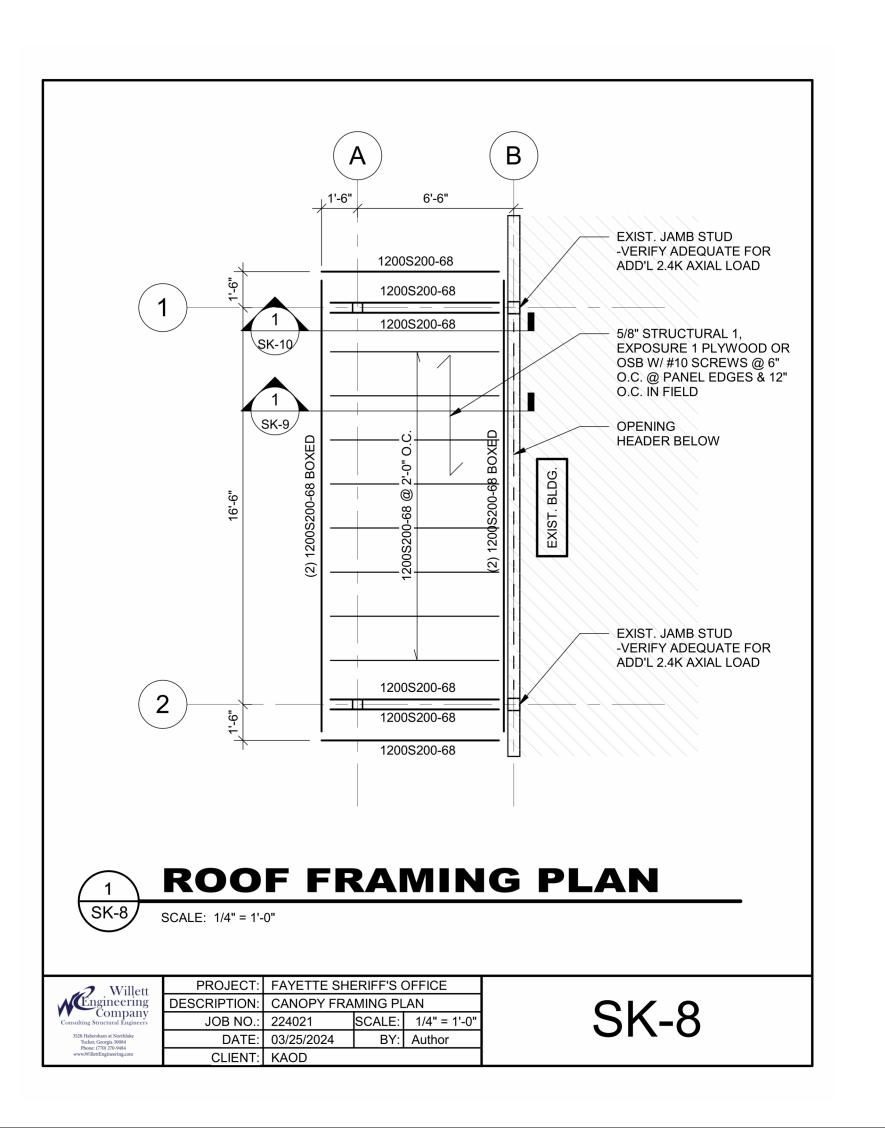

SEE PLAN U(6) #10 SCREWS EA. SIDE W(6) #10 SCREWS EA. LEG EXIST. JAMB STUDS ATTACH BOX HEADER TO JAMB STUDS W(14) #12 SCREWS (REMOVE FINISH AS RECOVE FINISH AS RECOVE AS	KAOLDHAM DESIGN, INC. S7 PERRY STREET NEWNAN, GEORGIA 30263 TELEPHONE: (770) 683-9170 FAX: (770) 683-9170 FAX: (770) 683-9171 E-MAIL: info@kaod.com WEBSITE: www.kaod.com VEBSITE: www.kaod.com Image: Note that the image of the i
INPORTATION INPORTATION FINISH AS RECOD & BLOCK SOLID FOR X-U A.F. SECTION ALE: 3/4" = 1'-0" PROJECT: FAYETTE SHERIFF'S OFFICE DESCRIPTION: OVERALL AT COLVAMB JOB NO: 224021 SCALE: 3/4" = 1'-0" DATE 03/25/2024 BY: Author CLIENT: KAOD SSSX5X3/16 (4) 3/4" DIA HEAVY HEA AD ABOLTS CLIENT: JAMB STUDS	KING OF GEOT
FTG: 4'-0"X4'-0"X16" WI (5) #5 EA. WAY (T/FTG = -1'-0") FTG: 4'-0"X4'-0"X16" W/ (5) #5 EA. WAY (T/FTG = -1'-0") EXIST. JAMB STUDS (4) 3/4" DIA. HEAVY HEX AD A.BOLTS	<text><section-header><text><text><text><text></text></text></text></text></section-header></text>
ALE: 1/4" = 1'-0" PROJECT: FAYETTE SHERIFF'S OFFICE DESCRIPTION: FOUNDATION PLAN JOB NO.: 224021 SCALE: 1/4" = 1'-0" DATE: 03/25/2024 BY: Author CLIENT: KAOD	2372.00 SHEET TITLE: STRUCTURAL DIAGRAMS SHEET NO: SHEET NO: STRUCTURAL DIAGRAMS
	ISSUED FOR CONSTRUCTION



EGRESS REQUIREMENTS

EGRESS WIDTH FACTOR (NFPA 101 TABLE 7.3.3.1): LEVEL COMPONENTS = 0.2" PER PERSON EGRESS WIDTH REQUIRED = 30.6" (36" MIN) EGRESS WIDTH PROVIDED = 72"

TRAVEL DISTANCE (NFPA 101):

COMMON PATH OF EGRESS TRAVEL (NFPA 101):

DEAD-END CORRIDOR (NFPA 101)

MINIMUM EXIT SEPARATION DISTANCE (NFPA 101):

NUMBER OF EXITS:

REQUIRED: 300'-0" PROVIDED: 112'-0" REQUIRED: 1000'-0" PROVIDED: 30'-0" REQUIRED: 50'-0" PROVIDED: 0'-0" REQUIRED: 72'-0"

EXITS REQUIRED: 2 EXITS PROVIDED: 4

LIFE SAFETY LEGEND




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Dovision	Rev	vision Schedule
Revision Number	Date	Description
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or used withou	AYET HERI 155	TE COUNTY
or used withou F. S	AYET HERI 155 FAYETT P AYET	TE COUNTY FF'S OFFICE JOHNSON AVE
or used withou F S F	AYET HERI 155 FAYETT P AYET	TECUNTY FOR COUNTY FOR COUNTY JOHNSON AVE EVILLE, GA 30214 Trepared for TECOUNTY SIFF'S DEPT
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SHEET NO:

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DEMOLITION NOTES

- DEMOLITION WORK SHOWN IS ASSUMED TO BE CORRECT BASED ON EXISTING DRAWINGS AND INSPECTIONS. REFERENCE WAS GIVEN TO SHOW AS MANY SURVEYED ITEMS AS POSSIBLE TO ASSIST THE GC IN UNDERSTANDING THE DEMOLITION SCOPE. DEMOLITION DRAWINGS ARE NOT INTENDED TO REFLECT ALL CONDITIONS. GC IS RESPONSIBLE FOR PERFORMING THE INDICATED DEMOLITION WORK EVEN IF ACTUAL CONDITIONS DIFFER FROM WORK SHOWN ON DRAWINGS.
- RELAY ALL CONFLICTS DETERMINED DURING THE COURSE OF BIDDING AND CONSTRUCTION IMMEDIATELY TO THE ARCHITECT IN WRITING.
- 3. ALL CONSTRUCTION ITEMS SHOWN DASHED AND ITEMS ATTACHED WITHIN THE CONSTRUCTION OF EACH ITEM ARE TO BE DEMOLISHED AND REMOVED FROM THE SITE.
- 4. ASBESTOS/HAZARDOUS MATERIALS: IF DURING THE COURSE OF DEMOLITION, QUESTIONS ARISE REGARDING THE POSSIBLE PRESENCE OF UNKNOWN HAZARDOUS MATERIALS, THE GC SHALL IMMEDIATELY NOTIFY THE ARCHITECT IN WRITING.
- VERIFY ALL PLUMBING INVERTS AND ALL EXISTING UTILITY LOCATIONS PRIOR TO THE START OF DEMOLITION, INCLUDING UNDERGROUND AND OVERHEAD LINES. UTILITIES MAY REQUIRE RELOCATION TO AVOID CONFLICT WITH NEW CONSTRUCTION.
- 6. ABANDON EXISTING PLUMBING BELOW FLOOR AND CAP 6" BELOW SLAB. FULLY REMOVE ANY PLUMBING IN AREAS WHERE FLOOR IS TO BE COMPLETELY REMOVED.
- ANY UTILITY SYSTEMS REQUIRED TO REMAIN ACTIVE DURING THE COURSE OF NEW WORK SHALL REMAIN ACTIVE. IF CIRCUMSTANCES REQUIRE THE TEMPORARY INTERRUPTION OF ANY UTILITIES, THE GC SHALL NOTIFY, COORDINATE, AND RECEIVE PRIOR PERMISSION BEFORE ANY SHUTDOWN OF SERVICES.
- 8. UNLESS OTHERWISE NOTED, DOORS SCHEDULED TO BE REMOVED SHALL INCLUDE THE DOOR, FRAME, AND HARDWARE.
- PROTECT ALL WALLS, CEILINGS, FLOORS, AND STRUCTURAL COMPONENTS TO REMAIN FROM DAMAGE DURING DEMOLITION. GC SHALL REPLACE ANY ITEMS DAMAGED DURING CONSTRUCTION TO A FINISH AND MATERIAL QUALITY NOT LESS THAN EXISTING ADJACENT REMAINING WORK.
- 10. PRIOR TO CUTTING, DRILLING, OR AFFECTING ANY EXISTING STRUCTURAL MEMBERS NOT INDICATED, GC SHALL SUBMIT NOTIFICATION TO THE OWNER, SPECIFYING LOCATION AND REQUESTING CONSENT TO PROCEED WITH THE CUTTING OR DRILLING.
- 11. PROVIDE TEMPORARY PROTECTION AS NECESSARY TO SEAL BUILDING FROM THE ELEMENTS AND MAINTAIN BUILDING SECURITY WHERE DEMOLITION IS INDICATED. NOTIFY THE ARCHITECT IN WRITING IF CERTAIN CONDITIONS REQUIRE EXISTING ELEMENTS TO REMAIN EXPOSED FOR LONG PERIODS OF TIME.
- 12. ALL MATERIAL SHOWN TO BE DEMOLISHED SHALL BE REMOVED FROM THE SITE AND DISPOSED OF OFF-SITE IN A TIMELY MANNER. GC SHALL NOT STOCKPILE DEMOLISHED MATERIALS ON SITE.
- 3. THE OWNER RESERVES THE RIGHT TO SALVAGE ANY ITEM WHETHER SHOWN ON DEMOLITION DRAWINGS OR NOT. AREAS TO BE DEMOLISHED SHALL BE SURVEYED BY THE OWNER AND THE OWNER SHALL SUPPLY A WRITTEN LIST OF ITEMS FOR SALVAGE NOT ALREADY SHOWN ON THE CONSTRUCTION DRAWINGS. THE GC SHALL BE RESPONSIBLE FOR THE REMOVAL, COLLECTION, AND SERRATION AS REQUIRED FOR SALVAGING, AND SHALL STORE ITEMS IN LOCATIONS AS DIRECTED BY THE OWNER.
- 14. GC IS RESPONSIBLE FOR ALL SHORING AND BRACING NECESSARY TO MAINTAIN STRUCTURAL INTEGRITY.
- 15. DEMO ANY ASSOCIATED PLUMBING, HVAC & ELECTRICAL REQUIRED TO ACCOMPLISH INTENDED FINAL PLANS.
- DURING ANY DEMO WORK TO THE ROOF AND EXTERIOR, BE CAREFUL OF EXISTING ROOF AND FLASHING, THESE WILL NOT BE REPLACED.

DEMOLITION LEGEND

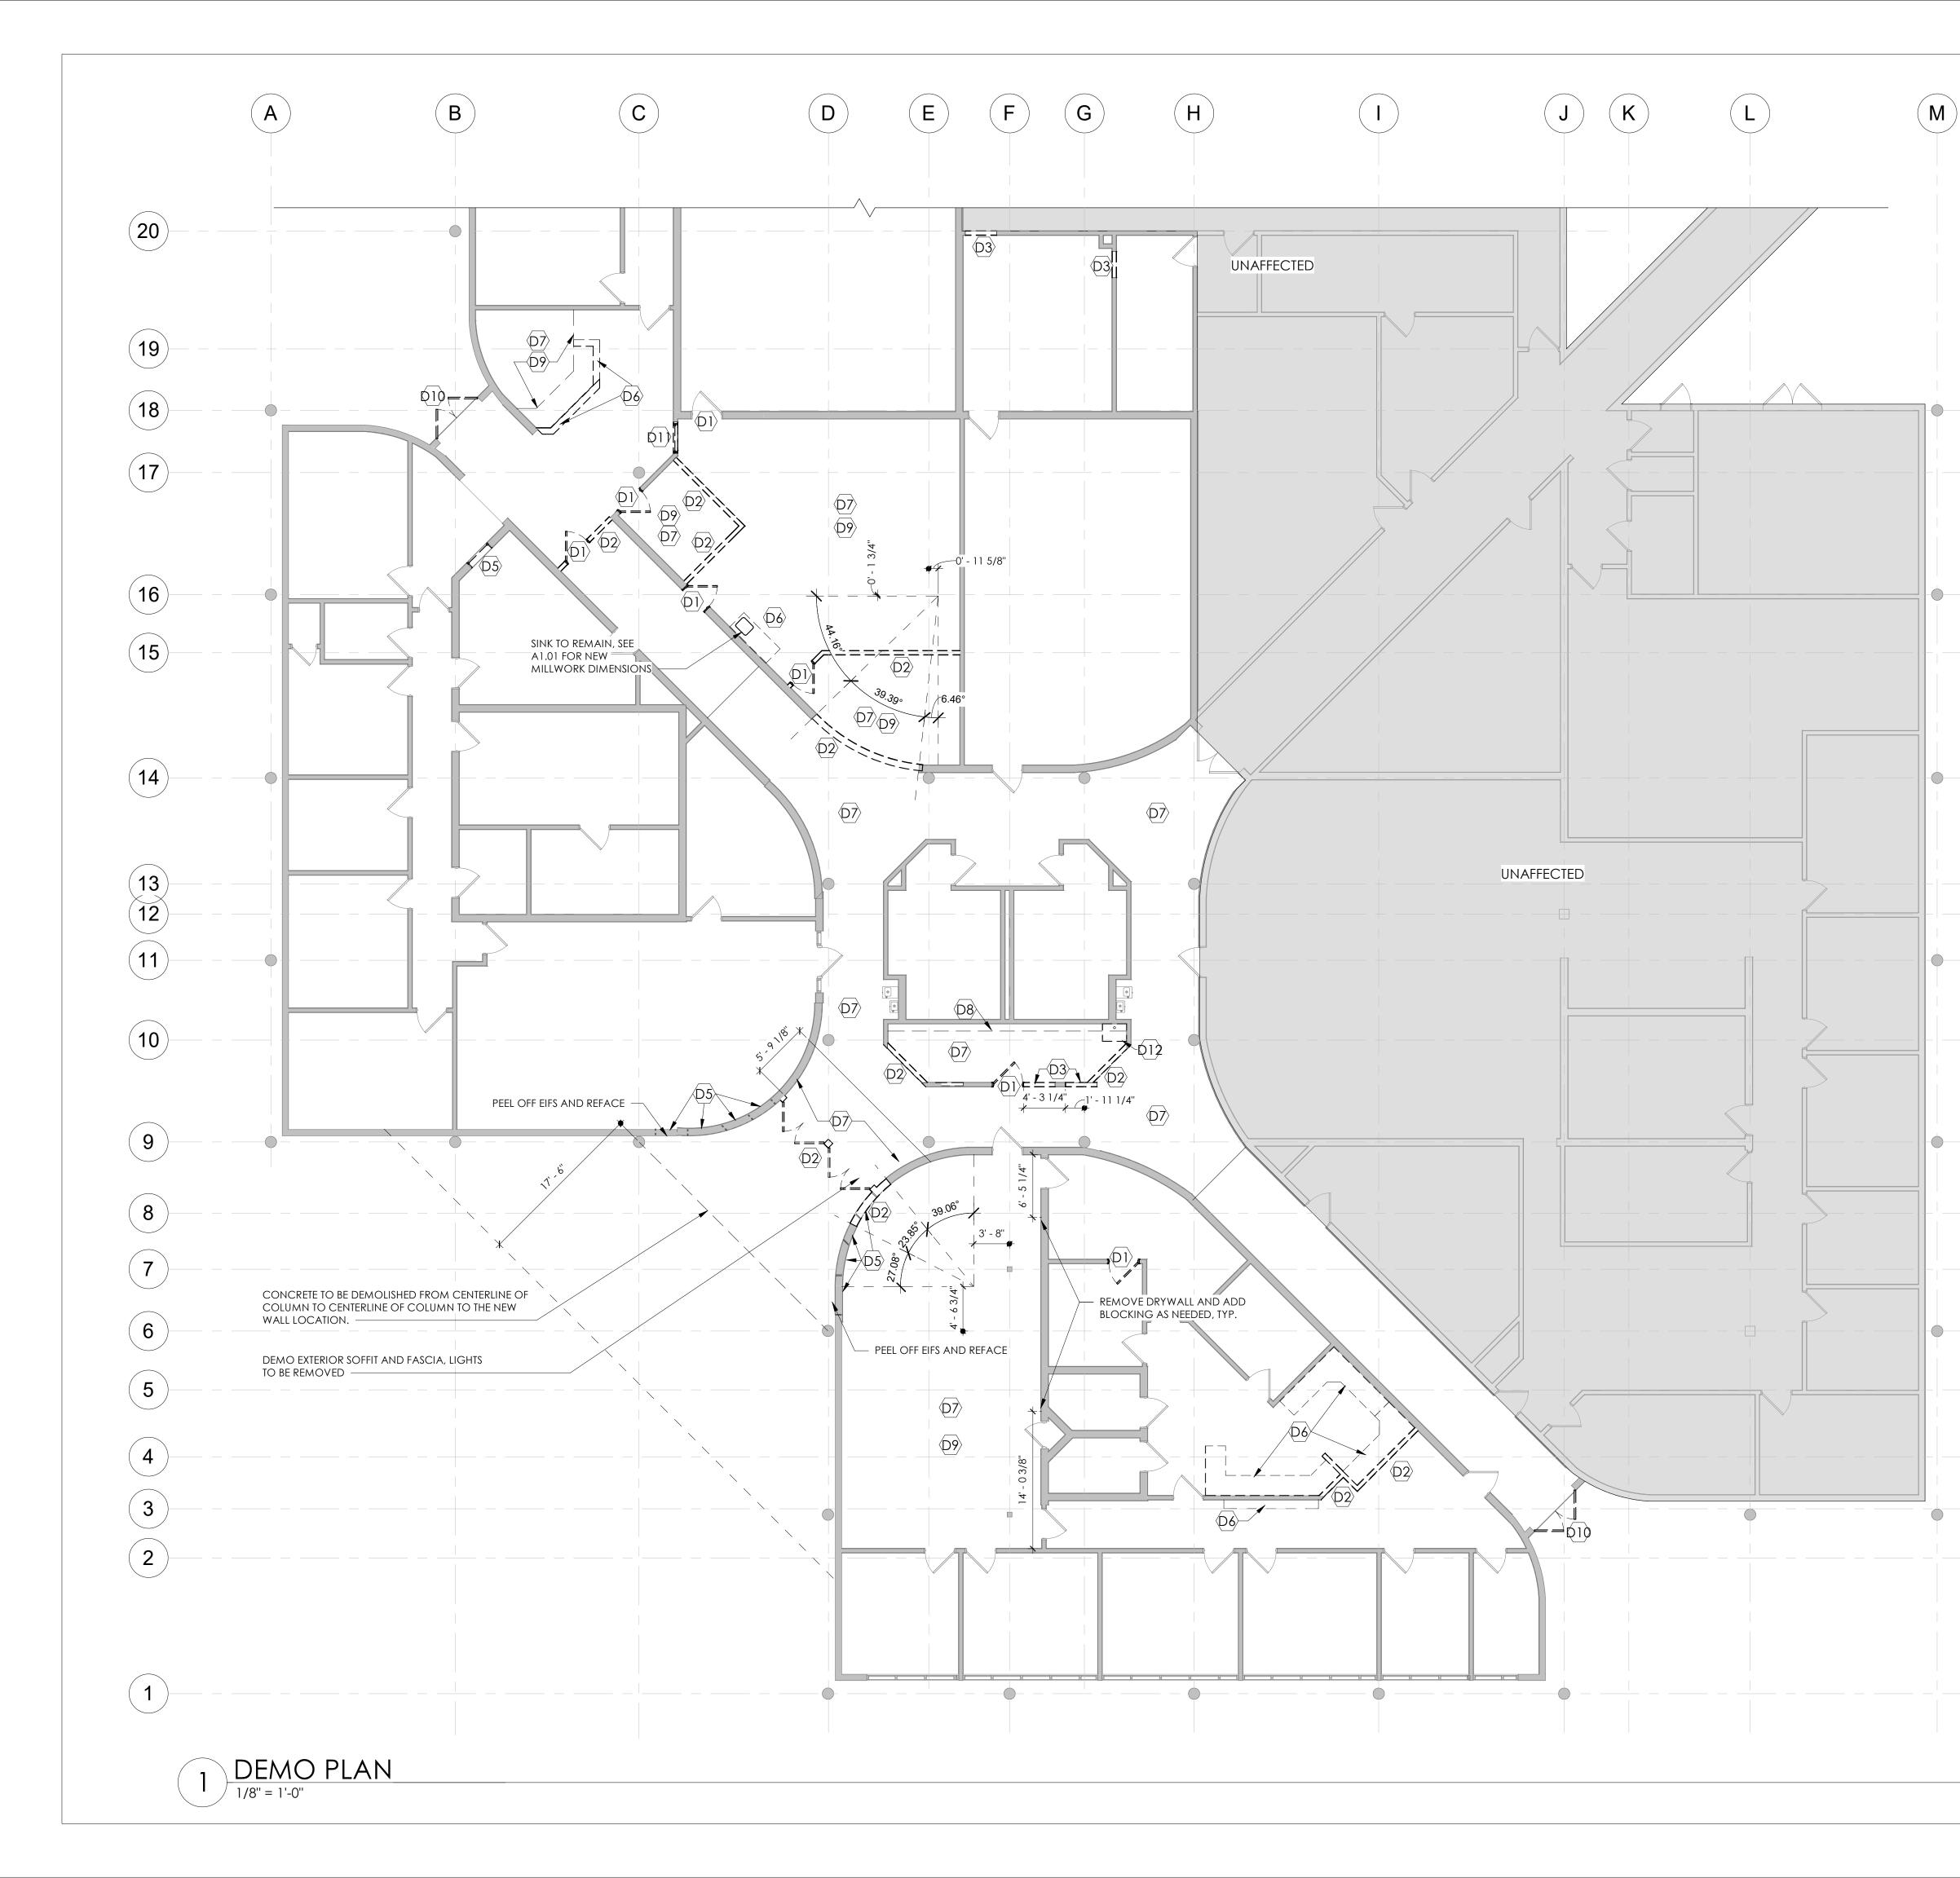EXTENTS TO BE DEMOLISHED FROM TOP OF SLAB _ __ _ TO TOP OF PARTITION. LIMIT DEMO TO PART OF _ __ _ WALL OR ELEMENT DIMENSIONS INDICATE

- (D1) EXISTING DOOR AND FRAME TO BE REMOVED
- D2 EXISTING WALL TO BE REMOVED AND PREPARED TO BE FILLED IN
- EXISTING WALL TO BE REMOVED AND PREPARE FOR
- NEW DOOR
 EXISTING WALL TO BE REMOVED AND PREPARE FOR
- NEW WINDOW
- (D5) EXISTING WINDOW TO BE REMOVED
- EXISTING MILLWORK TO BE REMOVED AND DISCARDED
- D7 EXISTING FLOOR MATERIAL TO BE REMOVED
- (D8) SLAB TO BE CUT FOR NEW PLUMBING FIXTURES
- (D9) EXISTING CEILING TO BE REMOVED
- REMOVE EXISTING DOORS AND PREPARE FOR NEW DOOR
- EXISITING WINDOW TO BE REMOVED AND PREPARE FOR NEW 3'- 0" DOOR
- PLUMBING FIXTURE TO BE REMOVED AND PREPARE FOR NEW PLUMBING FIXTURE



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Revision Schedule Revision Number Date Description 1/31/24 DESIGN DEVELOPME 3/20/24 PERMIT SET	
Number Date Description 1/31/24 DESIGN DEVELOPME 3/20/24 PERMIT SET	
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FAYETTE COUNTY	
SHERIFF'S OFFICE	
155 JOHNSON AVE FAYETTEVILLE, GA 30214	

Prepared for

FAYETTE COUNTY SHERIFF'S DEPT

COMMISSION NO:

2372.00

SHEET TITLE:

DEMO PLAN

SHEET NO:

AD1.01 ISSUED FOR CONSTRUCTION





FLOOR PLAN NOTES

REFER TO A1.01 FOR PARTITION SCHEDULE. ALL PARTITIONS ARE TYPE 'A' CONSTRUCTION OTHERWISE NOTED.

- 2. DIMENSIONS SHOWN ARE TO FACE OF STUDS. NOTED CLEAR DIMENSIONS ARE TO FINISHED FACE OF WALLS. DIMENSIONS ARE TO FINISHED FACE FOR EXISTING WALLS
- 3. DOORS NOT LOCATED BY DIMENSIONS ON PLANS SHALL BE 4" FROM FACE OF ADJOINING PARTITION TO HINGE EDGE OF DOOR OPENING. VERIFY DOORS WILL HAVE 18" CLEAR ON THE PULL SIDE AND 12" CLEAR ON THE PUSH SIDE, PER ADA REQUIREMENTS. NOTIFY ARCHITECT IF REQUIRED CLEARANCES ARE NOT AVAILABLE.
- 4. REFER TO PLUMBING DRAWINGS FOR INFORMATION OF PLUMBING FIXTURES.
- 5. CONTRACTOR TO LAYOUT ALL WALL LOCATIONS AND OPENINGS TO DISCOVER ANY CONFLICTS FOR RESOLUTION WITH THE ARCHITECT PRIOR TO STARTING WALL CONSTRUCTION. FIELD VERIFY ALL DIMENSIONS.
- PROVIDE ALL NECESSARY WOOD BLOCKING IN FRAMING LOCATIONS AT ALL WALL HUNG FURNITURE AND EQUIPMENT TO INCLUDE, BUT NOT LIMITED TO, GRAB BARS, HANDRAILS, CASEWORK, MARKER BOARDS AND ALL RESTROOM ACCESSORIES.
- 7. PROVIDE (1) FIRE EXTINGUISHER PER 3000SF OF OCCUPIABLE SPACE OR MAXIMUM 75'-0" OF TRAVEL. REFER TO PLANS FOR LOCATIONS MARKED F.E.C. FINAL LOCATIONS TO BE VERIFIED BY LOCAL FIRE INSPECTOR.
- . ALL INTERIOR WALLS TO RECEIVE SOUND BATT. INSULATION UNLESS OTHERWISE NOTED. NO INSULATION IN CEILINGS UNLESS OTHERWISE NOTED.

PARTITION LEGEND

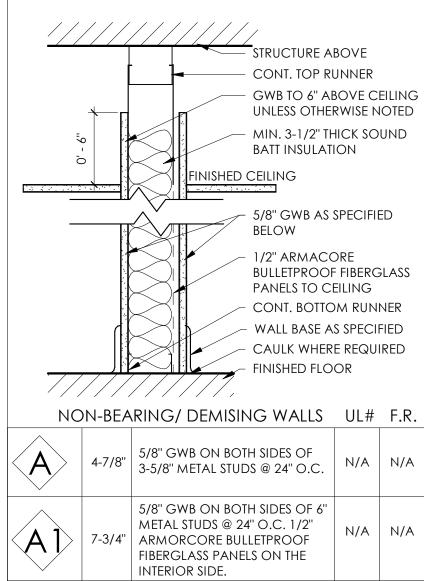

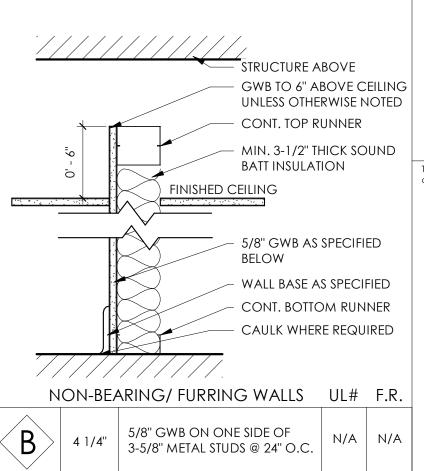



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Revision Schedule					
Revision Number	Date	Description			
	11/27/23	CONCEPT DESIGN PHASE			
	1/31/24	DESIGN DEVELOPMENT			
	3/20/24	PERMIT SET			



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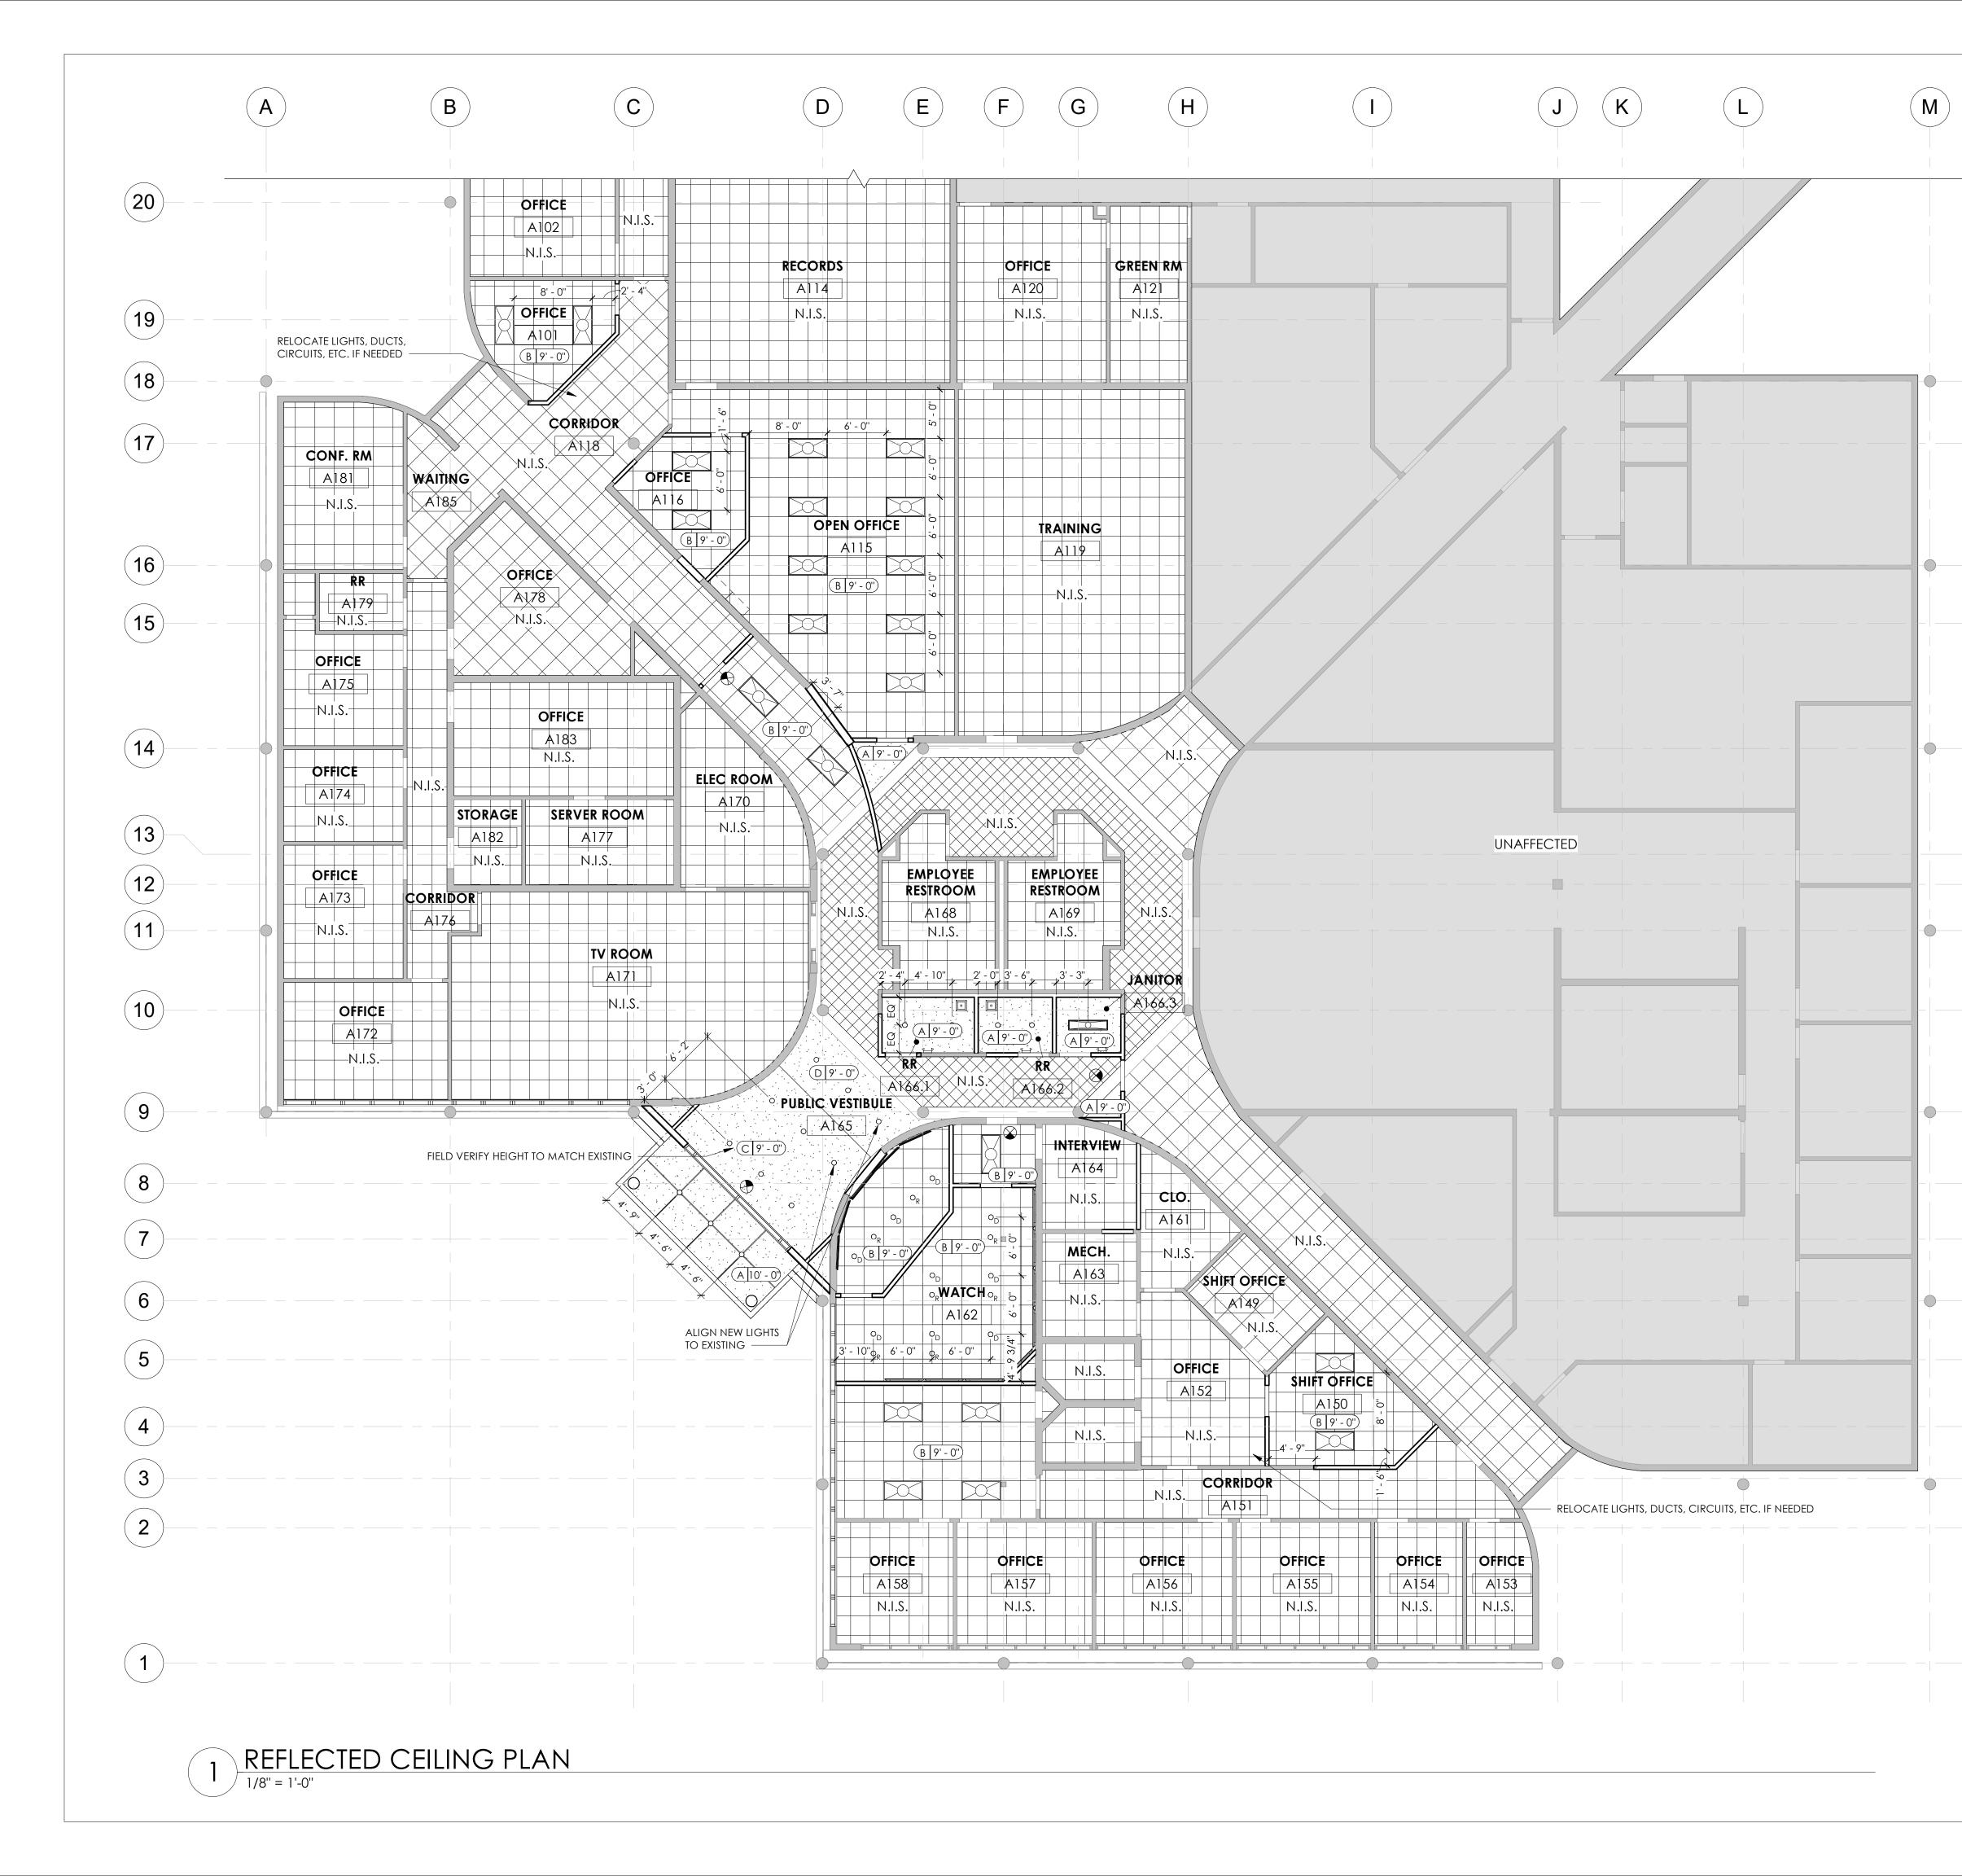
COMMISSION NO:

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SHEET TITLE:

1ST FLOOR PLAN

SHEET NO:



CEILING NOTES

CEILINGS MARKED AS N.I.S. ARE FOR REFERENCE ONLY.

- ALL CEILINGS ARE TYPE "A" (9'- 0") TYPICAL, UNLESS OTHERWISE NOTED.
- B. LIGHTING AND HVAC COMPONENTS SHOWN IN CEILING PLAN ARE FOR LOCATION AND DIMENSIONAL PURPOSES ONLY. REFER TO CONSULTANT DRAWINGS FOR FULL EXTENT. NOTIFY ARCHITECT OF ANY DISCREPENCIES BETWEEN ARCHITECTURAL AND ENGINEERED DRAWINGS.
- 4. COORDINATE ALL CEILING OPENINGS WITH ELECTRICAL AND MECHANICAL DRAWINGS.
- 5. DO NOT ATTACH PARTITION OR CEILING SYSTEMS TO PORTIONS OF ANY MECHANICAL EQUIPMENT. CONTRACTOR TO COORDINATE LOCATIONS AND PROVIDE ALTERNATE BRACING IF CONFLICTS OCCUR.
- COORDINATE HEIGHTS OF SUSPENDED LIGHTING, OR SUSPENDED OR WALL MOUNTED HVAC COMPONENTS WITH ARCHITECT IF NOT PROVIDED IN DRAWINGS.
- 7. ALL EXPOSED DECKING, STRUCTURE, PIPING, DUCTWORK AND OTHER CEILING MOUNTED ITEMS SHALL BE PAINTED, UNLESS NOTED OTHERWISE.
- 8. COORDINATE AND FIELD VERIFY CLEARANCES FOR ALL EQUIPMENT TO BE LOCATED ABOVE CEILING.
- 9. DIMENSIONS ARE TO FACE OF FINISHED SURFACE, UNLESS NOTED OTHERWISE.
- 10. PROVIDE ALL EXIT LIGHTS SHOWN. VERIFY AMOUNT AND LOCATIONS WITH FIRE MARSHALL BEFORE INSTALL.
- 11. ALL RED FIXTURES IN A SINGLE ROOM TO BE ONE ONE SWITCH, SEPARATE FROM OTHER LIGHTS.

CEILING MATERIAL LEGEND

CEILING TYPES

	CEILING HEIGHT A.F.F.
TAG	DESCRIPTION
А	1/2" GWB ON 7/8" FURRING STRIPS
В	2X2 SUSPENDED ACOUSTICAL LAY-IN CEILING
С	1/2" GWB ON SUSPENDED GRID, PAINT W/ PT-4
D	EXISTING CEILING, PAINT W/ PT-4
N.I.S.	NOT IN SCOPE

LIGHTING LEGEND

\bigcirc	6" SURFACE MOUNTED LIGHT
U	ELITE LIGHTING, HHR6-LED WITH HH6-6501 TRIM
\bigcirc_{D}	6" SURFACE MOUNTED LIGHT, DIMMABLE
) D	ELITE LIGHTING, HH6R-LED-WDM
\bigcirc	6" SURFACE MOUNTED LIGHT, RED
\bigcirc_{R}	ELITE LIGHTING, HHR6-LED-RGBW WITH HH6-6501 TRIM
	1X4 SURFACE MOUNTED LED
	ELITE LIGHTING, 14-FPL-BL-LED
	2X4 SURFACE MOUNTED LED
	ELITE LIGHTING, 24-FPL-BL-LED
	restroom exhaust fan
	WALL-MOUNTED EMERGENCY LIGHTING

EMERGENCY EXIT LIGHT

 \bigotimes



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FAYETTE COUNTY SHERIFF'S DEPT

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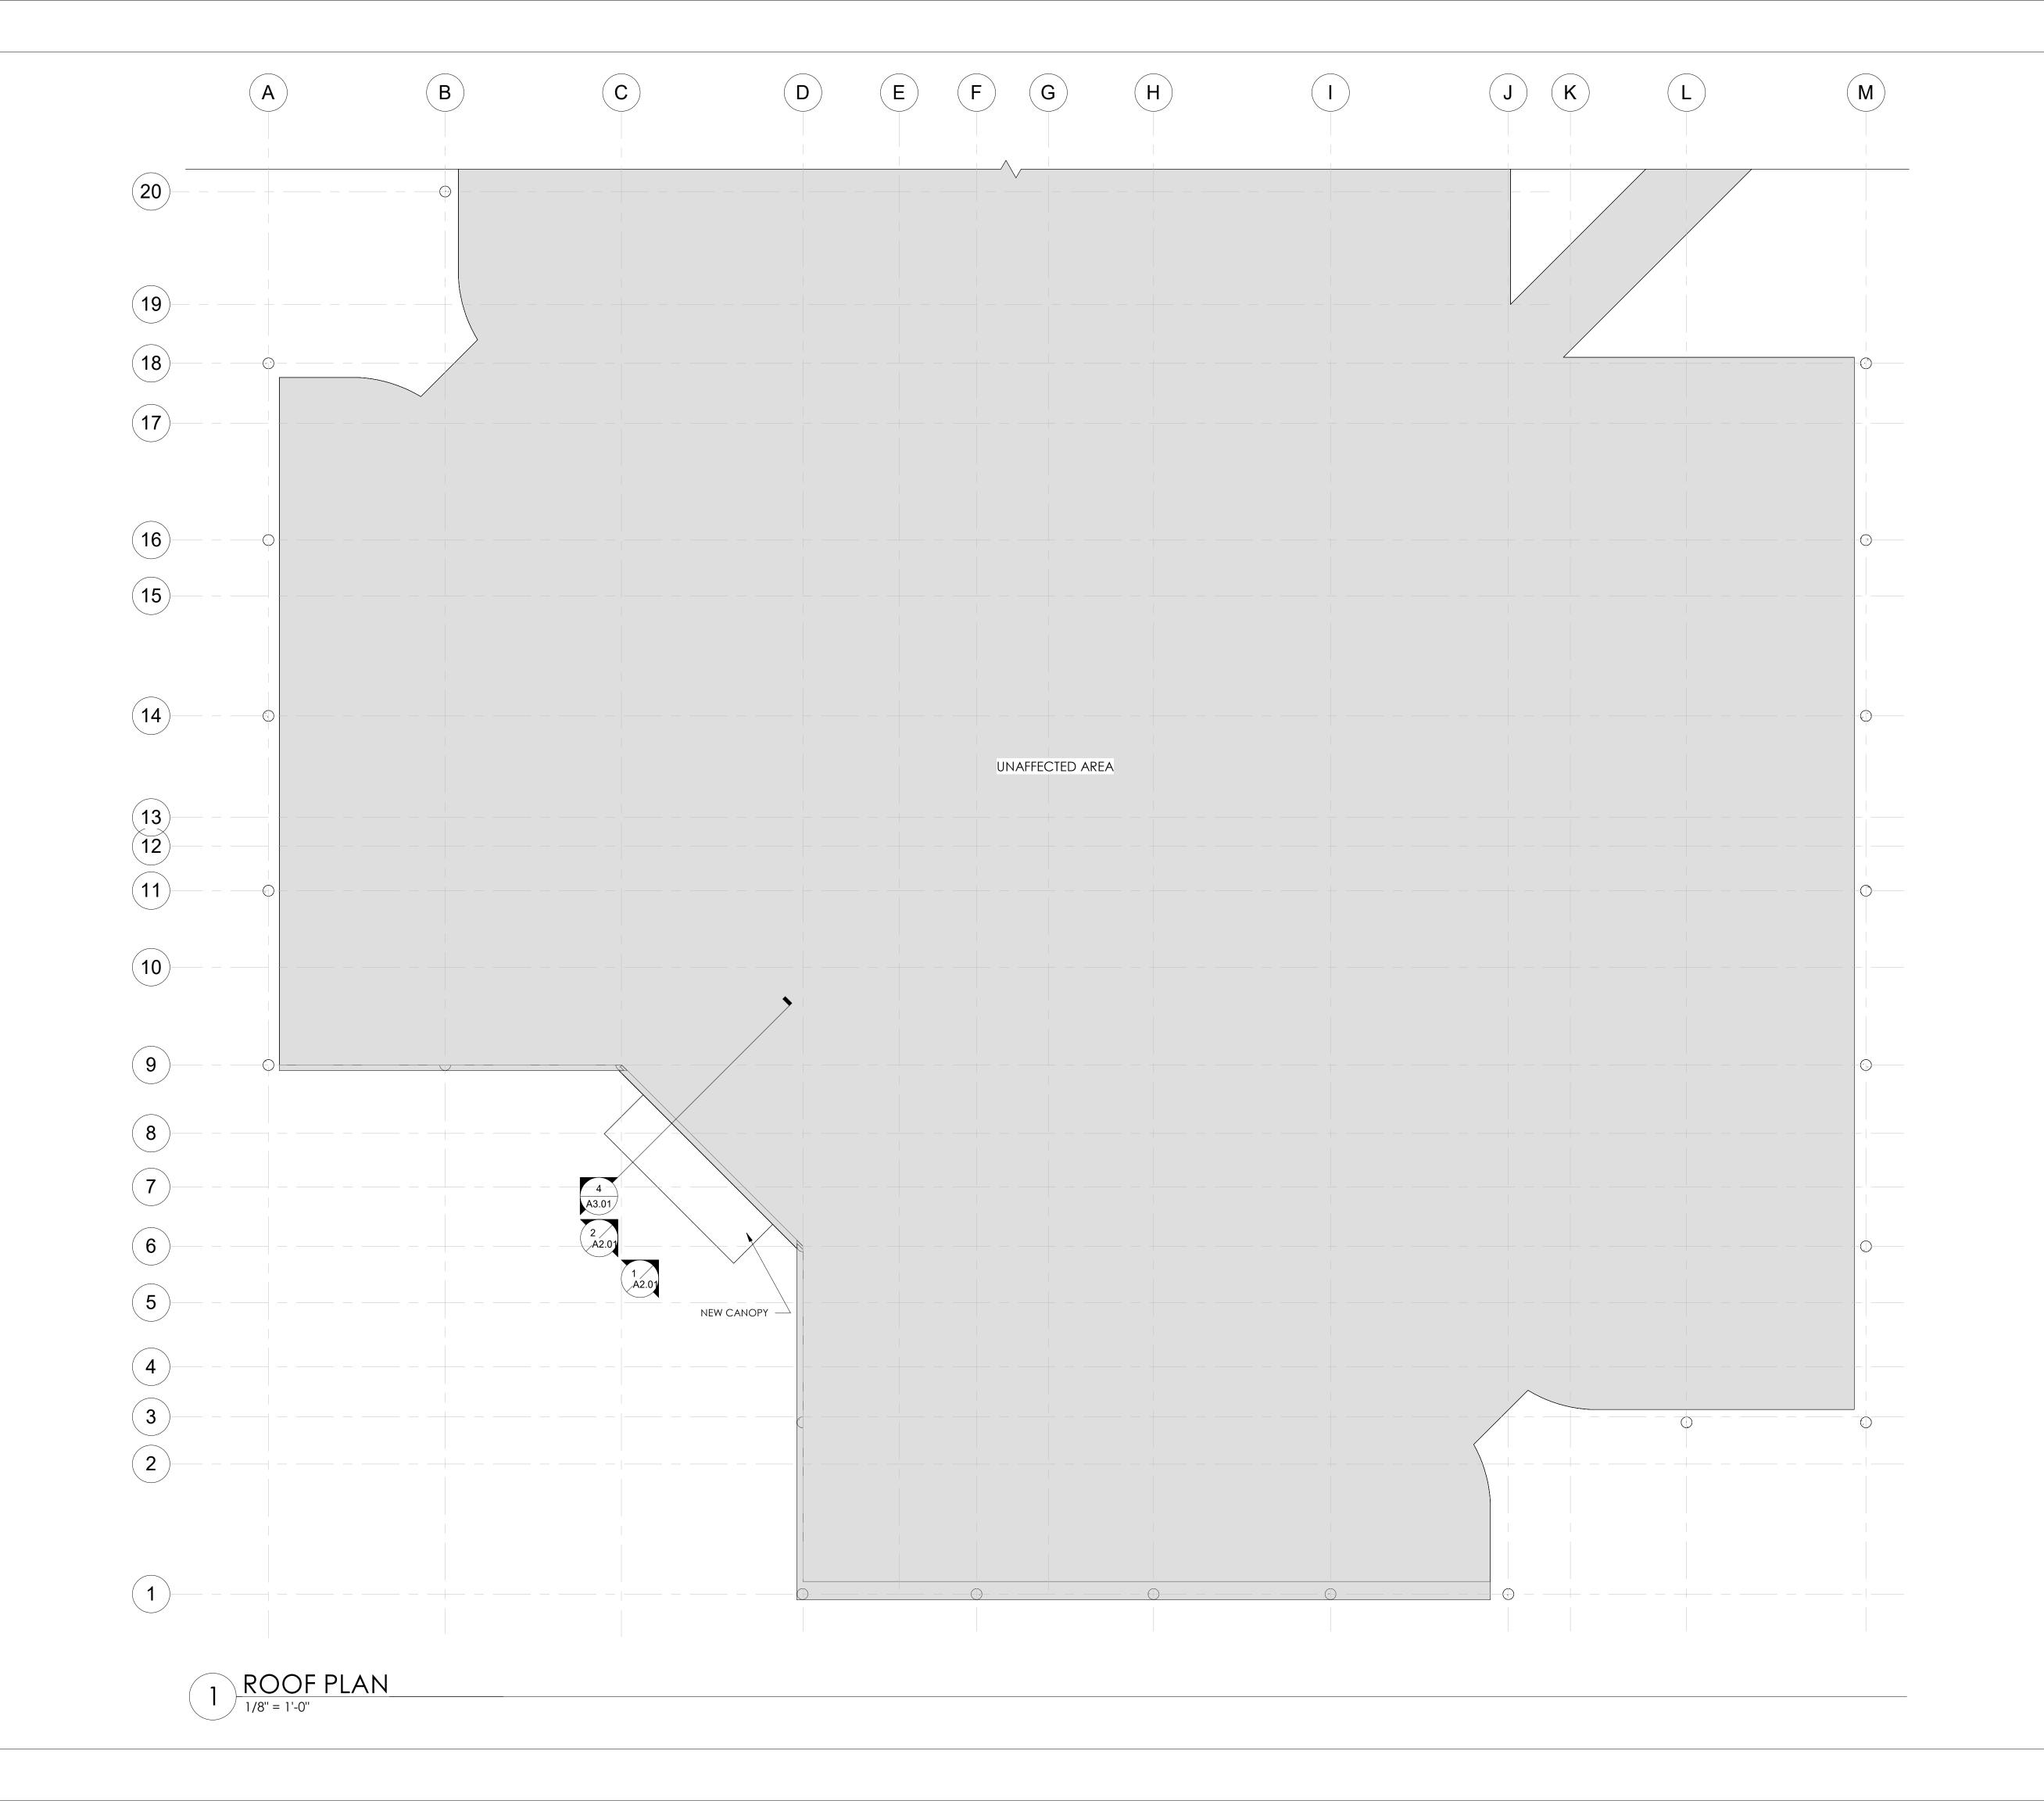
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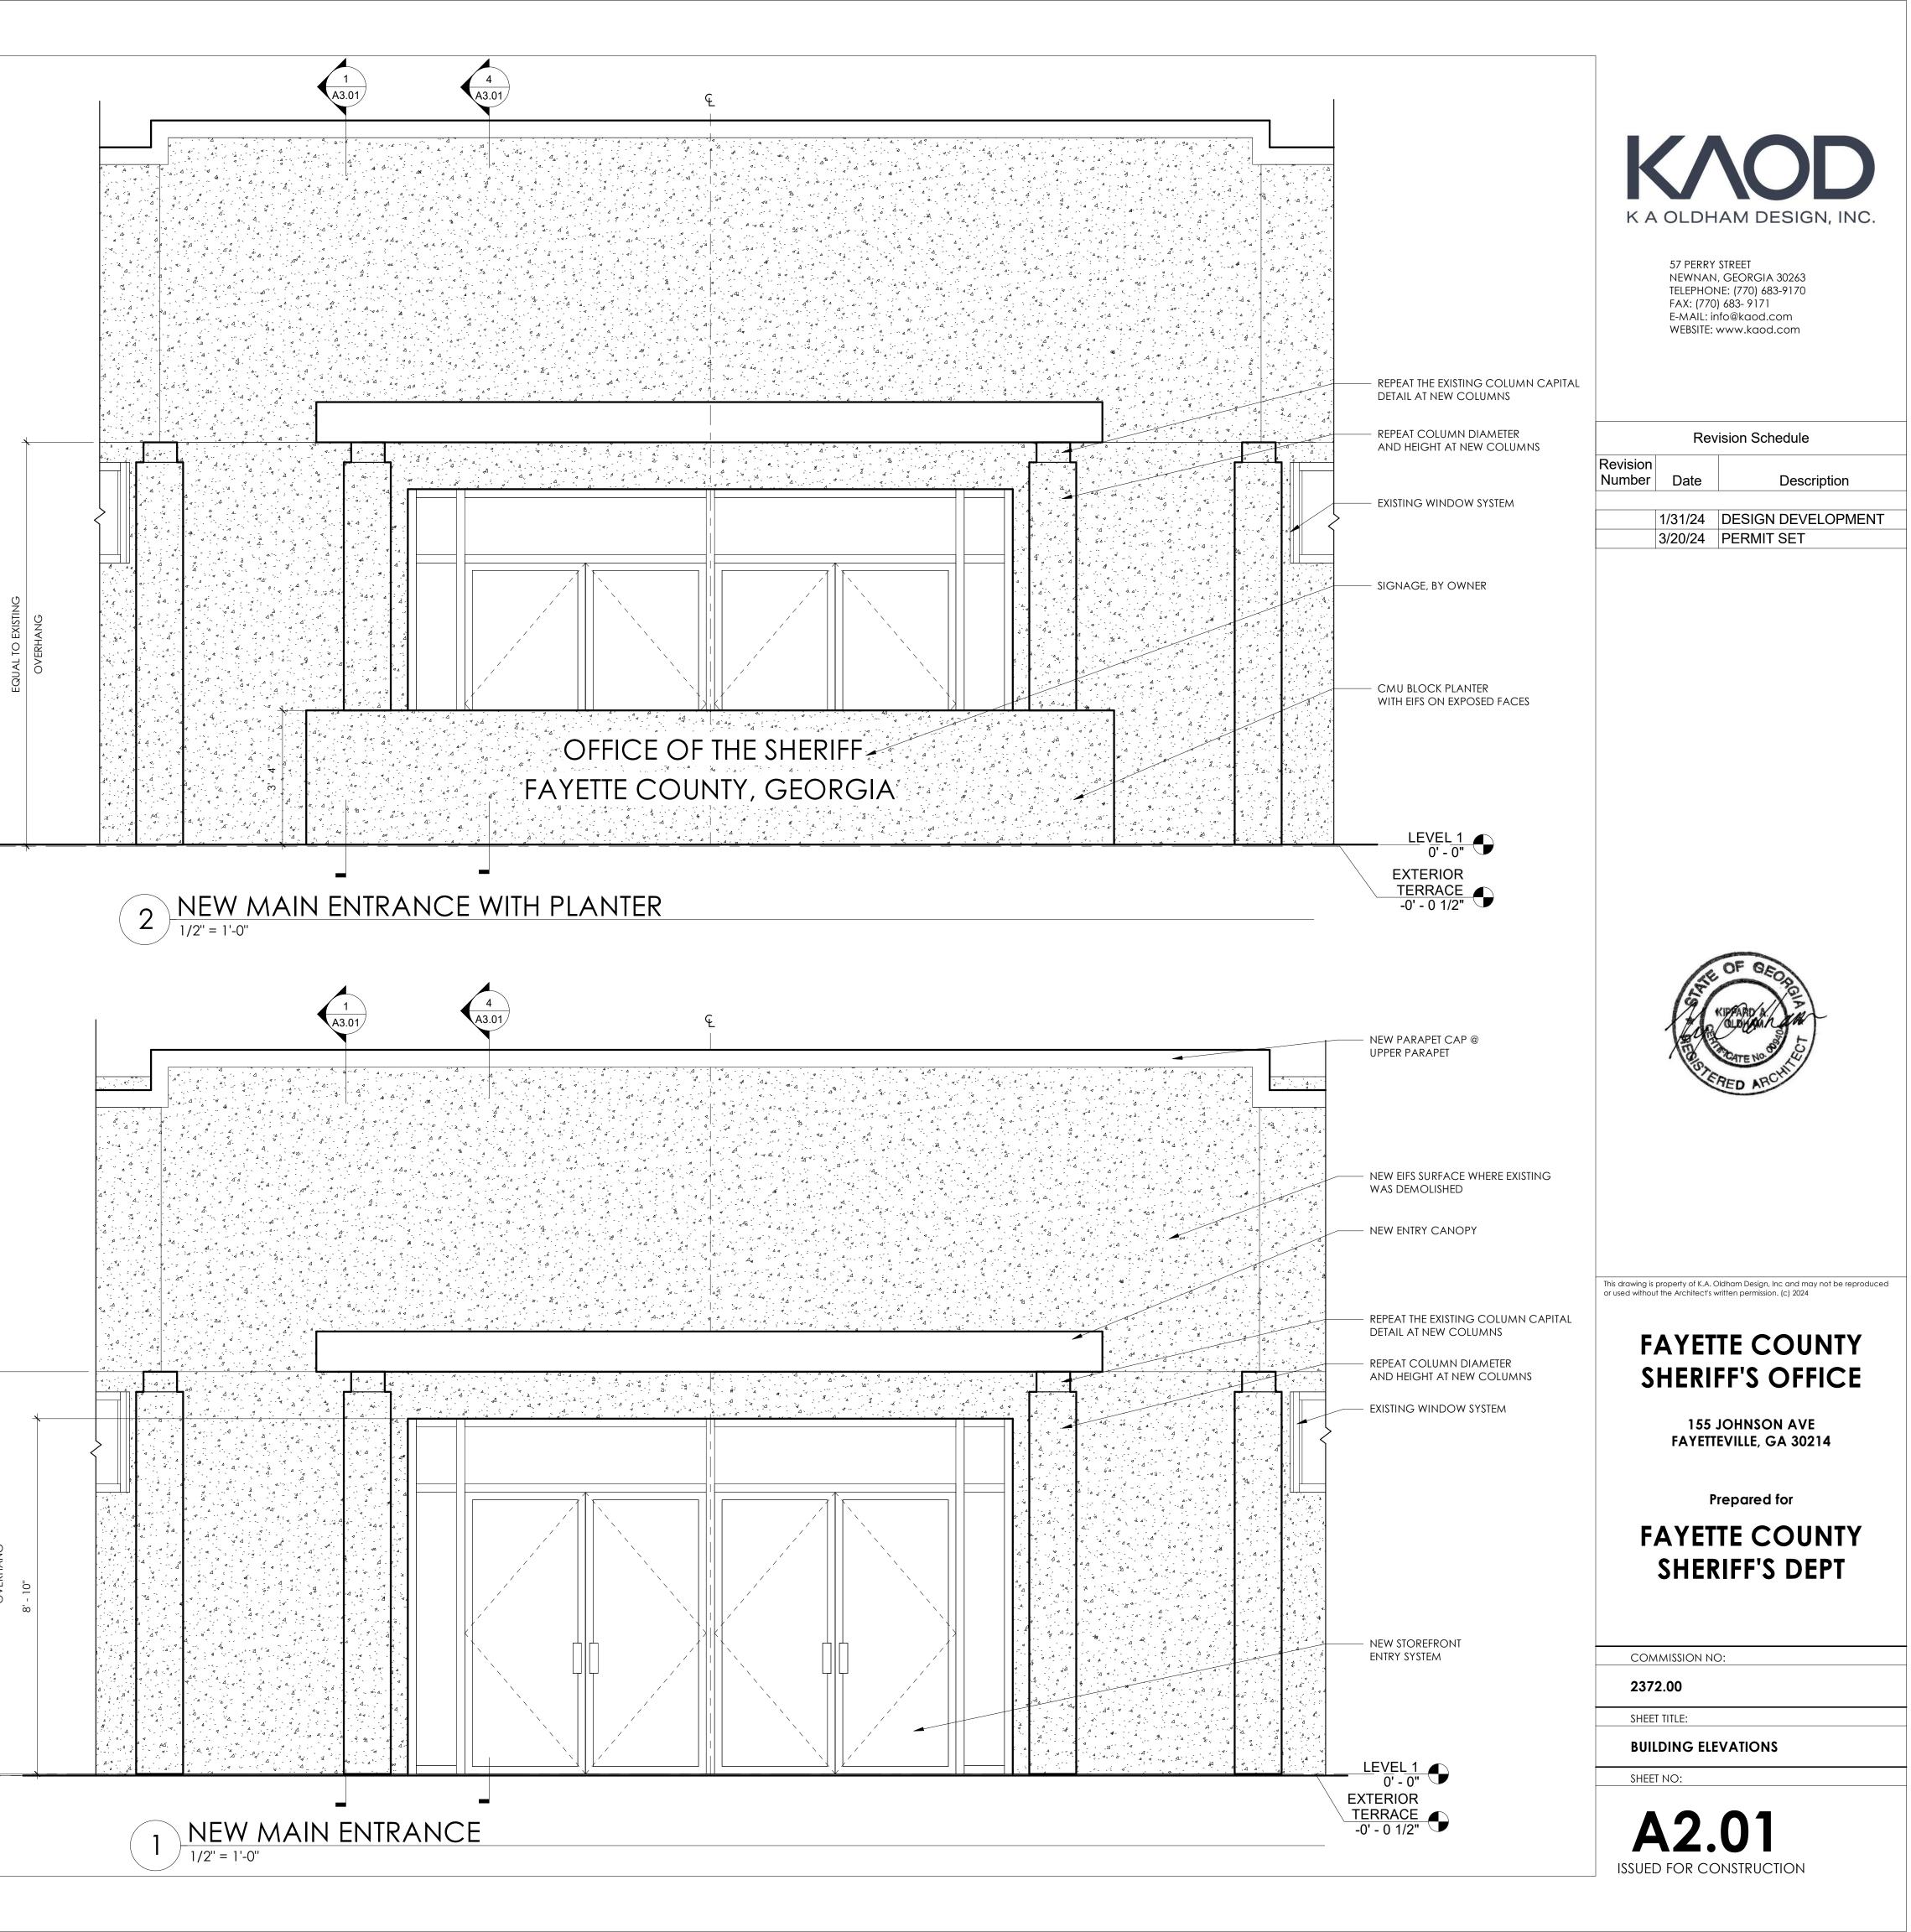
REFLECTED CEILING PLAN


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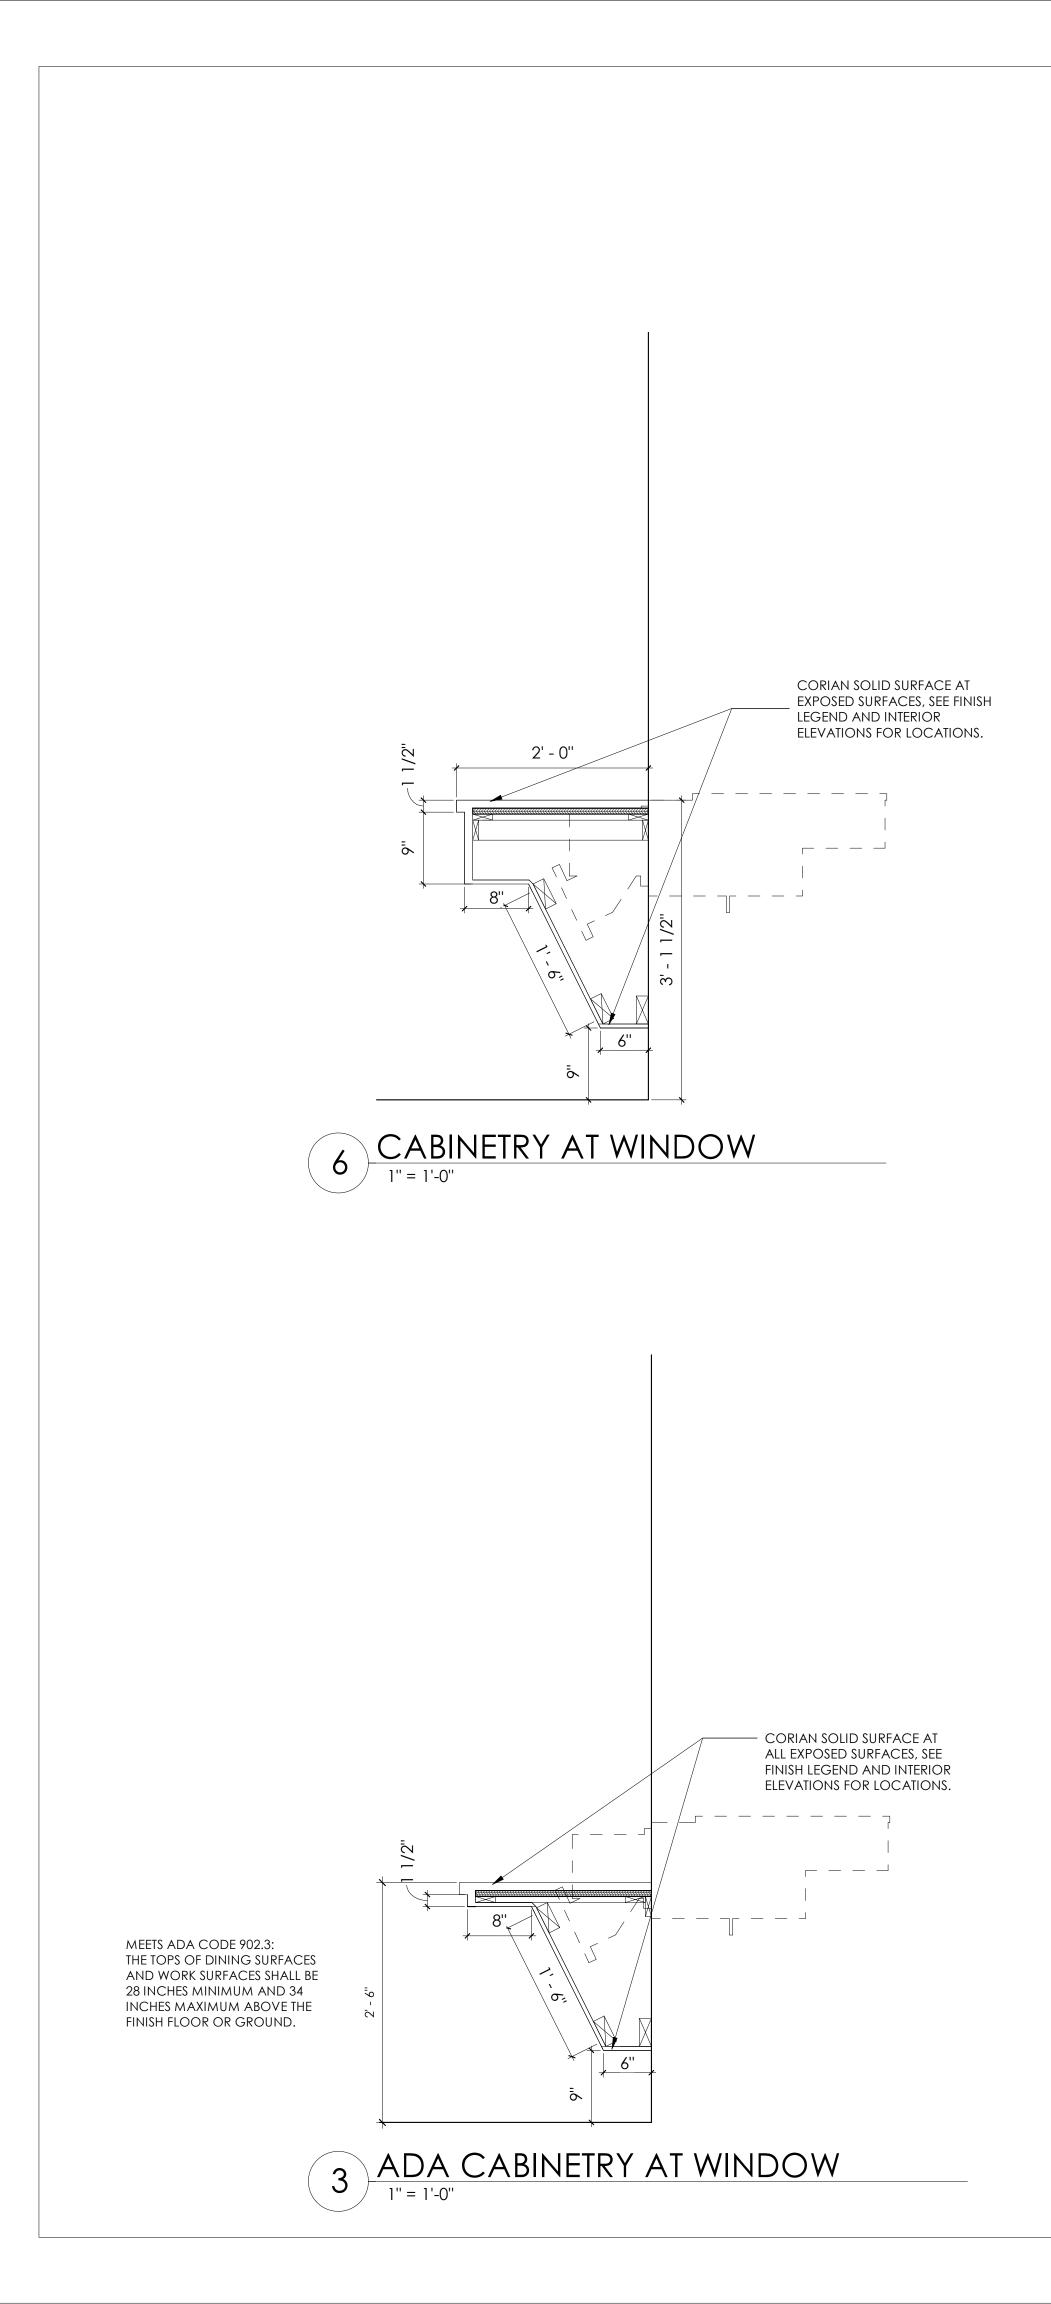
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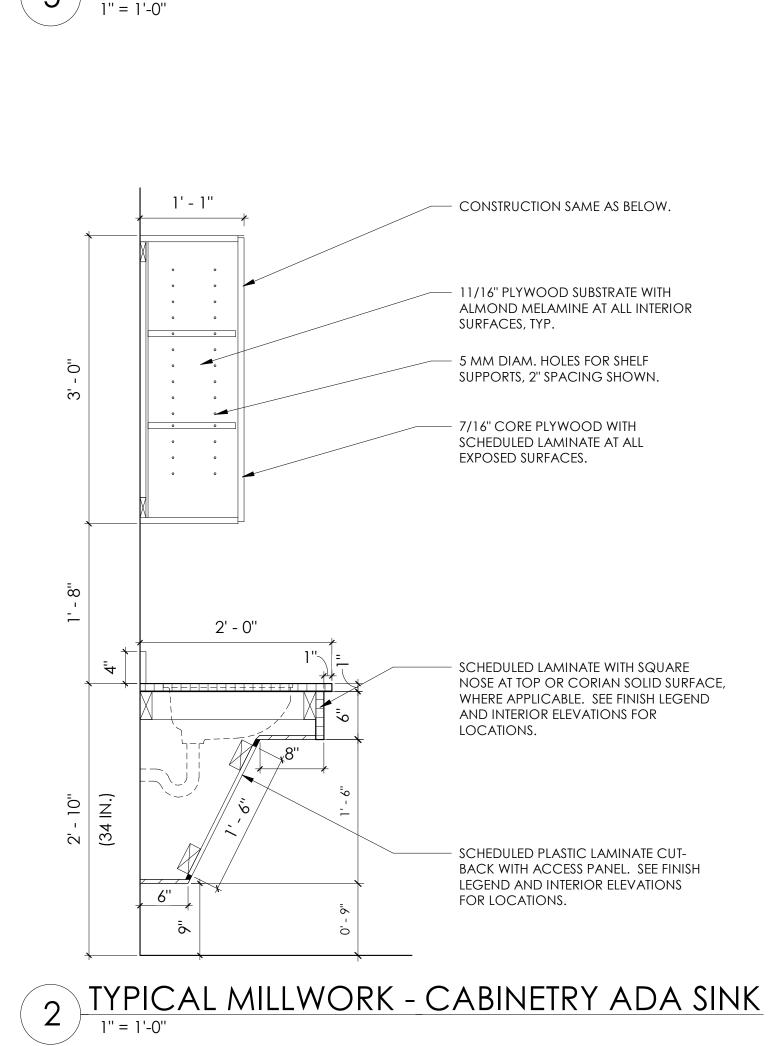



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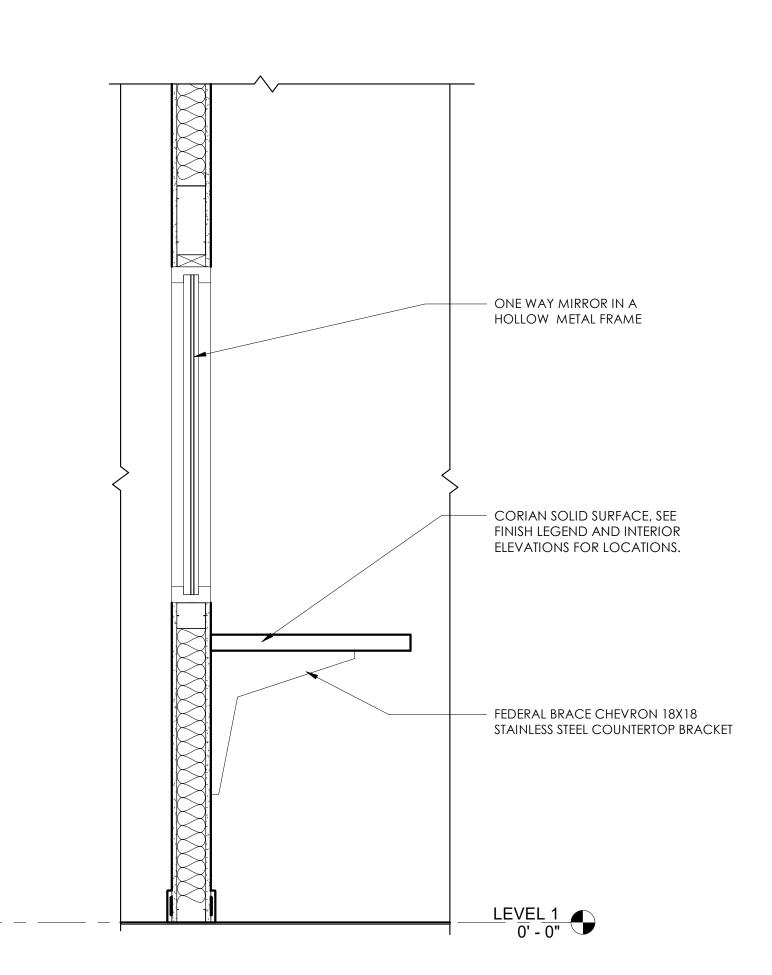









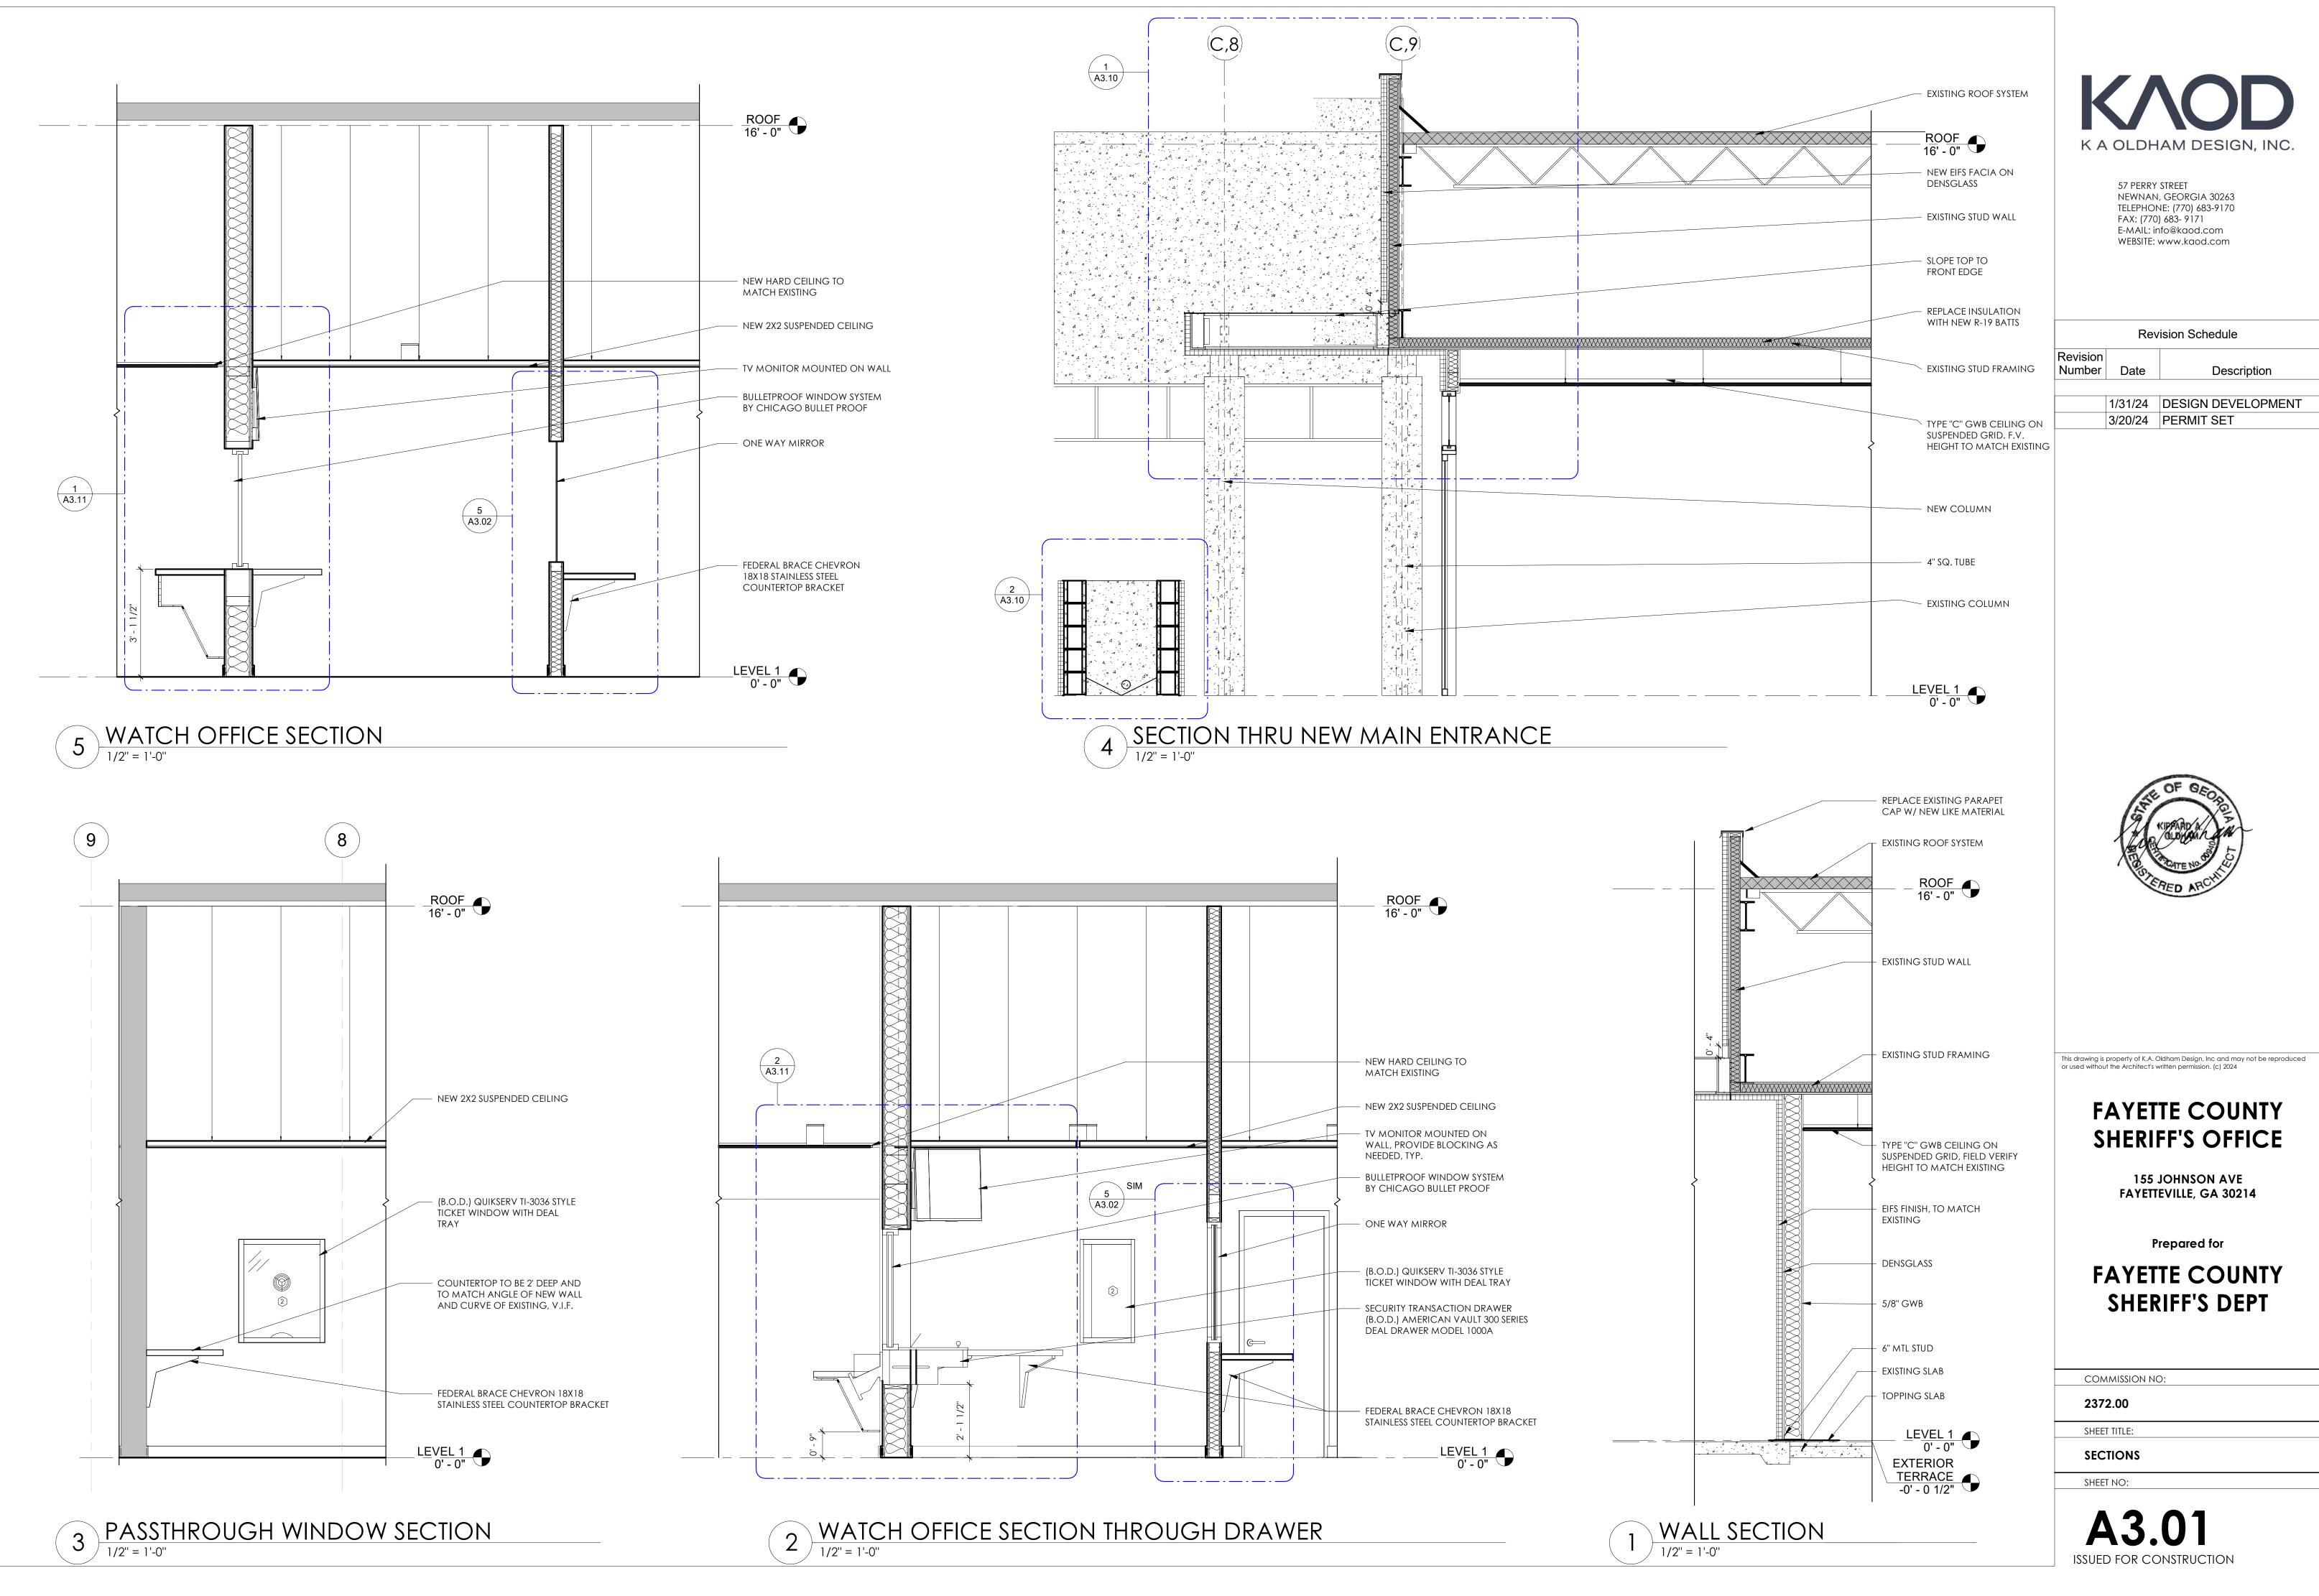

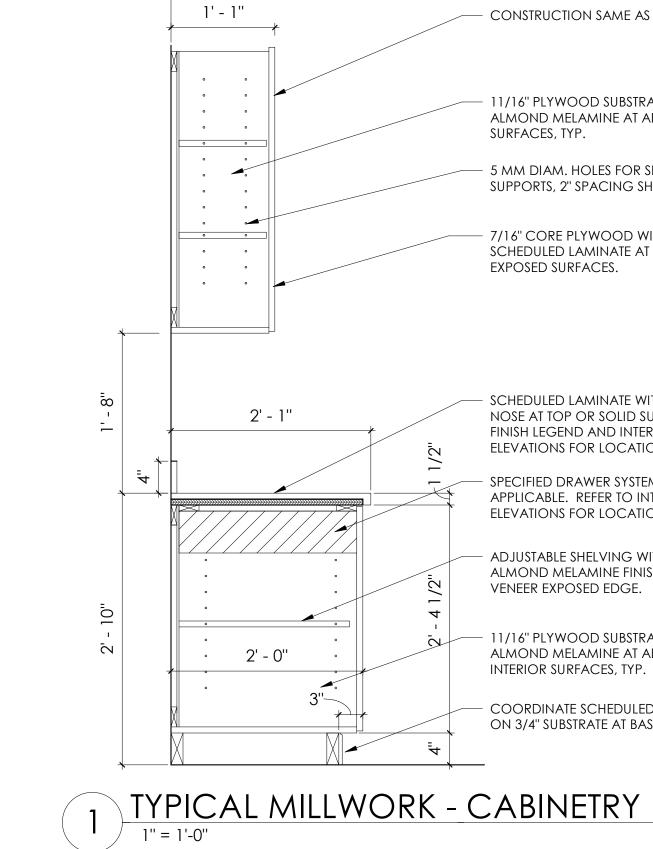



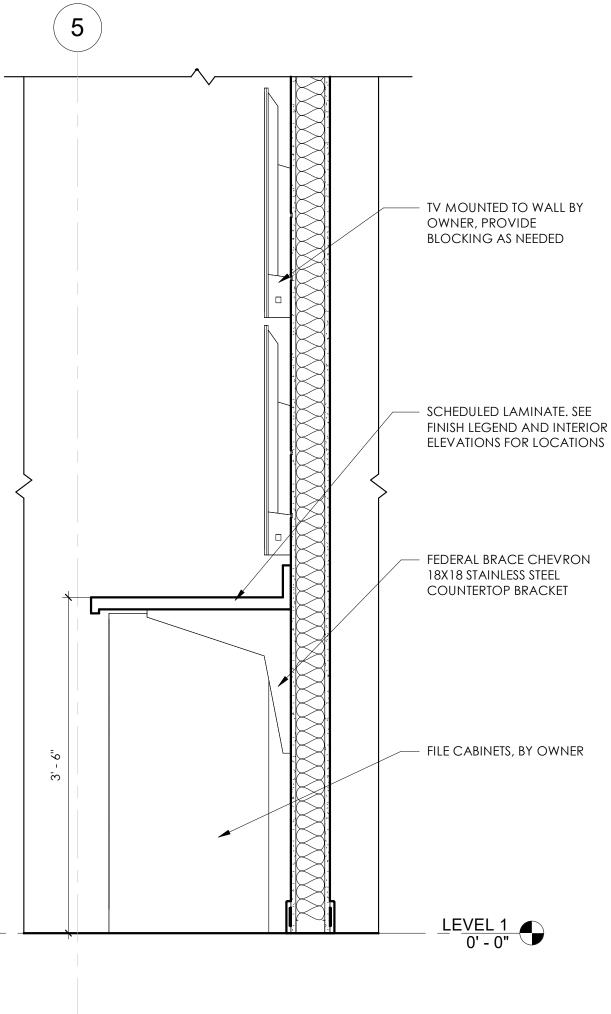



CONSTRUCTION SAME AS BELOW.

11/16" PLYWOOD SUBSTRATE WITH ALMOND MELAMINE AT ALL INTERIOR SURFACES, TYP. 5 MM DIAM. HOLES FOR SHELF

SUPPORTS, 2" SPACING SHOWN.

7/16" CORE PLYWOOD WITH SCHEDULED LAMINATE AT ALL EXPOSED SURFACES.

SCHEDULED LAMINATE WITH SQUARE NOSE AT TOP OR SOLID SURFACE. SEE FINISH LEGEND AND INTERIOR

ELEVATIONS FOR LOCATIONS.

SPECIFIED DRAWER SYSTEM, WHERE

APPLICABLE. REFER TO INTERIOR

ELEVATIONS FOR LOCATIONS.

ADJUSTABLE SHELVING WITH

ALMOND MELAMINE FINISH, WOOD

VENEER EXPOSED EDGE.

11/16" PLYWOOD SUBSTRATE WITH ALMOND MELAMINE AT ALL INTERIOR SURFACES, TYP.

COORDINATE SCHEDULED LAMINATE ON 3/4" SUBSTRATE AT BASE

COMMISSION NO:

2372.00

SHEET TITLE:

MILLWORK DETAILS SHEET NO:

A3.02 ISSUED FOR CONSTRUCTION

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FAYETTE COUNTY

SHERIFF'S OFFICE

155 JOHNSON AVE FAYETTEVILLE, GA 30214

Prepared for

FAYETTE COUNTY

SHERIFF'S DEPT

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Revision Schedule


3/20/24 PERMIT SET

1/31/24 DESIGN DEVELOPMENT

Description

Revision


Number Date

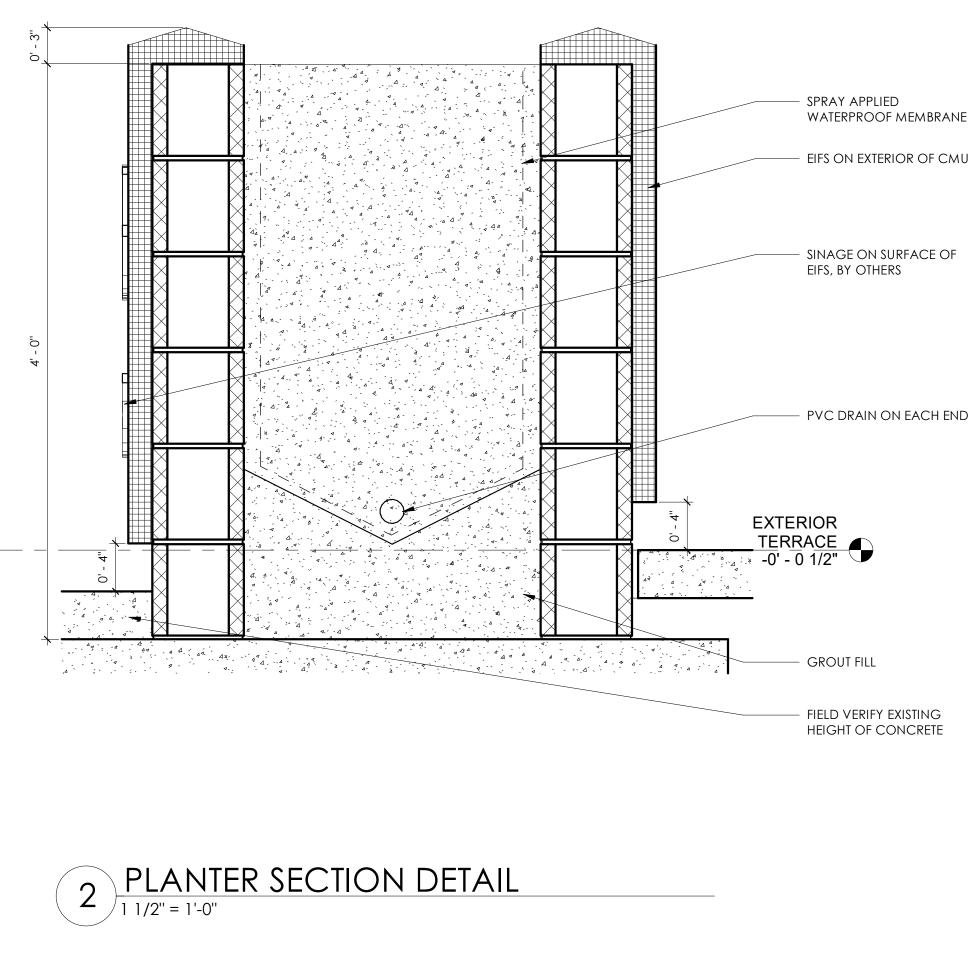



- SINAGE ON SURFACE OF EIFS, BY OTHERS


EIFS ON EXTERIOR OF CMU

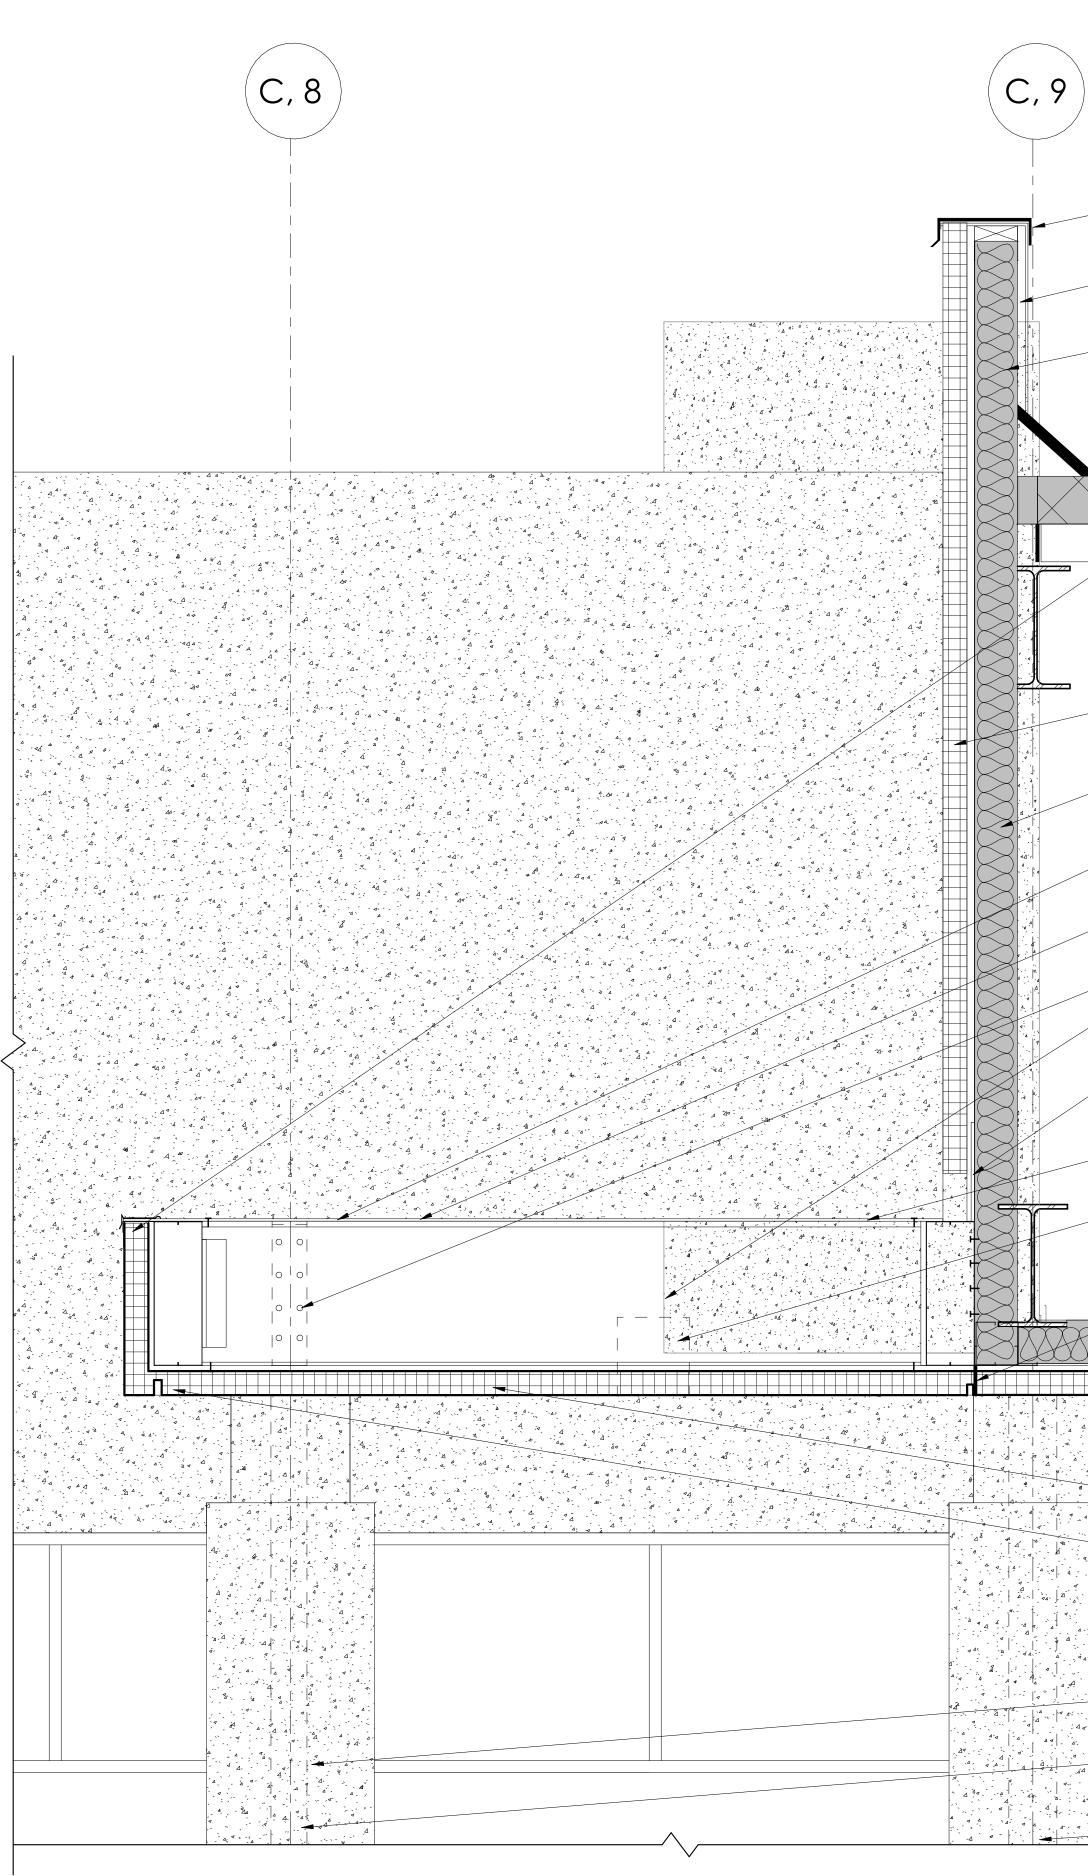


1 MAIN ENTRANCE SECTION DETAIL

			AM DESIGN, INC.
— REPLACE EXISTING PARAPET CAP W/ NEW LIKE MATERIAL		TELEPHO FAX: (770 E-MAIL: ii	STREET I, GEORGIA 30263 NE: (770) 683-9170)) 683- 9171 nfo@kaod.com www.kaod.com
— EXISTING UPPER PARAPET			
		1	vision Schedule
— EXISTING ROOF SYSTEM	Revision Number		Description
		1/31/24	DESIGN DEVELOPMENT
— GALVANIZED STEEL DRIP EDGE		3/20/24	PERMIT SET
— NEW EIFS FACIA ON DENSGLASS			
— EXISTING STUD WALL			
— NEW TPO ROOFING ON TREATED PLYWOOD			
— METAL DECKING 2"			
THICK			
 NEW STRUCTURE, SEE STRUCTURAL DRAWINGS FOR DETAILS 		SP	OF GEOD
— TURN TPO ROOFING UP WALL 8" MINIMUM		1.	KIPPARD A.
			TOATE NO.
edge — Recessed can light, see		N.	RED ARCHI
RCP FOR LOCATIONS			
— 1/2" CONTROL JOINT AT NEW STUD FRAMING			
— EXISTING STUD FRAMING			
— DEMO EIFS AS NEEDED	This drawing is or used withou	property of K.A. (ut the Architect's	Oldham Design, Inc and may not be reproduced written permission. (c) 2024
	-		
— DRAINABLE SYSTEM AT EIFS EDGE, TYP.			TE COUNTY FF'S OFFICE
— TYPE "C" GWB CEILING ON SUSPENDED GRID, FIELD	. .		
VERIFY HEIGHT TO MATCH EXISTING			JOHNSON AVE EVILLE, GA 30214
— EIFS TO MATCH EXISTING COLOR AND TEXTURE			
- DRIP EDGE REVEAL	-		Prepared for
AT ALL EDGES			TE COUNTY RIFF'S DEPT
— NEW COLUMN TO MATCH EXISTING		JIILI	
— NEW STRUCTURAL COLUMN SEE STRUCTURAL DRAWINGS			
		1.00 MMISSION N	0:
— EXISTING COLUMN		T TITLE:	
	SEC	TION DET	AILS


SHEET NO:

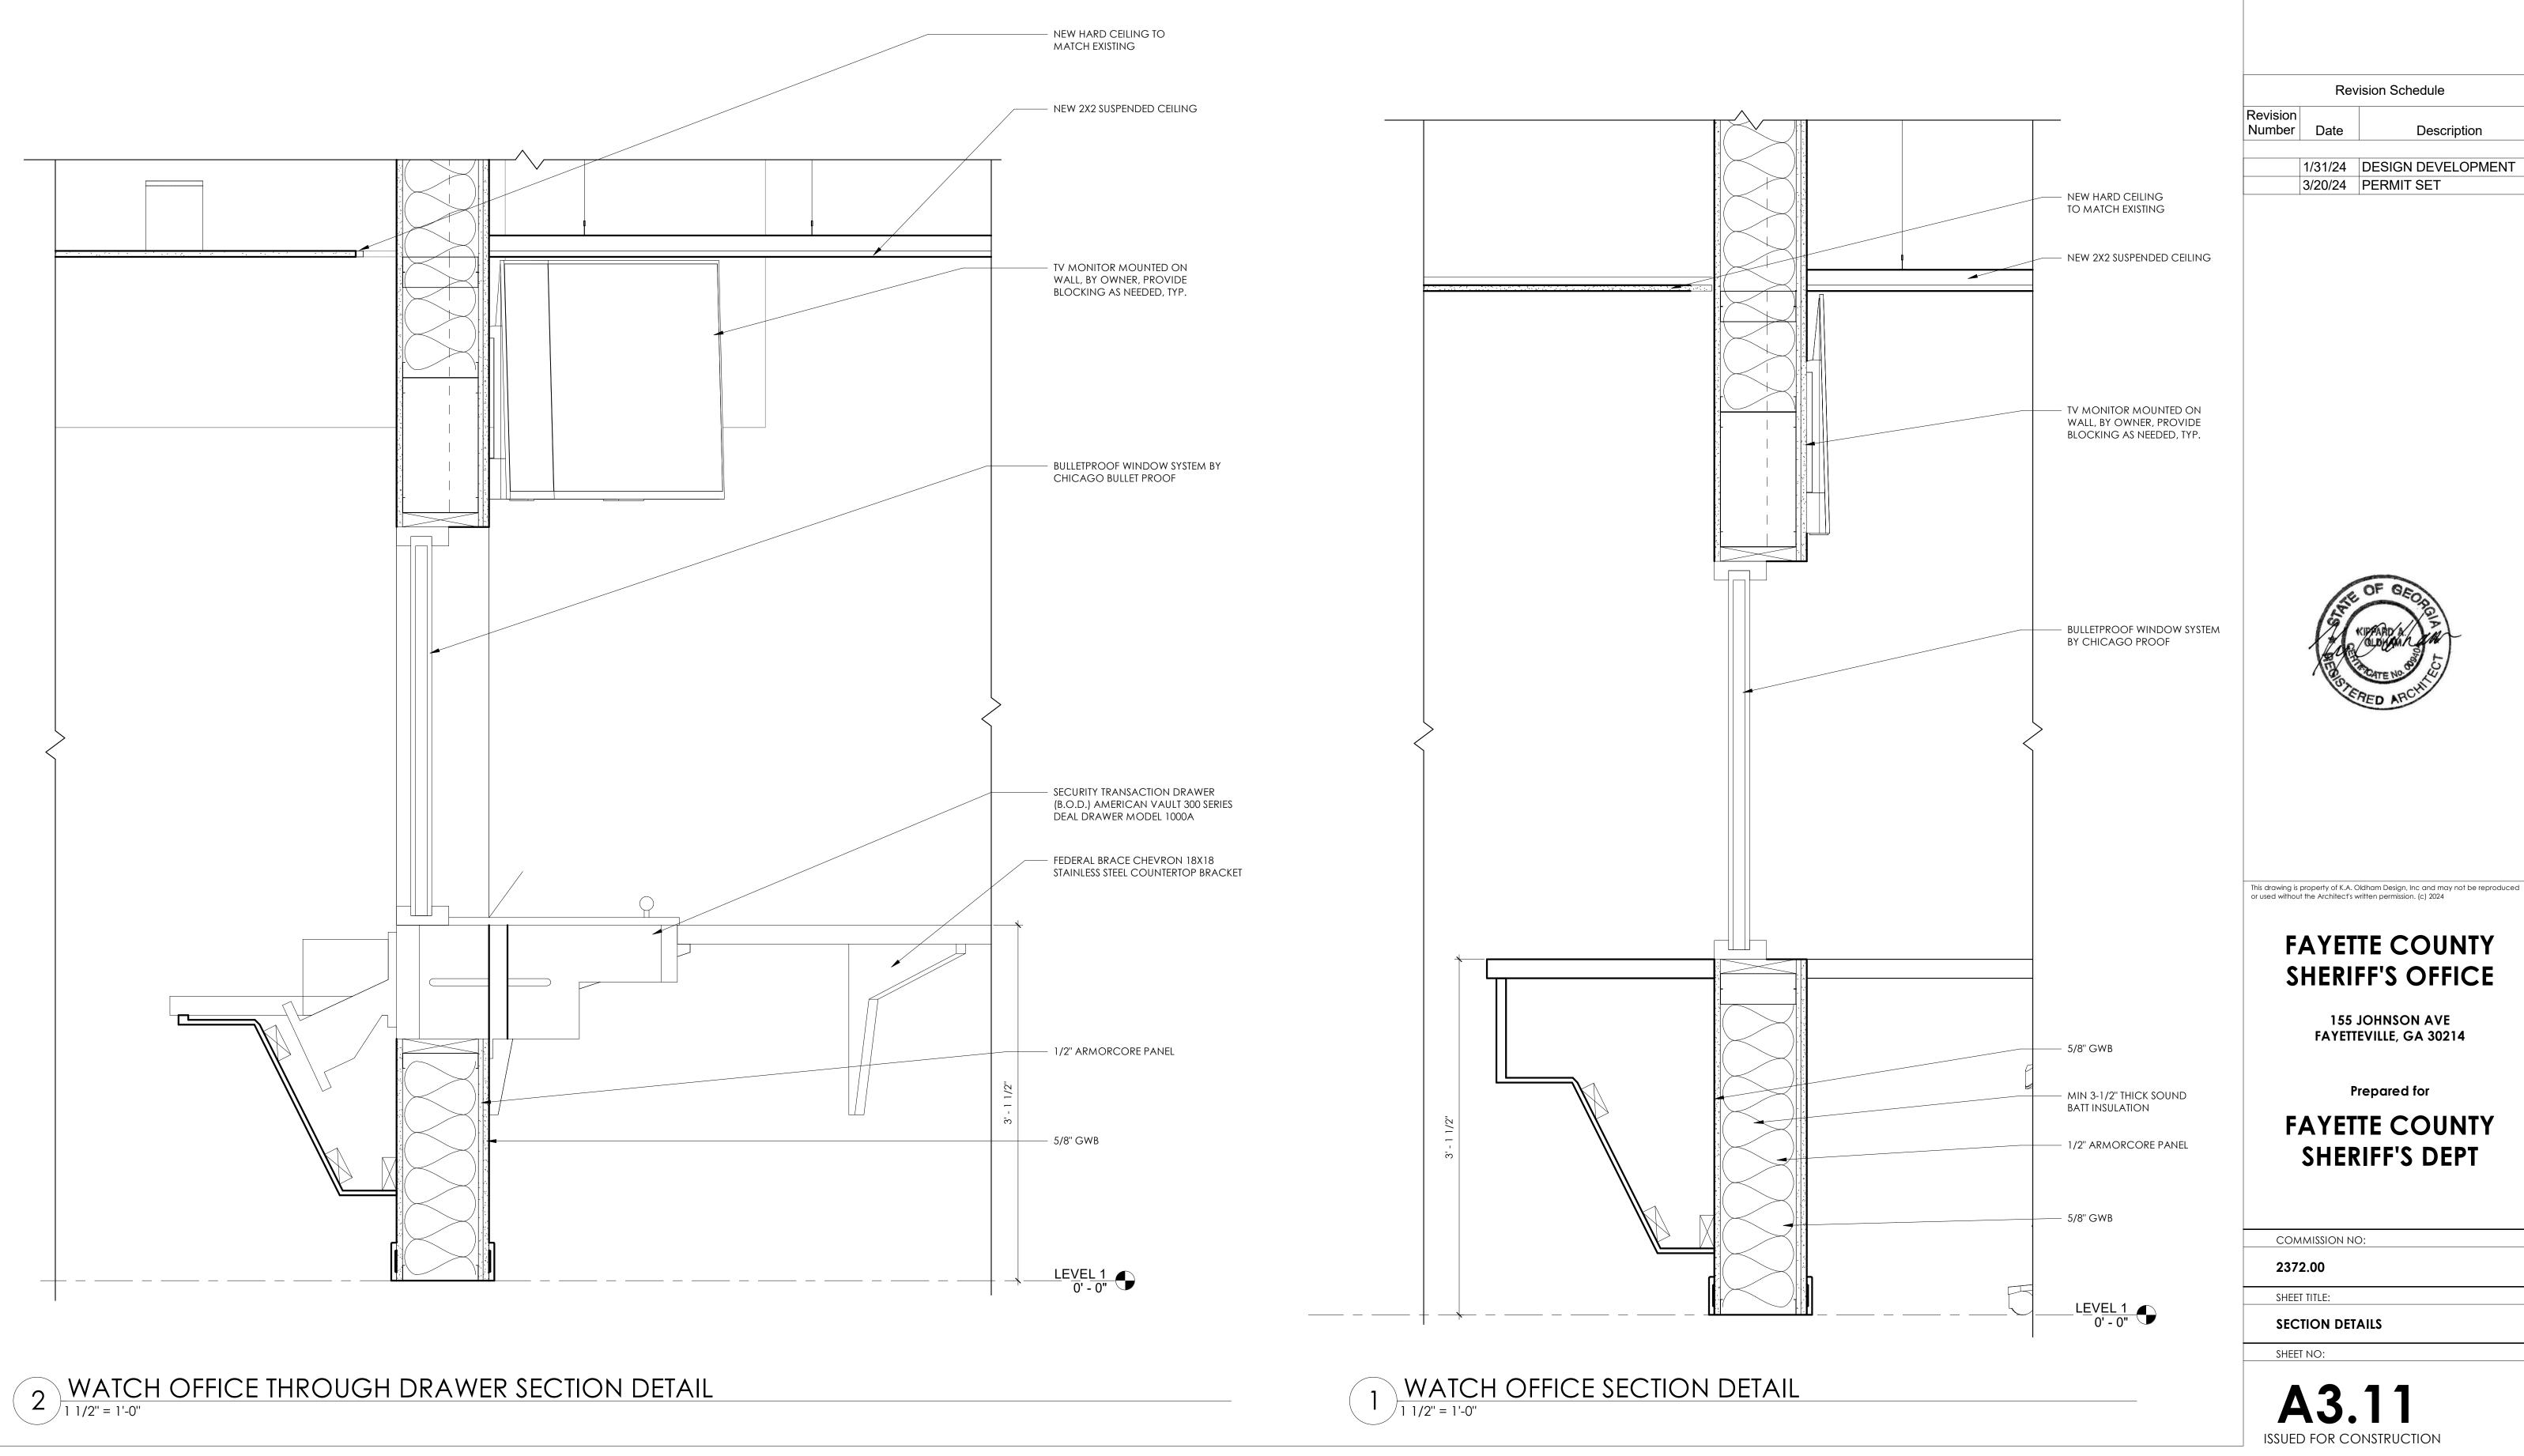


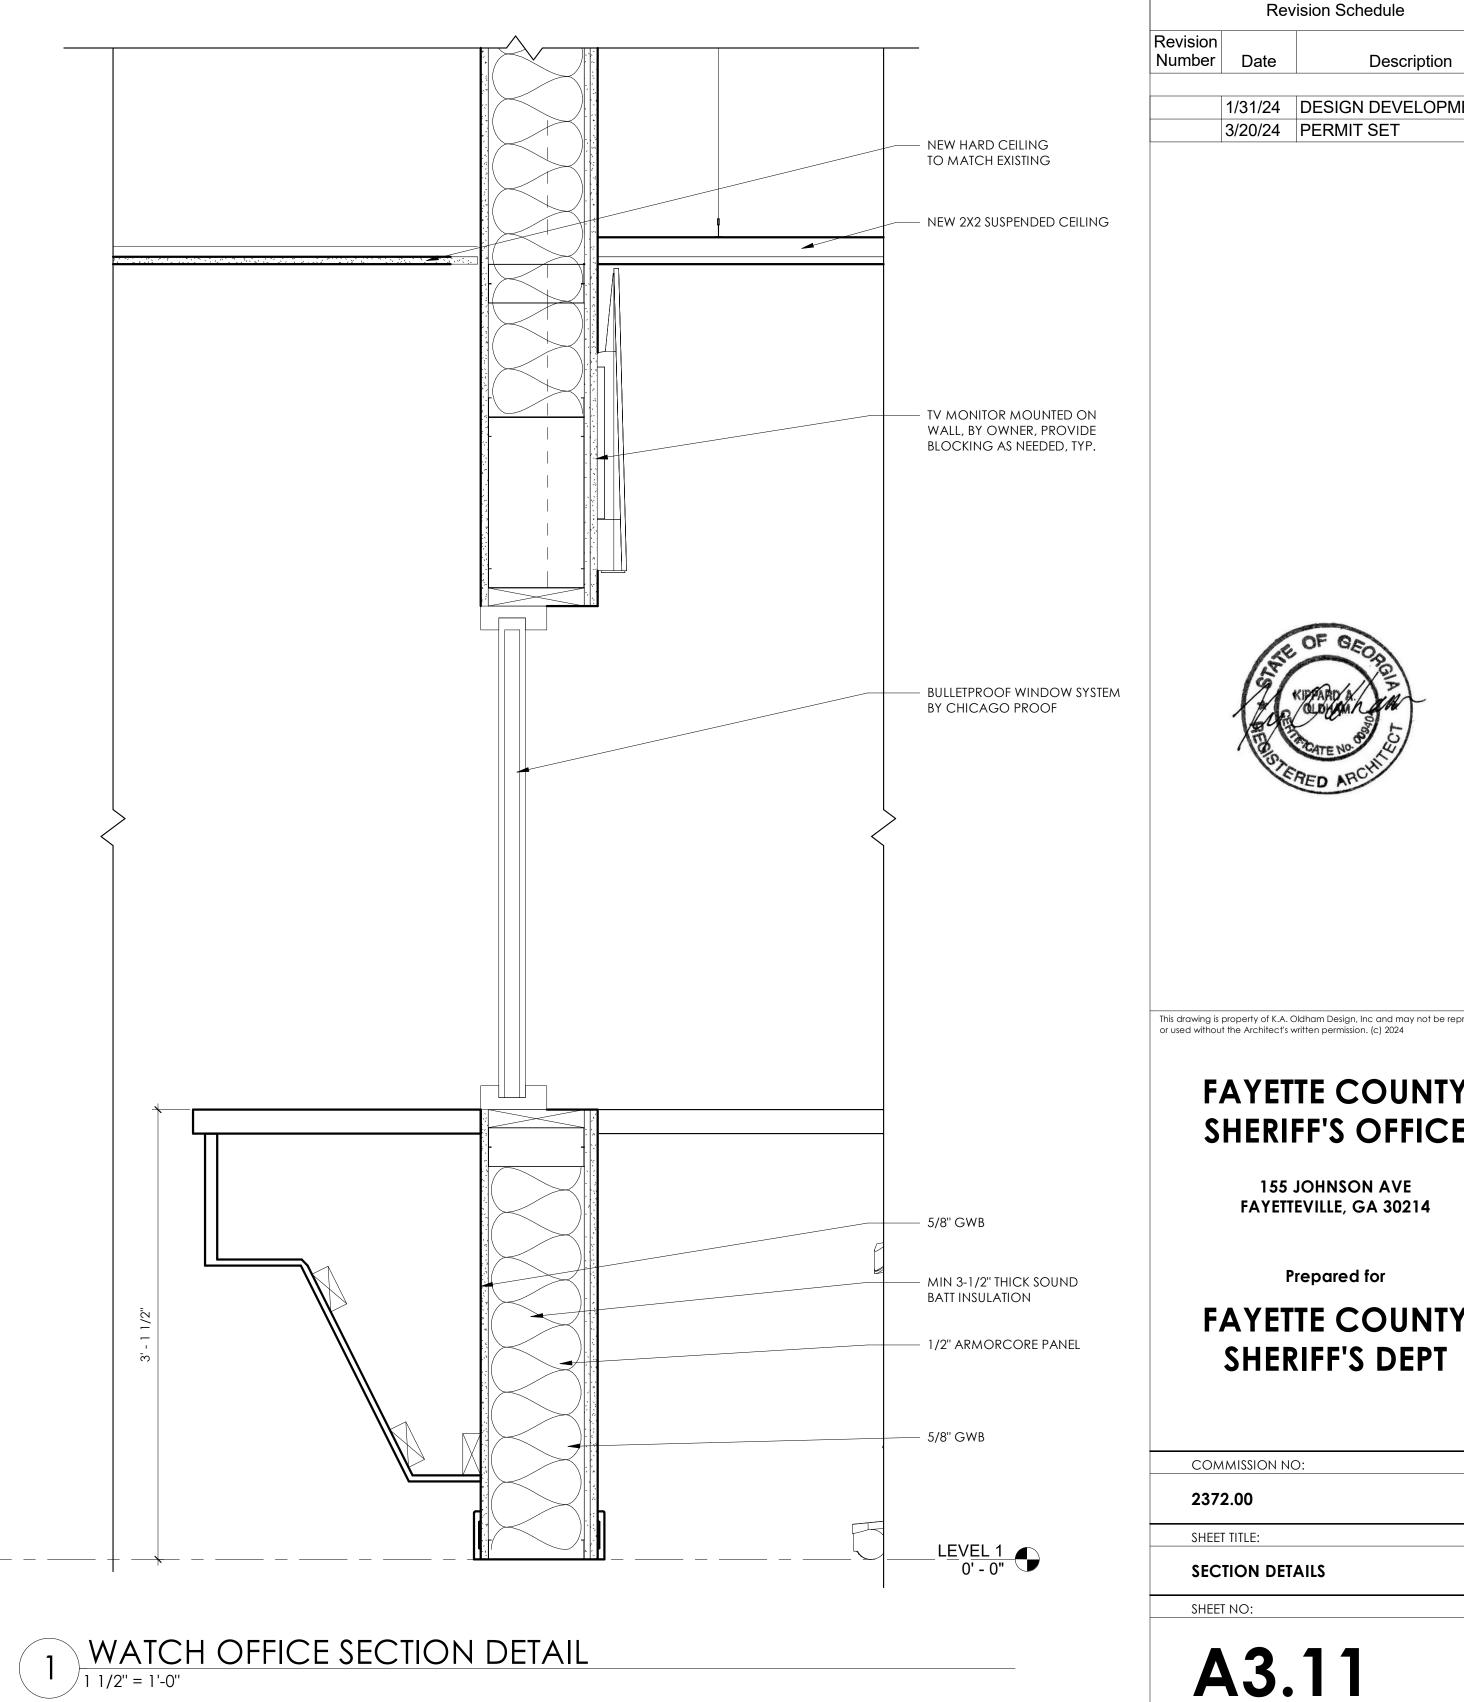



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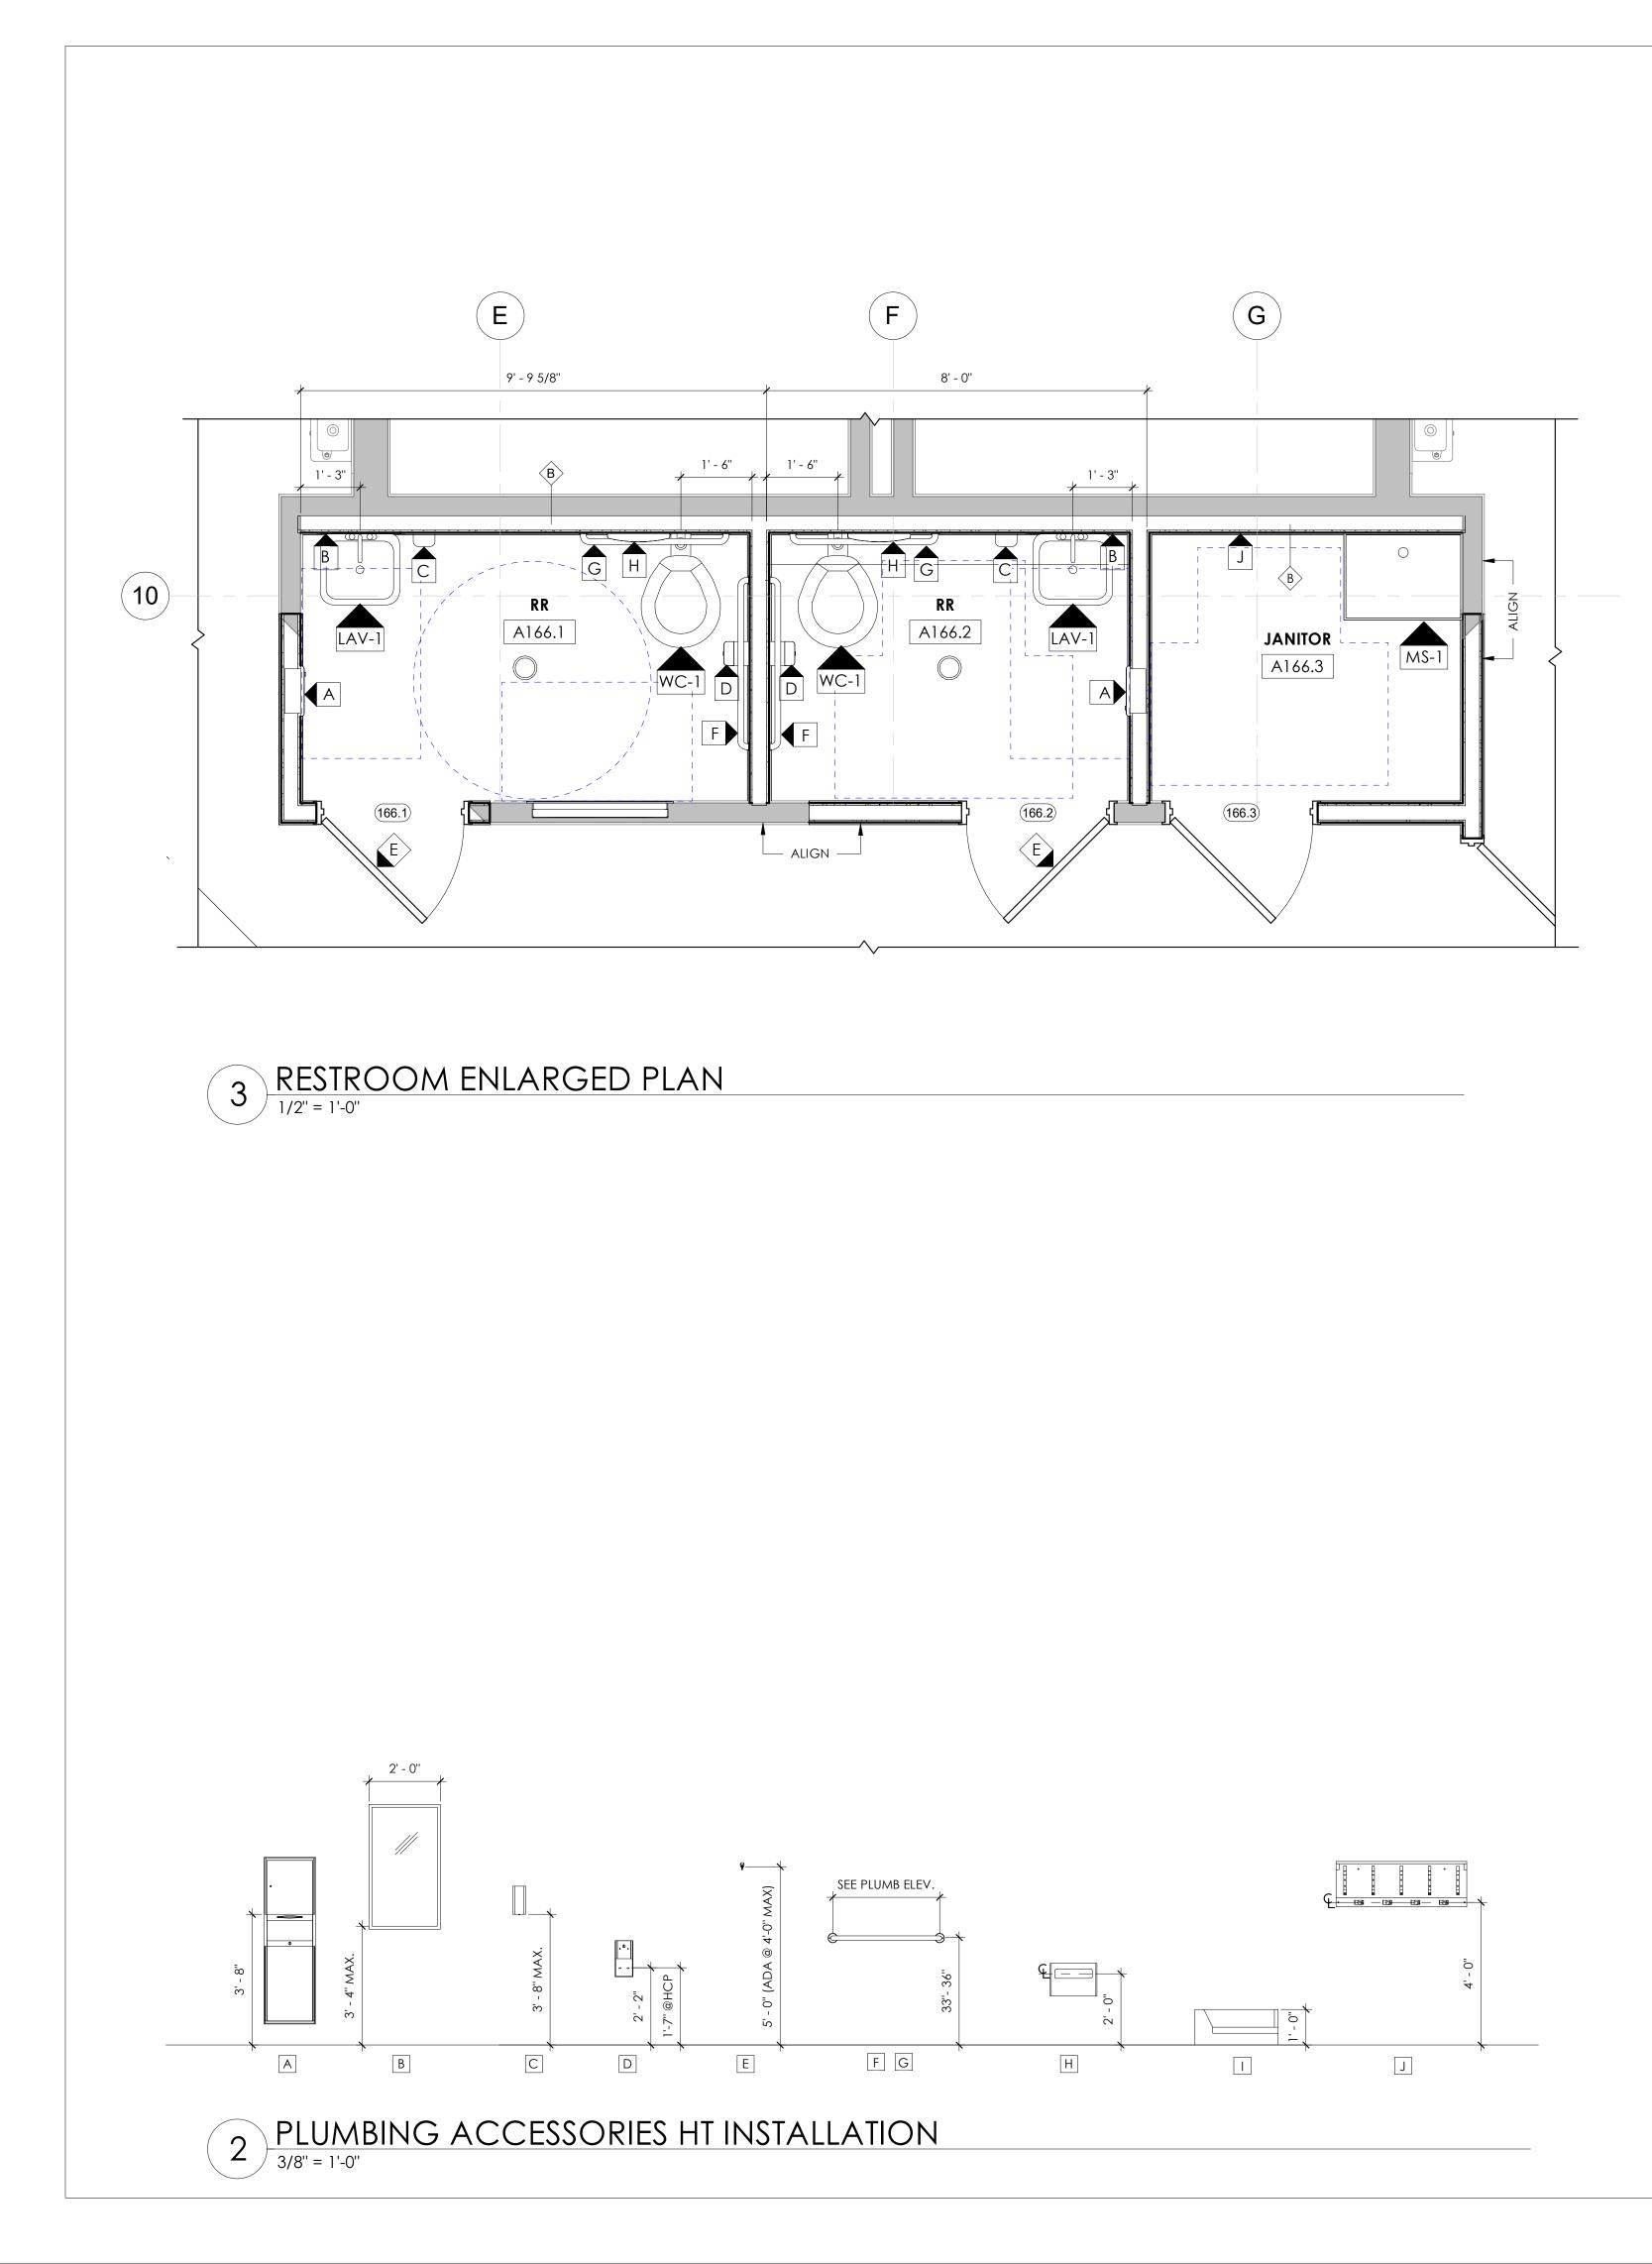


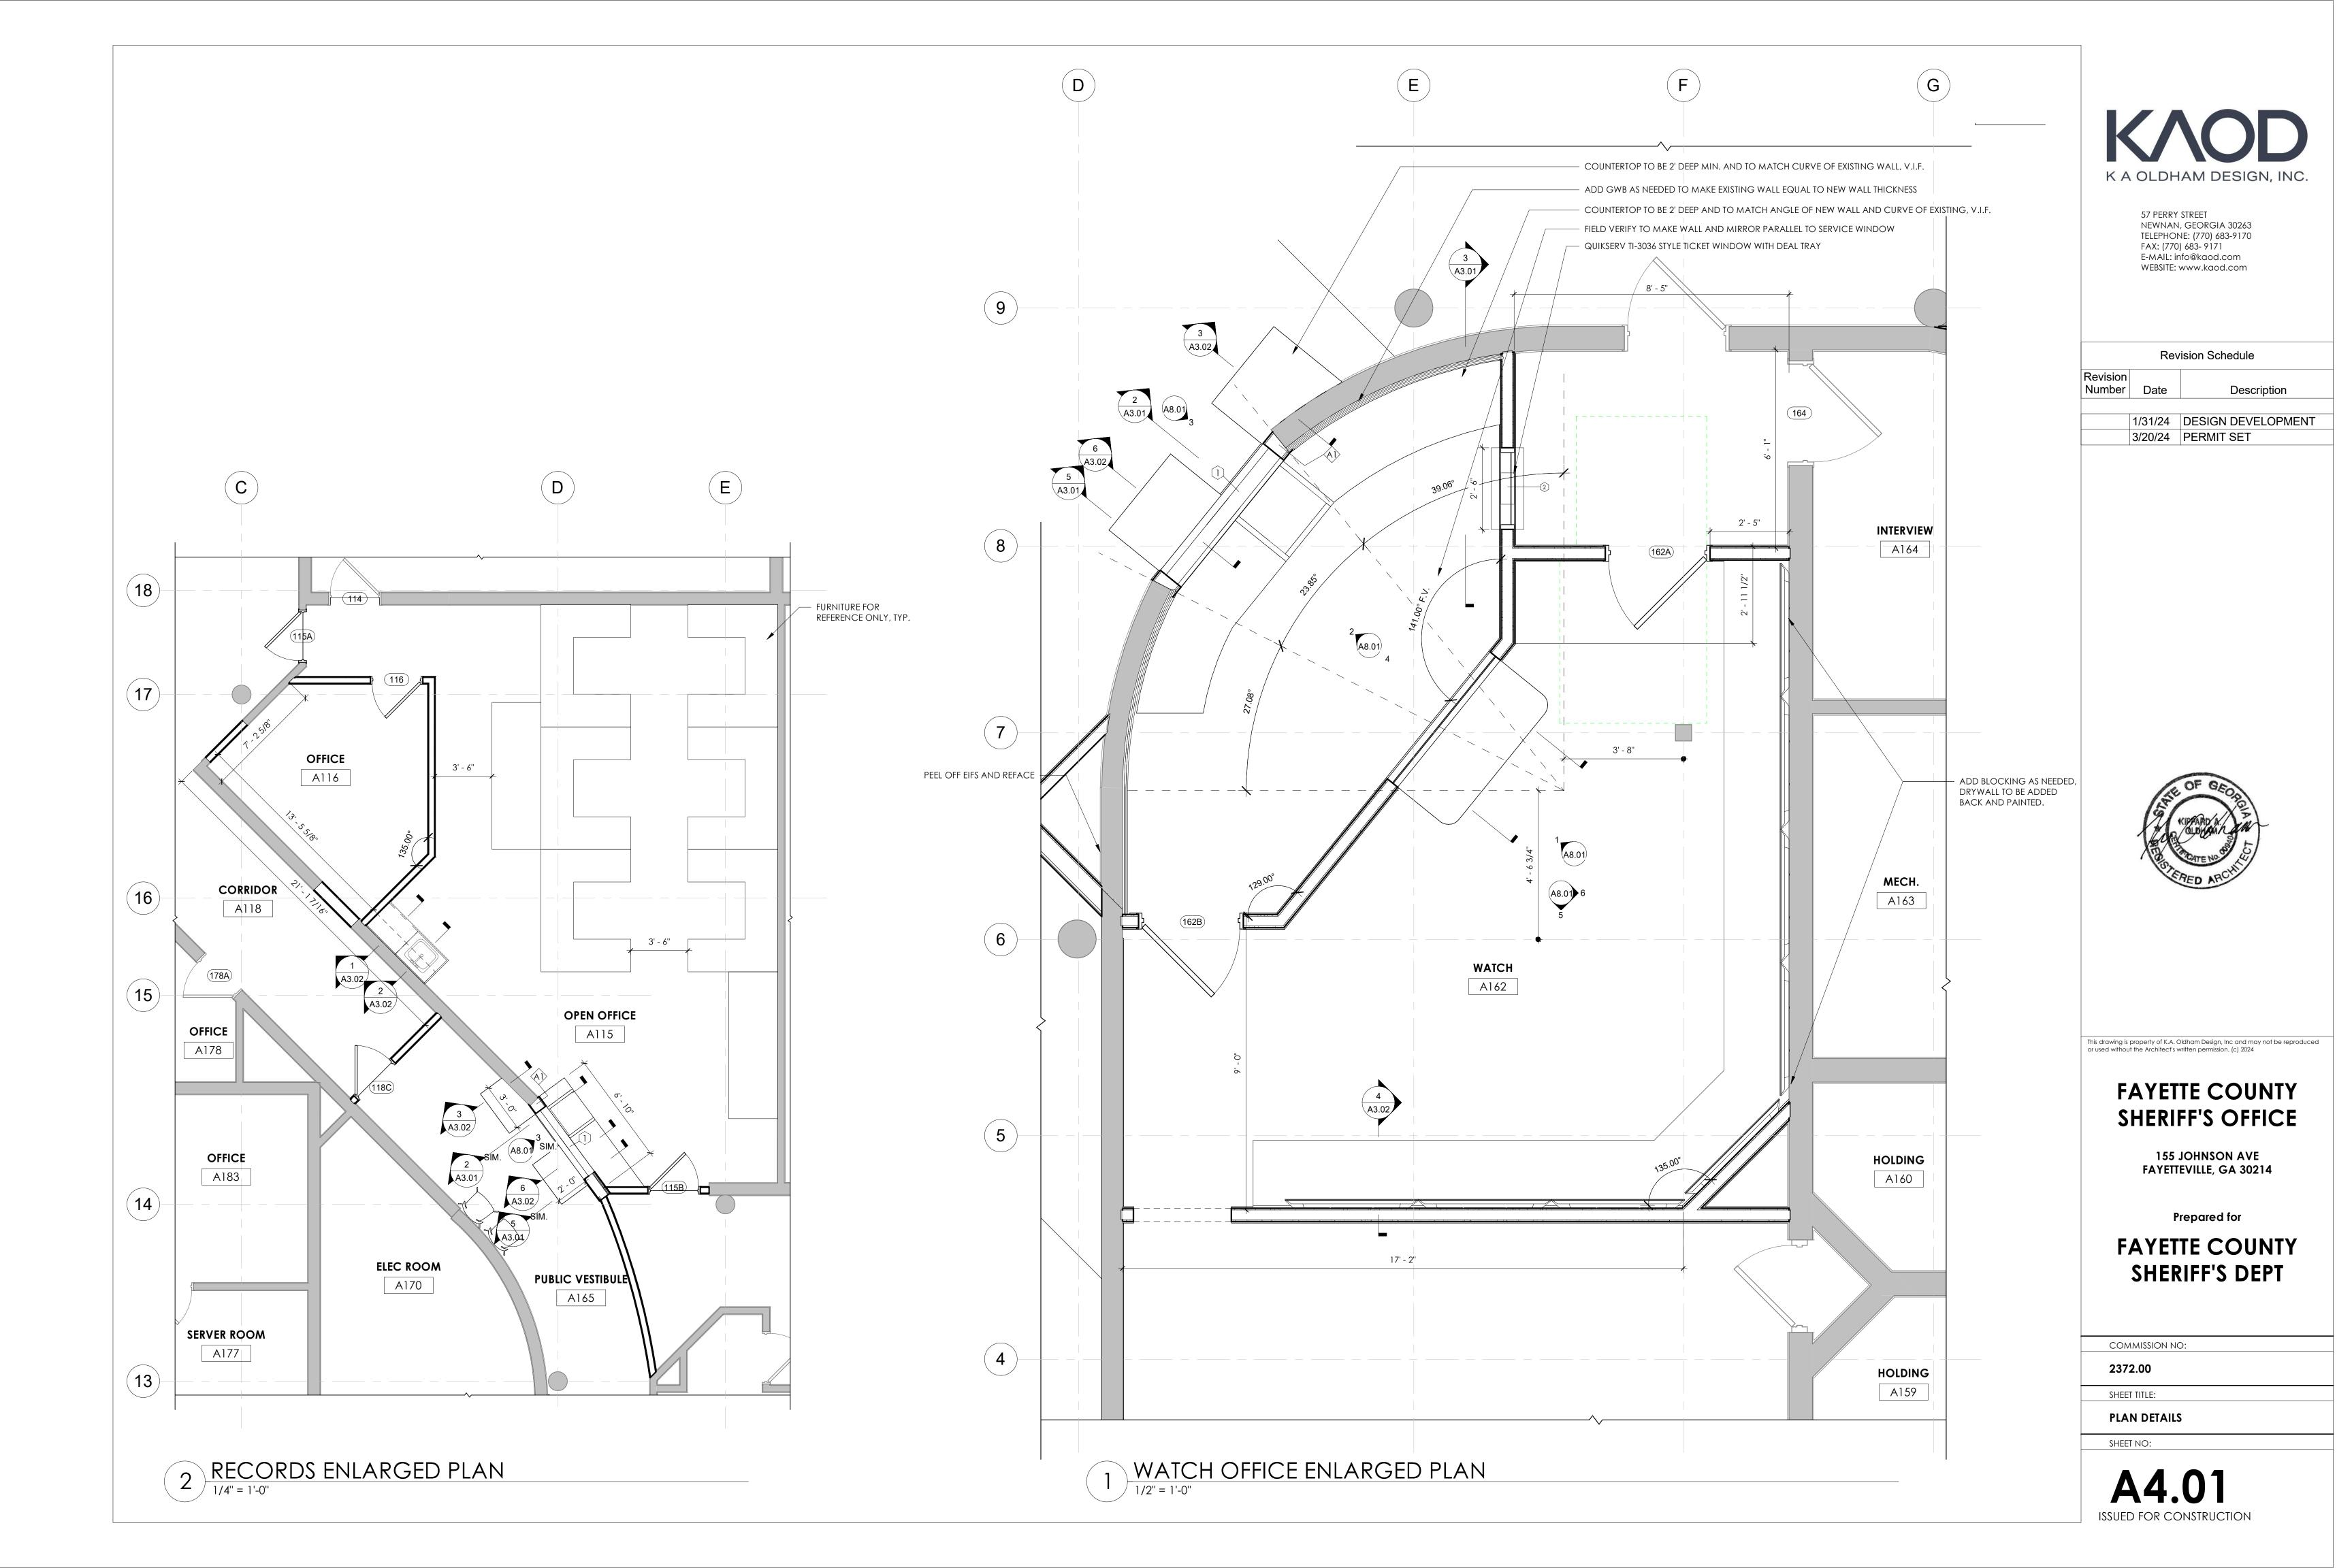
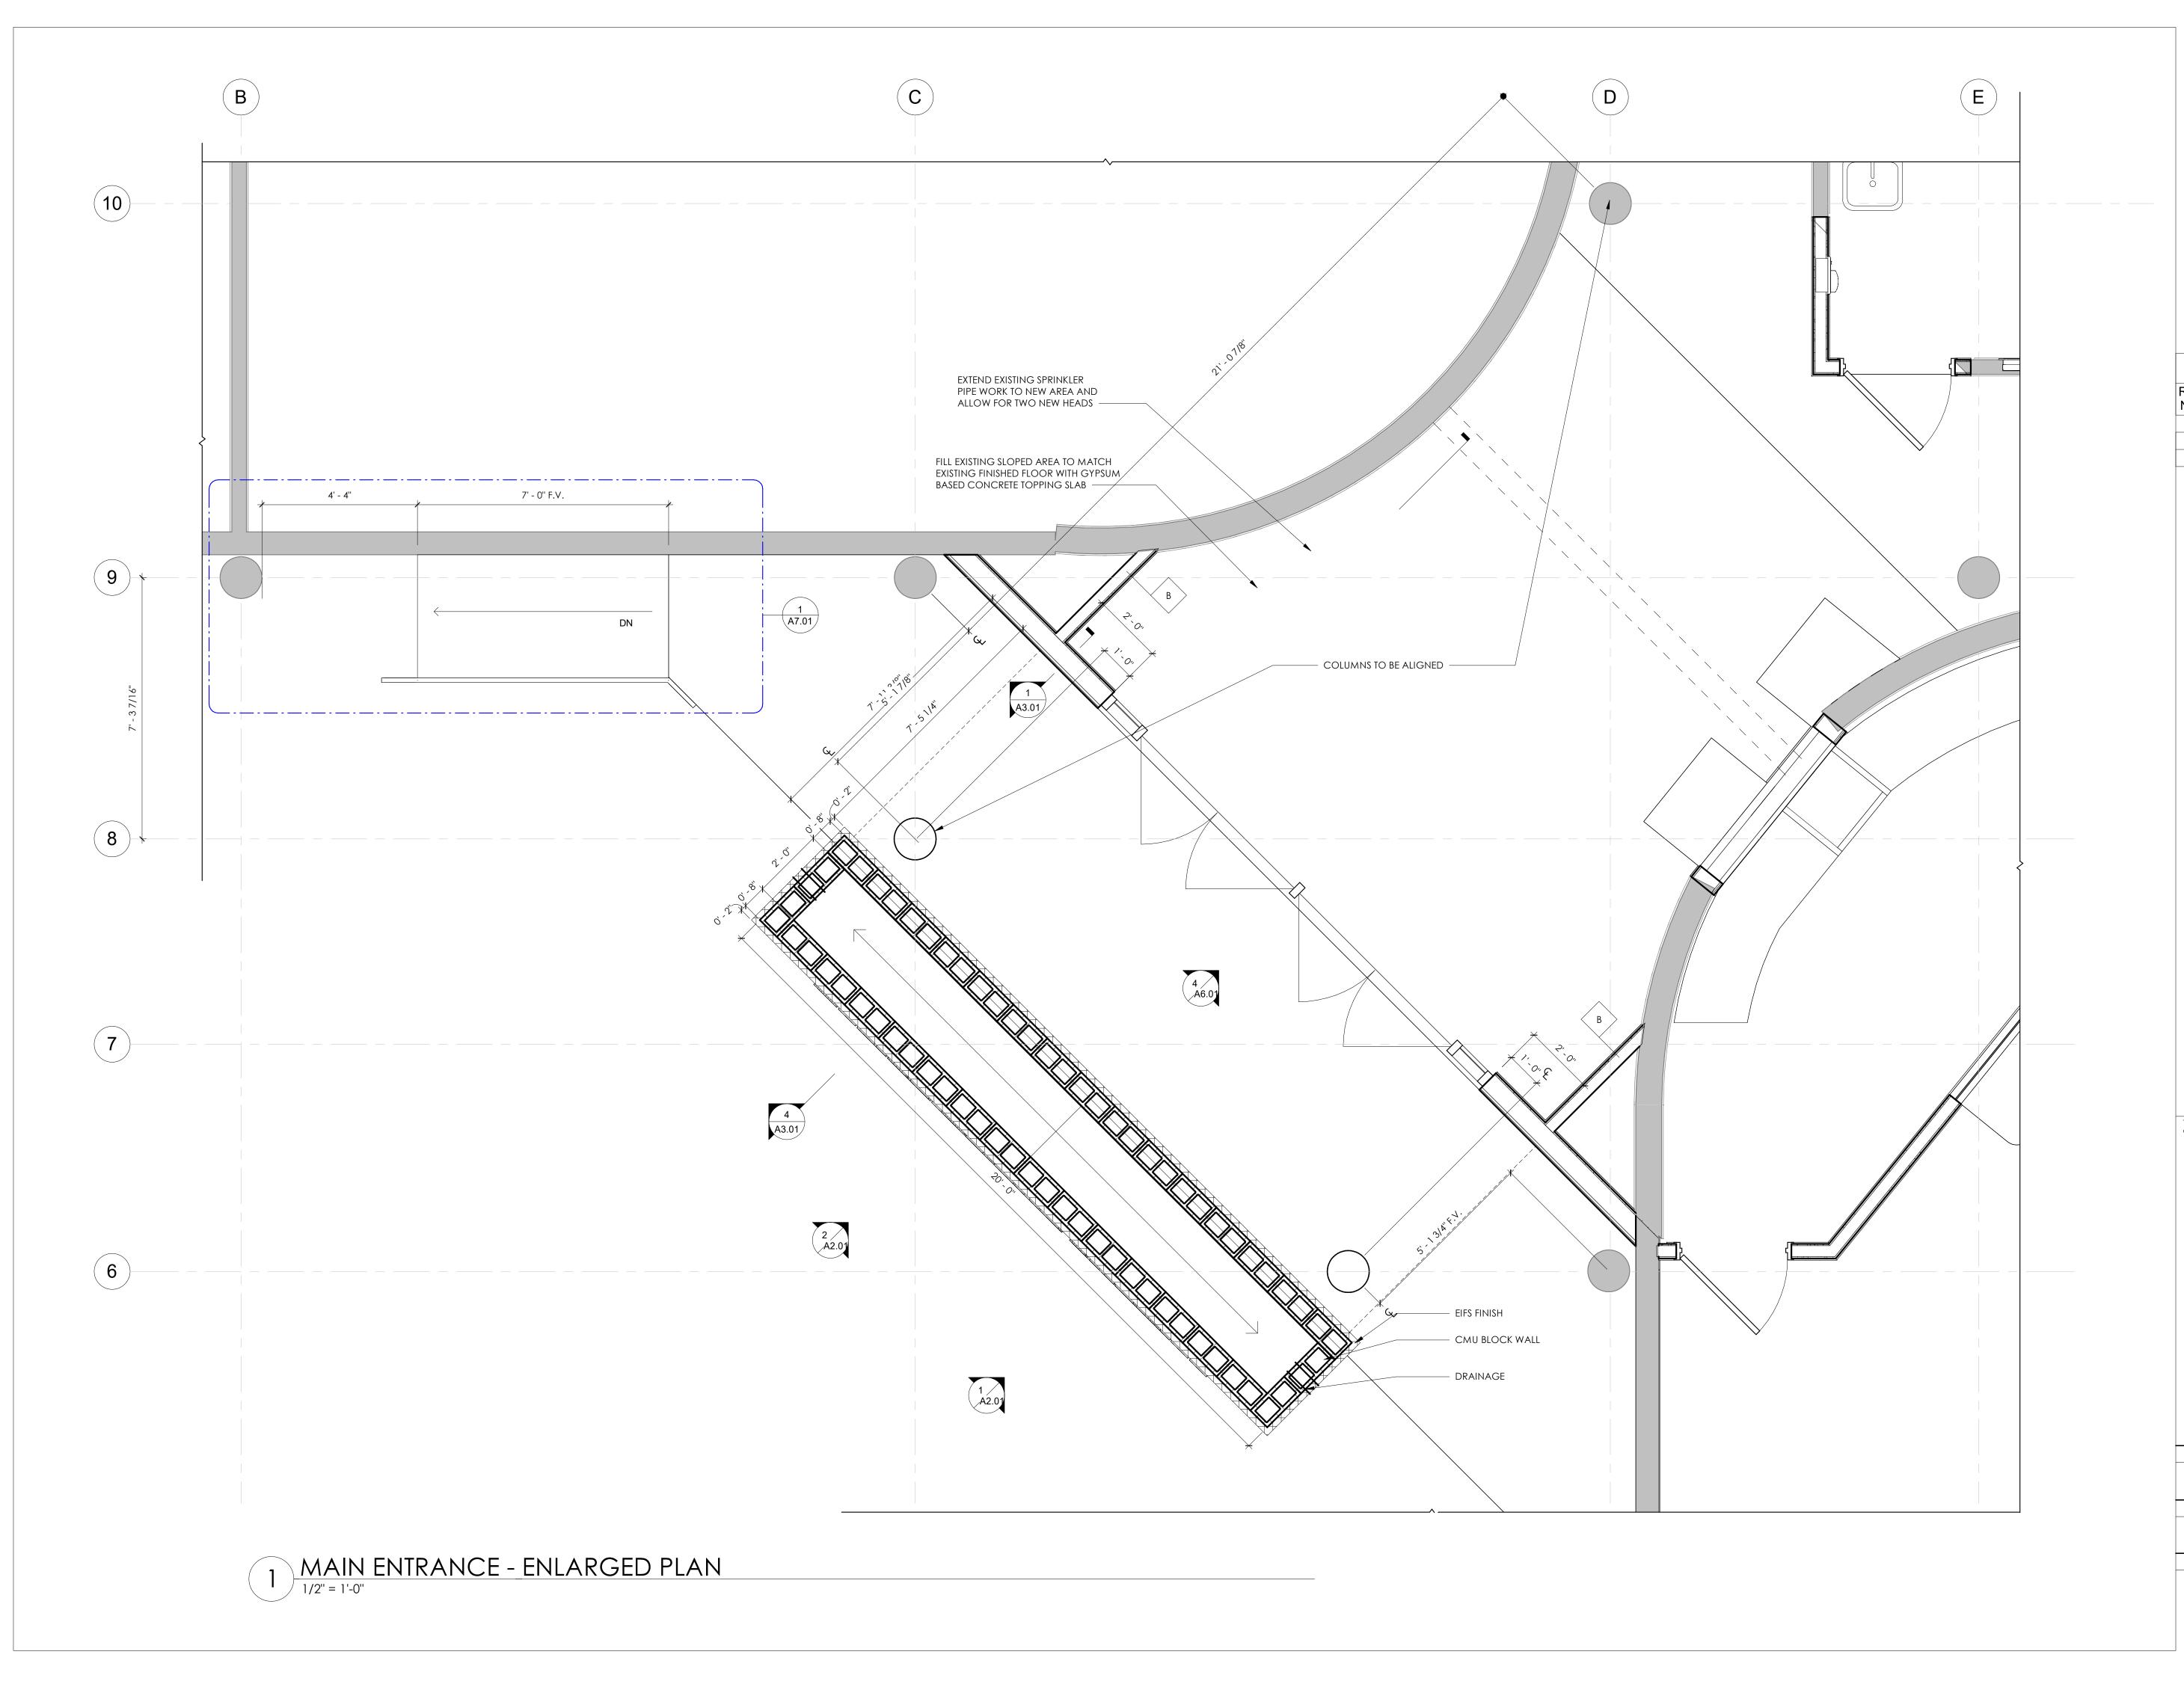
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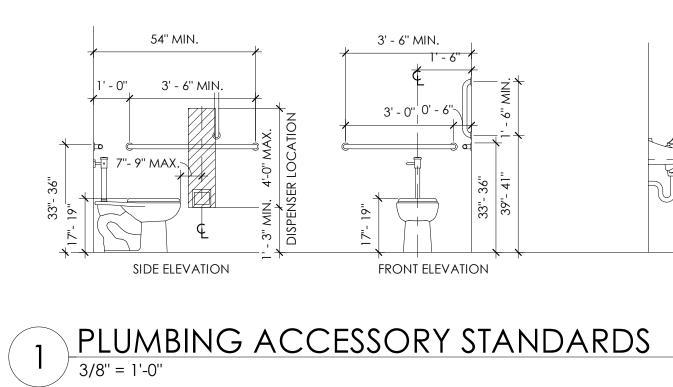


PLUMBING FIXTURE ACCESSORY LIST									
TAG	MANUFACTURER	MODEL #	DESCR						
A	AMERICAN SPECIALTIES	04697-9	TRADI						
В	AMERICAN SPECIALTIES	20650-B2436	TEMPE						
С	AMERICAN SPECIALTIES	20364 ROVAL	SURFA						
D	AMERICAN SPECIALTIES	20030 ROVAL	SURFA						
E	AMERICAN SPECIALTIES	0714	COAT						
F	AMERICAN SPECIALTIES	3801-42	42" GF						
G	AMERICAN SPECIALTIES	3801-36	36'' GF						
Н	AMERICAN SPECIALTIES	20477-SM ROVAL	SURFA						
	•								

PLUMBING FIXTURE SCHEDULE

TAG	FIXTURE	CW	НW	WASTE	VENT	Specification
WC-1	WATER CLOSET- WALL MTD ADA	1"	N/A	4''	2"	KOHLER K-84325 VALVE AND WALI W/ ADA COMPLI.
LAV-1	WALL MOUNTED SINK	1/2"	1/2"	1-1/2"	1-1/4"	WALL MOUNTED WITH SINGLE CEN 410, SINGLE CON
MS-1	MOP SINK- STANDARD	3/4"	3/4"	3"	2''	williams sb-902 and splash cat
FD	FLOOR DRAIN	N/A	N/A	N/A	N/A	JR SMITH 2000 WI BRONZE FINISH. P

EXISTING CONECTION POINTS AND SIZES TO BE FIELD VERIFIED.



CRIPTION

- DITIONAL PAPER TOWEL DISPENSER & WASTE RECEPTACLE SURFACE MOUNTED 1PERED STAINLESS STEEL MIRROR (24" W X 36" H)
- RFACE MOUNTED AUTOMATIC LIQUID SOAP DISPSENSER
- FACE MOUNTED TWIN HIDE-A-ROLL TOILET TISSUE DISPENSER
- AT HOOK
- GRAB BAR W/ CONCEALED FLANGE COVERS
- GRAB BAR W/ CONCEALED FLANGE COVERS
- RFACE MOUNTED TOILET SEAT COVER DISPENSER

ILER K-84325 W/ BEMIS 1655CT SEAT, ZURIN Z6000AV (128 GPF) MANUAL FLUSH LVE AND WALL MOUNTED CARRIER W/ ADA FLOOR MOUNTED UPRIGHTS. PROVIDE ADA COMPLIANT INSTALLATION.

L MOUNTED LAVATORY, AMERICAN STANDARD LUCERNE, MODEL 0355012.020 H SINGLE CENTER FAUCET HOLE, FAUCET SHALL BE CHICAGO FAUCETS MODEL SINGLE CONTROL DECK MOUNTED FAUCET, 0.5 GPM.

LIAMS SB-902 RECEPTOR W/ MOEN 8124 VACUUM BREAK FAUCET TILING FLANGE, D SPLASH CATCHER PANELS.


MITH 2000 WITH 6" TYPE B SQUARE ADJUSTABLE STRAINER WITH SATIN NICKEL ONZE FINISH. PROVIDE WITH VANDAL PROOF SECURED TOP AND TRAP PRIMER.




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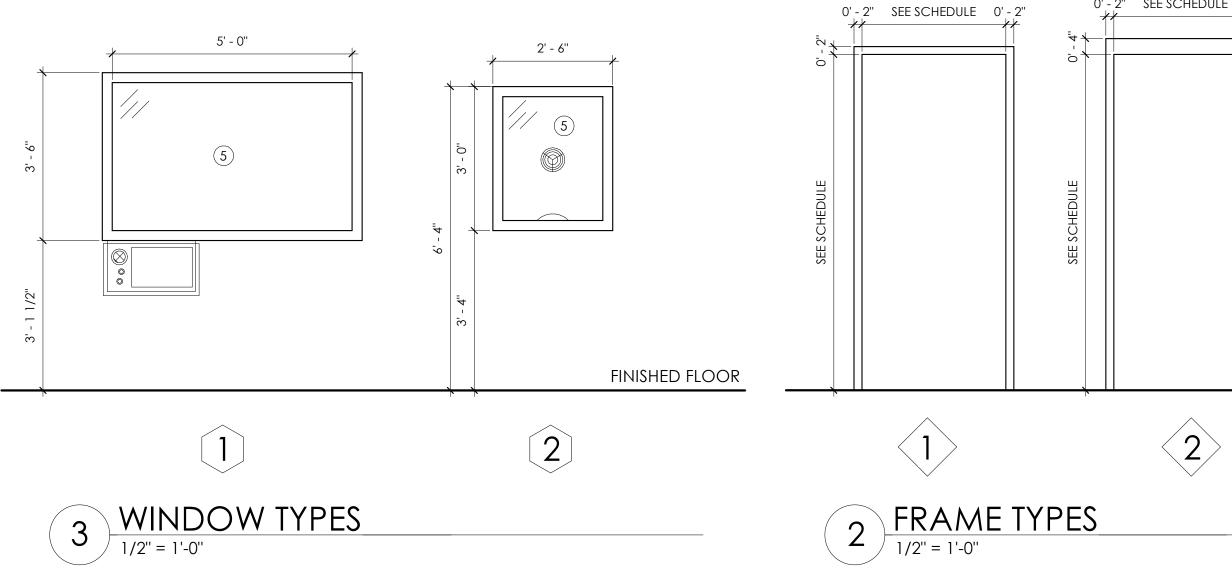
Revision	Rev	vision Schedule
Number	Date	Description
	1/31/24 3/20/24	DESIGN DEVELOPMENT PERMIT SET
		OF GEORE
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		JOHNSON AVE EVILLE, GA 30214
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/		RIFF'S DEPT
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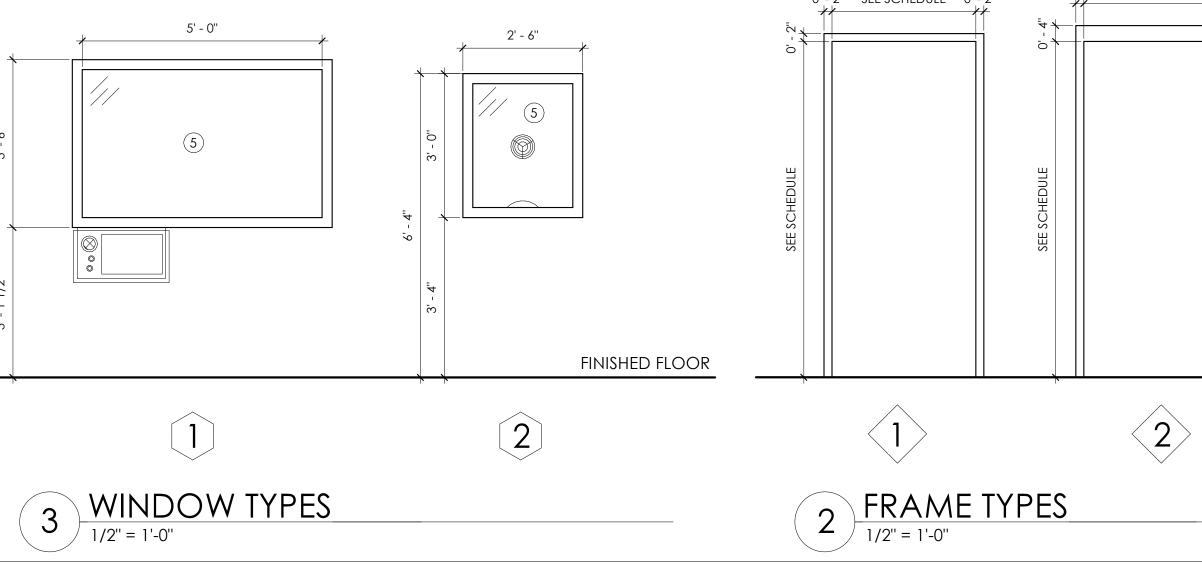


							DOOR S	CHEDULE						
OOR					FIRE		DOOR			FRAME		HDWR		
#	ROOM NAME	WIDTH	HEIGHT	THICKNESS	RATING	TYPE	MATERIAL	FINISH	TYPE	MATERIAL	FINISH	NO.	ADDTL. HARDWARE	COMMENTS
)]	OFFICE	3' - 0''	7' - 0''	0' 12/4"		•	SCWD	STAIN	1	НМ	PAINT	2		
)2	OFFICE	3'-0"	7 - 0	0' - 1 3/4" 0' - 1 3/4"		A	30.00	STAIN	I	H/M	PAINI	3		EXISTING
4	RECORDS	3' - 0''		0' - 1 3/4"										EXISTING
5A	OPEN OFFICE	3' - 0''		0' - 1 3/4"		Α	SCWD	STAIN	1	НМ	PAINT	3		
15B	OPEN OFFICE	3' - 0''	7' - 0''	0' - 1 3/4''		А	SCWD	STAIN	1	НМ	PAINT	3		
6	OFFICE	3' - 0''	7' - 0''	0' - 1 3/4''		А	SCWD	STAIN	1	НМ	PAINT	3		
8A	CORRIDOR	3' - 0''	7' - 0''	0' - 1 3/4''										EXISTING
8B	CORRIDOR	6' - 0''		0' - 2''		B	HM, GLASS	PAINT	2	HM	PAINT	5	SECURE CARD READER	EGRESS
8C		3' - 0''	7' - 0''	0' - 1 3/4"		A	SCWD	STAIN	1	HM	PAINT	4	SECURE CARD READER	
9 20A	TRAINING OFFICE	3' - 0'' 3' - 0''	7' - 0'' 7' - 0''	0' - 1 3/4" 0' - 1 3/4"										EXISTING EXISTING
0A 0B	OFFICE	3' - 0''		0' - 1 3/4"		A	SCWD	STAIN	1	НМ	PAINT	3		EXISTING
1A	GREEN RM	3' - 0''		0' - 1 3/4"		7.	30110	517 (114	1	11/44	174141	0		EXISTING
1B	GREEN RM	2' - 6''		0' - 1 3/4"		Α	SCWD	STAIN	1	НМ	PAINT	3		
8	CORRIDOR	6' - 0''	7' - 0''	0' - 2''		В	HM, GLASS	PAINT	2	НМ	PAINT	5	SECURE CARD READER	EGRESS
9	SHIFT OFFICE	3' - 0''	7' - 0''	0' - 1 3/4''										EXISTING
0	SHIFT OFFICE	3' - 0''		0' - 1 3/4"		А	SCWD	STAIN	1	НМ	PAINT	3		
1	CORRIDOR	3' - 0''		0' - 1 3/4"										EXISTING
53	OFFICE	3' - 0''	7' - 0''	0' - 1 3/4"										EXISTING
54	OFFICE	3' - 0''		0' - 1 3/4"										EXISTING
5 6	OFFICE OFFICE	3' - 0'' 3' - 0''	7' - 0'' 7' - 0''	0' - 1 3/4"										EXISTING
6 7	OFFICE	3 - 0	7 - 0	0' - 1 3/4" 0' - 1 3/4"										EXISTING EXISTING
/ 8	OFFICE	3' - 0''		0' - 1 3/4"										EXISTING
9	HOLDING	3' - 0''	7' - 0''	0' - 1 3/4"										EXISTING
0	HOLDING	3' - 0''		0' - 1 3/4"										EXISTING
1	CORRIDOR	3' - 0''		0' - 1 3/4''										EXISTING
52A	WATCH OFFICE	3' - 0''	7' - 0''	0' - 1 3/4''		А	SCWD	STAIN	1	НМ	PAINT	4	SECURE CARD READER	
52B	WATCH OFFICE	3' - 0''	7' - 0''	0' - 1 3/4''		А	SCWD	STAIN	1	HM	PAINT	3		
52C	WATCH OFFICE	0' - 0''	0' - 0''											CASED OPENING
52D	WATCH OFFICE	3' - 0''		0' - 1 3/4"										EXISTING
53		3' - 0''		0' - 1 3/4"										EXISTING
54	INTERVIEW PUBLIC VESTIBULE	3' - 0'' 6' - 0''	7' - 0'' 7' - 0''	0' - 1 3/4"		2/4/ 01	224 12 441114	MANUF.	2/4/01		A 1 1 1 A A		SECURE CARD READER	EXISTING EGRESS
5A 5B	PUBLIC VESTIBULE	6' - 0''	7 - 0			3/A6.01 3/A6.01	ALUM, GLASS ALUM, GLASS	MANUF. MANUF.	3/A6.01 3/A6.01	ALUM. ALUM.	ALUM.		SECURE CARD READER	EGRESS
55C	PUBLIC VESTIBULE	3' - 0''		0' - 1 3/4''		5/ 70.01	ALOM, OLASS		3/70.01	ALOM.	ALUM.	4	SECURE CARD READER	EXISTING
5D	PUBLIC VESTIBULE	3' - 0''		0' - 1 3/4"		Α	SCWD	STAIN	1	НМ	ALUM.	4	SECURE CARD READER	
6.1	RR	3' - 0''	-	0' - 1 3/4"		А	SCWD	STAIN	1	НМ	PAINT	1		
6.2	RR	3' - 0''		0' - 1 3/4''		А	SCWD	STAIN	1	НМ	PAINT	1		
6.3	JANITOR	3' - 0''		0' - 1 3/4"		А	SCWD	STAIN	1	НМ	PAINT	2		
8	EMPLOYEE RESTROOM	3' - 0''	-	0' - 1 3/4''										EXISTING
9	EMPLOYEE RESTROOM	3' - 0''		0' - 1 3/4"										EXISTING
1A		3' - 0''		0' - 1 3/4"										EXISTING
1B		3' - 0"		0' - 1 3/4"										EXISTING
1C 2	TV ROOM OFFICE	3' - 0'' 3' - 0''		0' - 1 3/4" 0' - 1 3/4"										existing existing
<u>2</u> 3	OFFICE	3 - 0		0' - 1 3/4										EXISTING
3 4	OFFICE	3'-0"		0' - 1 3/4"										EXISTING
- 5A	OFFICE	3' - 0''		0' - 1 3/4"										EXISTING
5B	OFFICE	2' - 6''		0' - 1 3/4"										EXISTING
6	CORRIDOR	3' - 0''		0' - 1 3/4''										EXISTING
7	SERVER ROOM	3' - 0''	7' - 0''	0' - 1 3/4''										EXISTING
8A	OFFICE	3' - 0''		0' - 1 3/4"										EXISTING
8B	OFFICE	3' - 0''		0' - 1 3/4''										EXISTING
9	RR	3' - 0''		0' - 1 3/4"										EXISTING
1	CONF. RM	3' - 0''		0' - 1 3/4"										EXISTING
32 33	STORAGE OFFICE	3' - 0'' 3' - 0''		0' - 1 3/4" 0' - 1 3/4"										existing existing



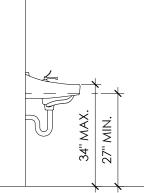




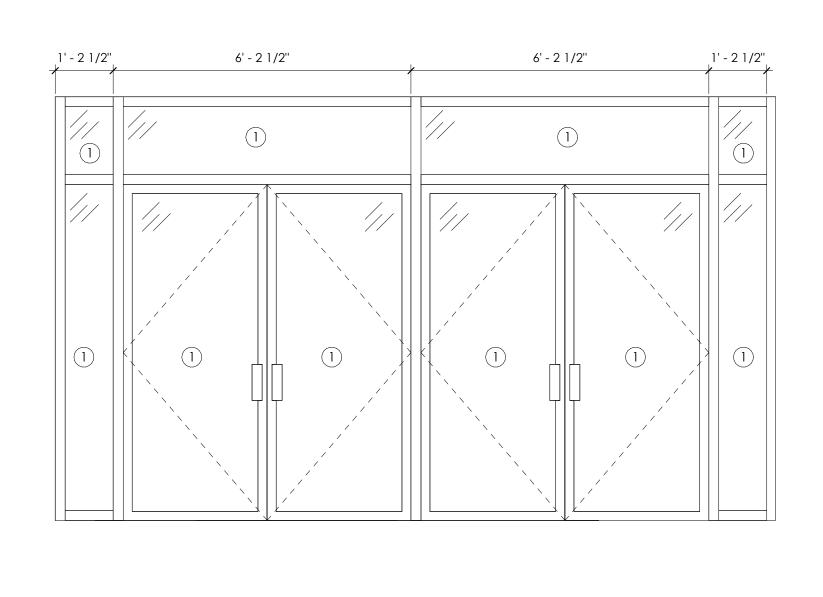

REA	MARKS
A. B. C. D. E.	PROVIDE THRESHOLD AND WEATHERSTRIPPING ON INTERIOR DOOR. PROVIDE AUTOMATIC DOOR OPERATOR PROVIDE SOUND GASKETING AND AUTOMATIC DOOR BOTTOM PROVIDE SWEEP AT DOOR BOTTOM AS REQ'D TO MAINTAIN SMOKE-TIGHT INTERGRITY OF OPENING PROVIDE ELECTRIFIED HOLD-OPEN DEVICES
<u>GL</u>	AZING LEGEND
1	1" INSULATED TEMPERED (2) 1" INSULATED (3) 1/4" CLEAR TEMPERED (4) 1/4" CLEAR
WI	NDOW GENERAL NOTES:
1. 2. 3. 4.	TEMPERED GLAZING SHALL BE PROVIDED IN ALL LOCATIONS WHERE WINDOWS OR GLAZING IS LOCATE SEE WINDOW ELEVATIONS FOR GLAZING TYPES. SECTIONS THROUGH WINDOW MEMBERS ARE SHOWN SCHEMATICALLY - ACTUAL CONFIGURATIONS MA ROUGH OPENINGS ARE SHOWN ON WINDOW ELEVATIONS. ACTUAL WINDOW UNITS SHOULD BE CONST

FIELD VERIFY ALL DIMENSIONS PRIOR TO FABRICATION. WINDOW MFR. SHALL BE RESPONSIBLE FOR PROVIDING ANY ADDITIONAL MULLION REINFORCEMENT NECESSARY TO MEET ALL SPECIFIED LOADING CRITERIA.

0' - 2" SEE SCHEDULE 0' - 2"

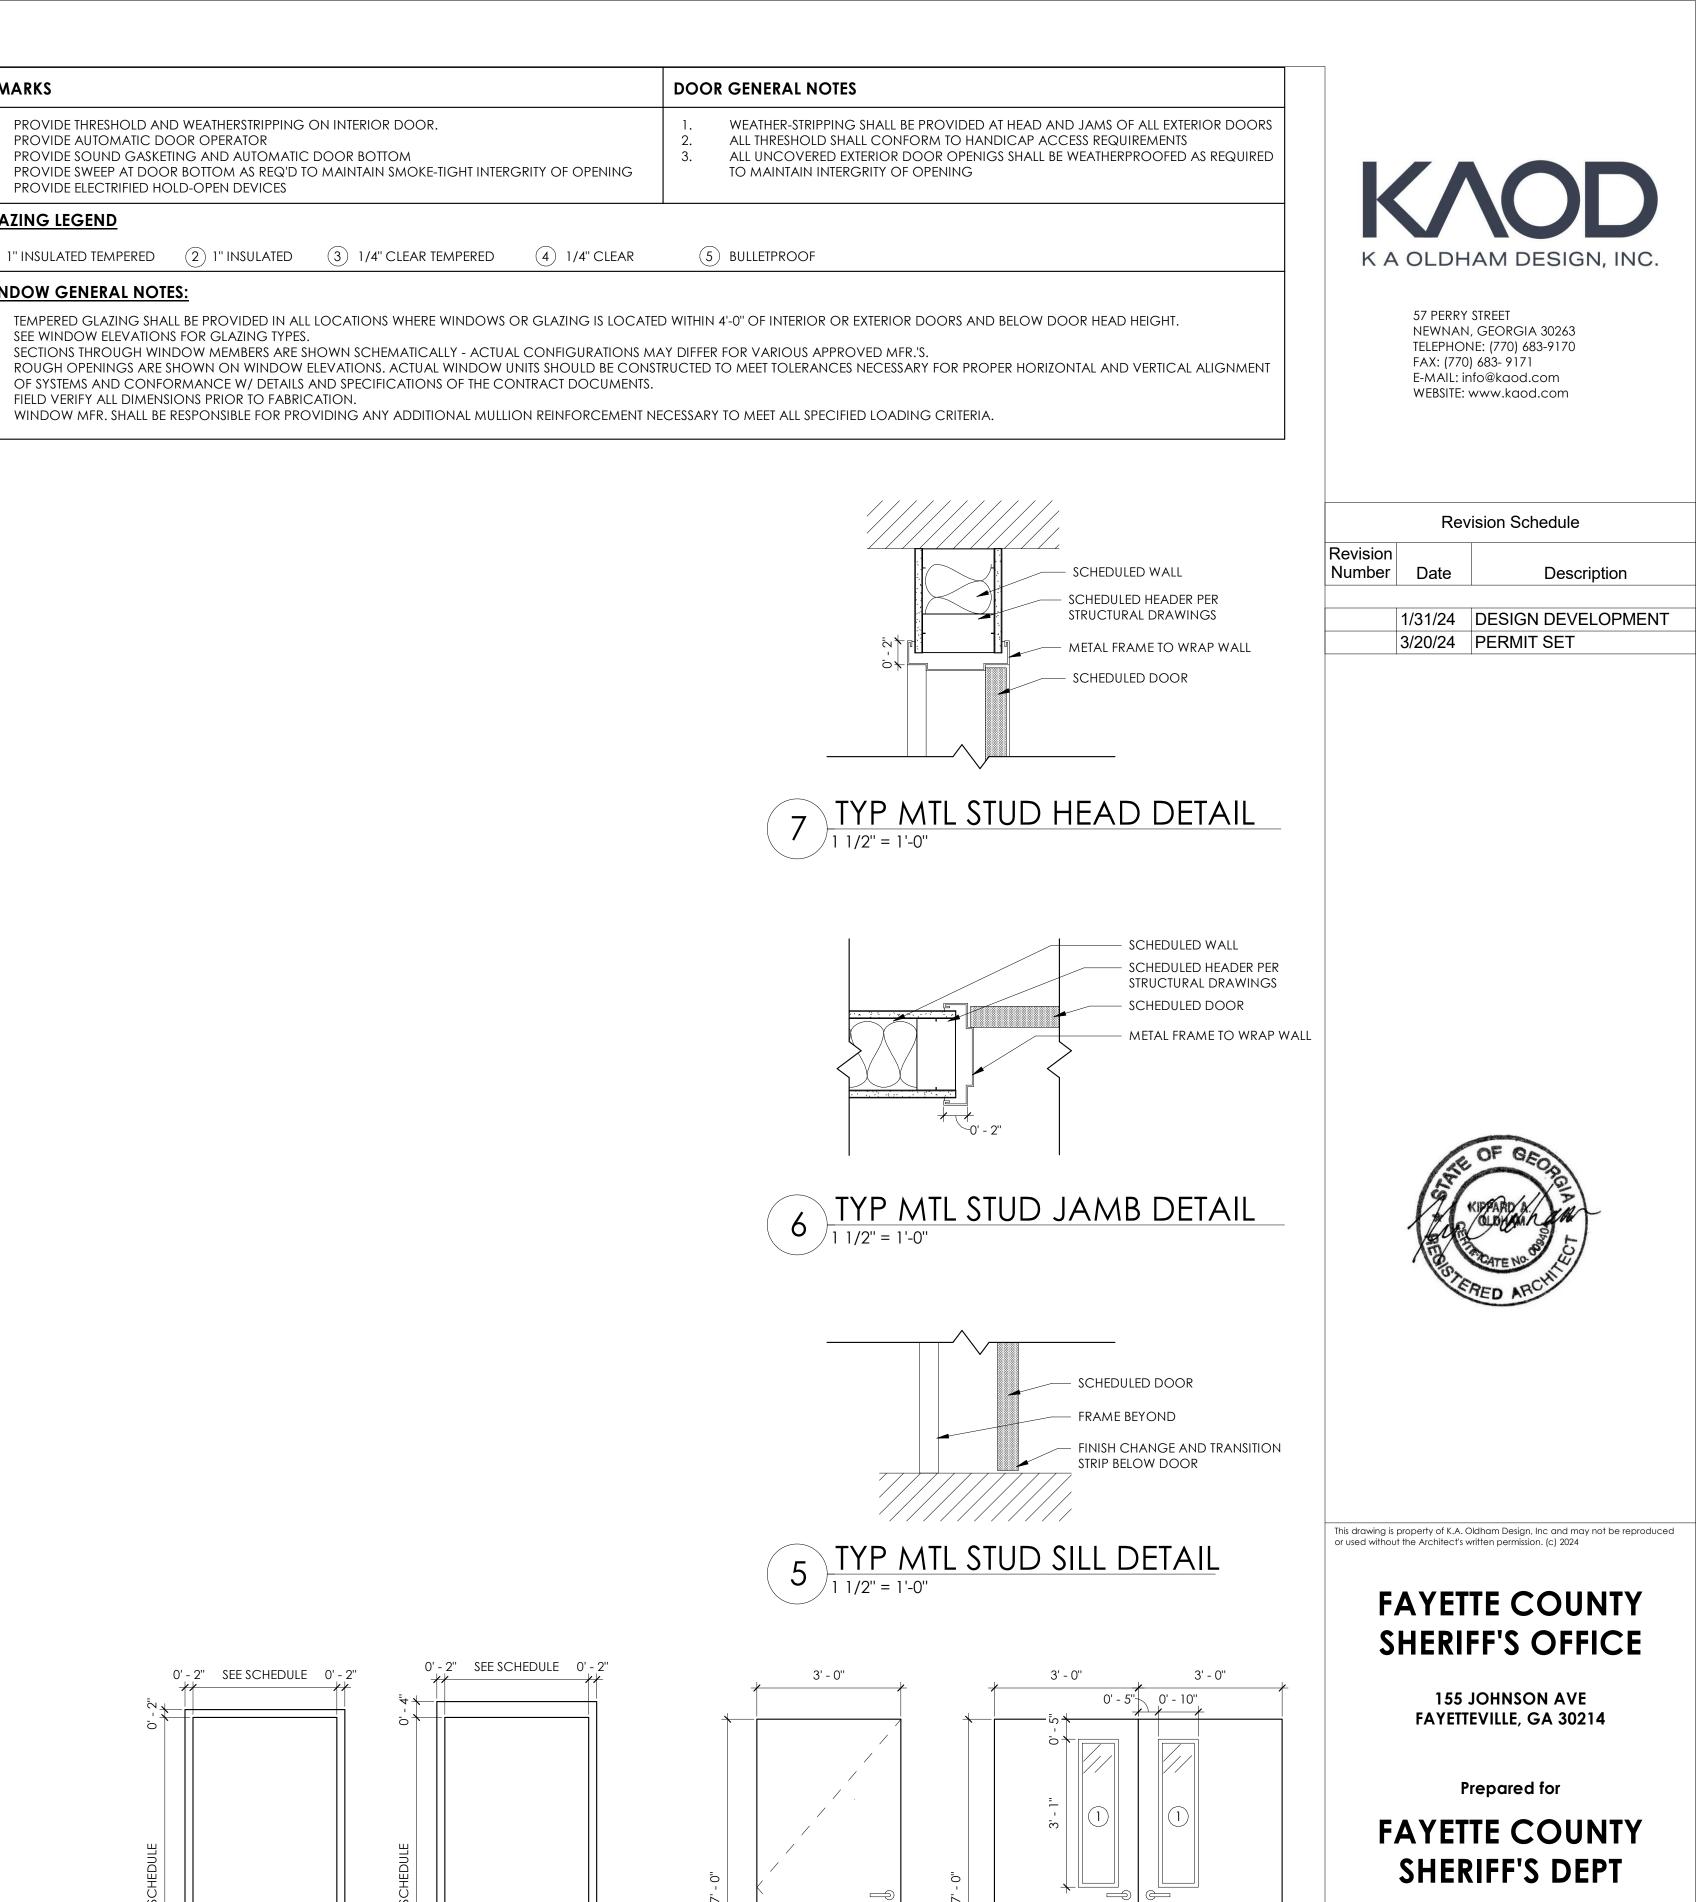

COMMISSION NO:

DOOR/ WINDOW SCHEDULE


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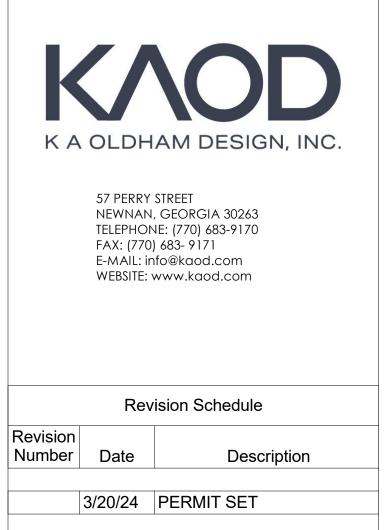


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Revision Number	Revision Schedule Date Description 3/20/24 PERMIT SET						
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F.	Prepared for AYETTE COUNTY SHERIFF'S DEPT						
237 . SHEE	1MISSION NO: 2.00 T TITLE: SH PLAN						
SHEE	T NO:						
	\6.10						

			FINIS	H SCHEDULI	E			
			FLC	ORS	WALLS			
ROOM NO.	ROOM NAME	FLOOR	BASE	GROUT	COMMENTS	FINISH	GROUT	COMMENTS
.101	OFFICE	LVP-2	RB-1			PT-1		
102	OFFICE				EXISTING			EXISITNG
107	SHERIFF'S OFFICE				EXISTING			EXISITNG
108	SHERIFF'S CONFERENCE ROOM				EXISTING			EXISITNG
114	RECORDS				EXISTING			EXISITNG
115	OPEN OFFICE	LVP-2	RB-1			PT-1		
116	OFFICE	LVP-2	RB-1			PT-1		
118	CORRIDOR				EXISTING	PT-1		EXISITNG
119	TRAINING				EXISTING			EXISITNG
120	OFFICE				EXISTING			EXISITNG
121	GREEN RM				EXISTING			EXISITNG
148	CORRIDOR	LVP-2	RB-1		EXISTING	PT-1		EXISITNG
149	SHIFT OFFICE				EXISTING			EXISITNG
150	SHIFT OFFICE	LVP-2	RB-1			PT-1		
151	CORRIDOR				EXISTING	PT-1		EXISITNG
152	OFFICE				EXISTING	PT-1		EXISITNG
153	OFFICE				EXISTING			EXISITNG
154	OFFICE				EXISTING			EXISITNG
155	OFFICE				EXISTING			EXISITNG
156	OFFICE				EXISTING			EXISITNG
157	OFFICE				EXISTING			EXISITNG
158	OFFICE				EXISTING			EXISITNG
159	HOLDING				EXISTING			EXISITNG
160	HOLDING				EXISTING			EXISITNG
161	CLO.				EXISTING			EXISITNG
162	WATCH	LVP-2	RB-1			PT-1		
163	MECH.				EXISTING			EXISITNG
164	INTERVIEW	LVP-2	RB-1			PT-1		
165	PUBLIC VESTIBULE	TL-1, LVP-2	TL-2, RB-1	GR-1		PT-1		
166.1	RR	LVP-1	RB-1			PT-1, PT-3		
166.2	RR	LVP-1	RB-1			PT-1, PT-3		
166.3	JANITOR	LVP-1	RB-1			PT-1, PT-3		
168	EMPLOYEE RESTROOM				EXISTING			EXISITNG
169	EMPLOYEE RESTROOM				EXISTING			EXISITNG
170	ELEC ROOM				EXISTING			EXISITNG
171	TV ROOM				EXISTING			EXISITNG
172	OFFICE				EXISTING			EXISITNG
173	OFFICE				EXISTING			EXISITNG
174	OFFICE				EXISTING			EXISITNG
175	OFFICE				EXISTING			EXISITNG
176	CORRIDOR				EXISTING			EXISITNG
177	SERVER ROOM				EXISTING			EXISITNG
178	OFFICE				EXISTING			EXISITNG
179	RR				EXISTING			EXISITNG
181	CONF. RM				EXISTING			EXISITNG
182	STORAGE				EXISTING			EXISITNG
183	OFFICE				EXISTING			EXISITNG
185	WAITING				EXISTING			EXISITNG

			INTERIOR FINIS
KEYNOTE	MATERIAL	MANUFACTURER	COLOR/FINISH
WALL FINI	SHES		
PT-1	PAINT	SHERWIN WILLIAMS	SW 7014 EIDER WHITE
PT-2	PAINT	SHERWIN WILLIAMS	SW 7018 DOVETAIL
ST-1	STAIN	MINWAX	MATCH PL-1
PT-3	PAINT	SHERWIN WILLIAMS	SW 7014 EIDER WHITE
FLOOR FI	NISHES		
TL-1	TILE	DALTILE	COHESION, DARK GREY CO26
GR-1	GROUT	MAPEI	PEARL GRAY 5019
LVP-1	LUXURY VINYL PLANK	KARNDEAN	OPUS WOOD, WEATHERED ELM WP511
LVP-2	LUXURY VINYL PLANK	KARNDEAN	KORLOK RESERVE, SMOKED AMERICAN MAPLE RCP6545
WALL BAS	E FINISHES		
RB-1	RUBBER BASE		
TL-2	TILE BASE	DALTILE	COHESION, DARK GREY CO26
CEILING F	INISHES		
CT-1	CEILING TILE	ARMSTRONG	WHITE
PT-4	CEILING PAINT	Sherwin Williams	SW 7004 SNOWBOUND
MILLWOR	K CABINET FINISHES		
PL-1	PLASTIC LAMINATE	WILSONART	EBONY RECON 7997-38
SS-2	SOLID SURFACE	FORMICA	415 LUNA STEEL
MILLWOR	K COUNTER FINISHES		
SS-1	SOLID SURFACE	HI-MACS	WHITE QUARTZ G004

DESCRIPTION AND NOTES	CONTACT
GENERAL PAINT	
DOOR TRIM/ WINDOW TRIM PAINT	
DOOR STAIN	
EPOXY PAINT FOR RESTROOM WET WALLS	
12X24 FLOOR TILE	
USE W/ TL-1	
MATCH EXISTING	
S36C9 COVE BASE 6X12	
OPTIMA LAY-IN AND TEGULAR	
HARD CEILING PAINT	

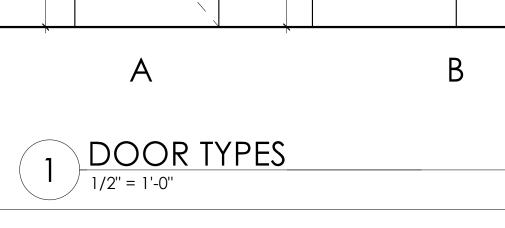



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FAYETTE COUNTY SHERIFF'S OFFICE

155 JOHNSON AVE FAYETTEVILLE, GA 30214

Prepared for

FAYETTE COUNTY

SHERIFF'S DEPT

COMMISSION NO:


2372.00

SHEET TITLE:

FINISH SCHEDULE AND LEGEND


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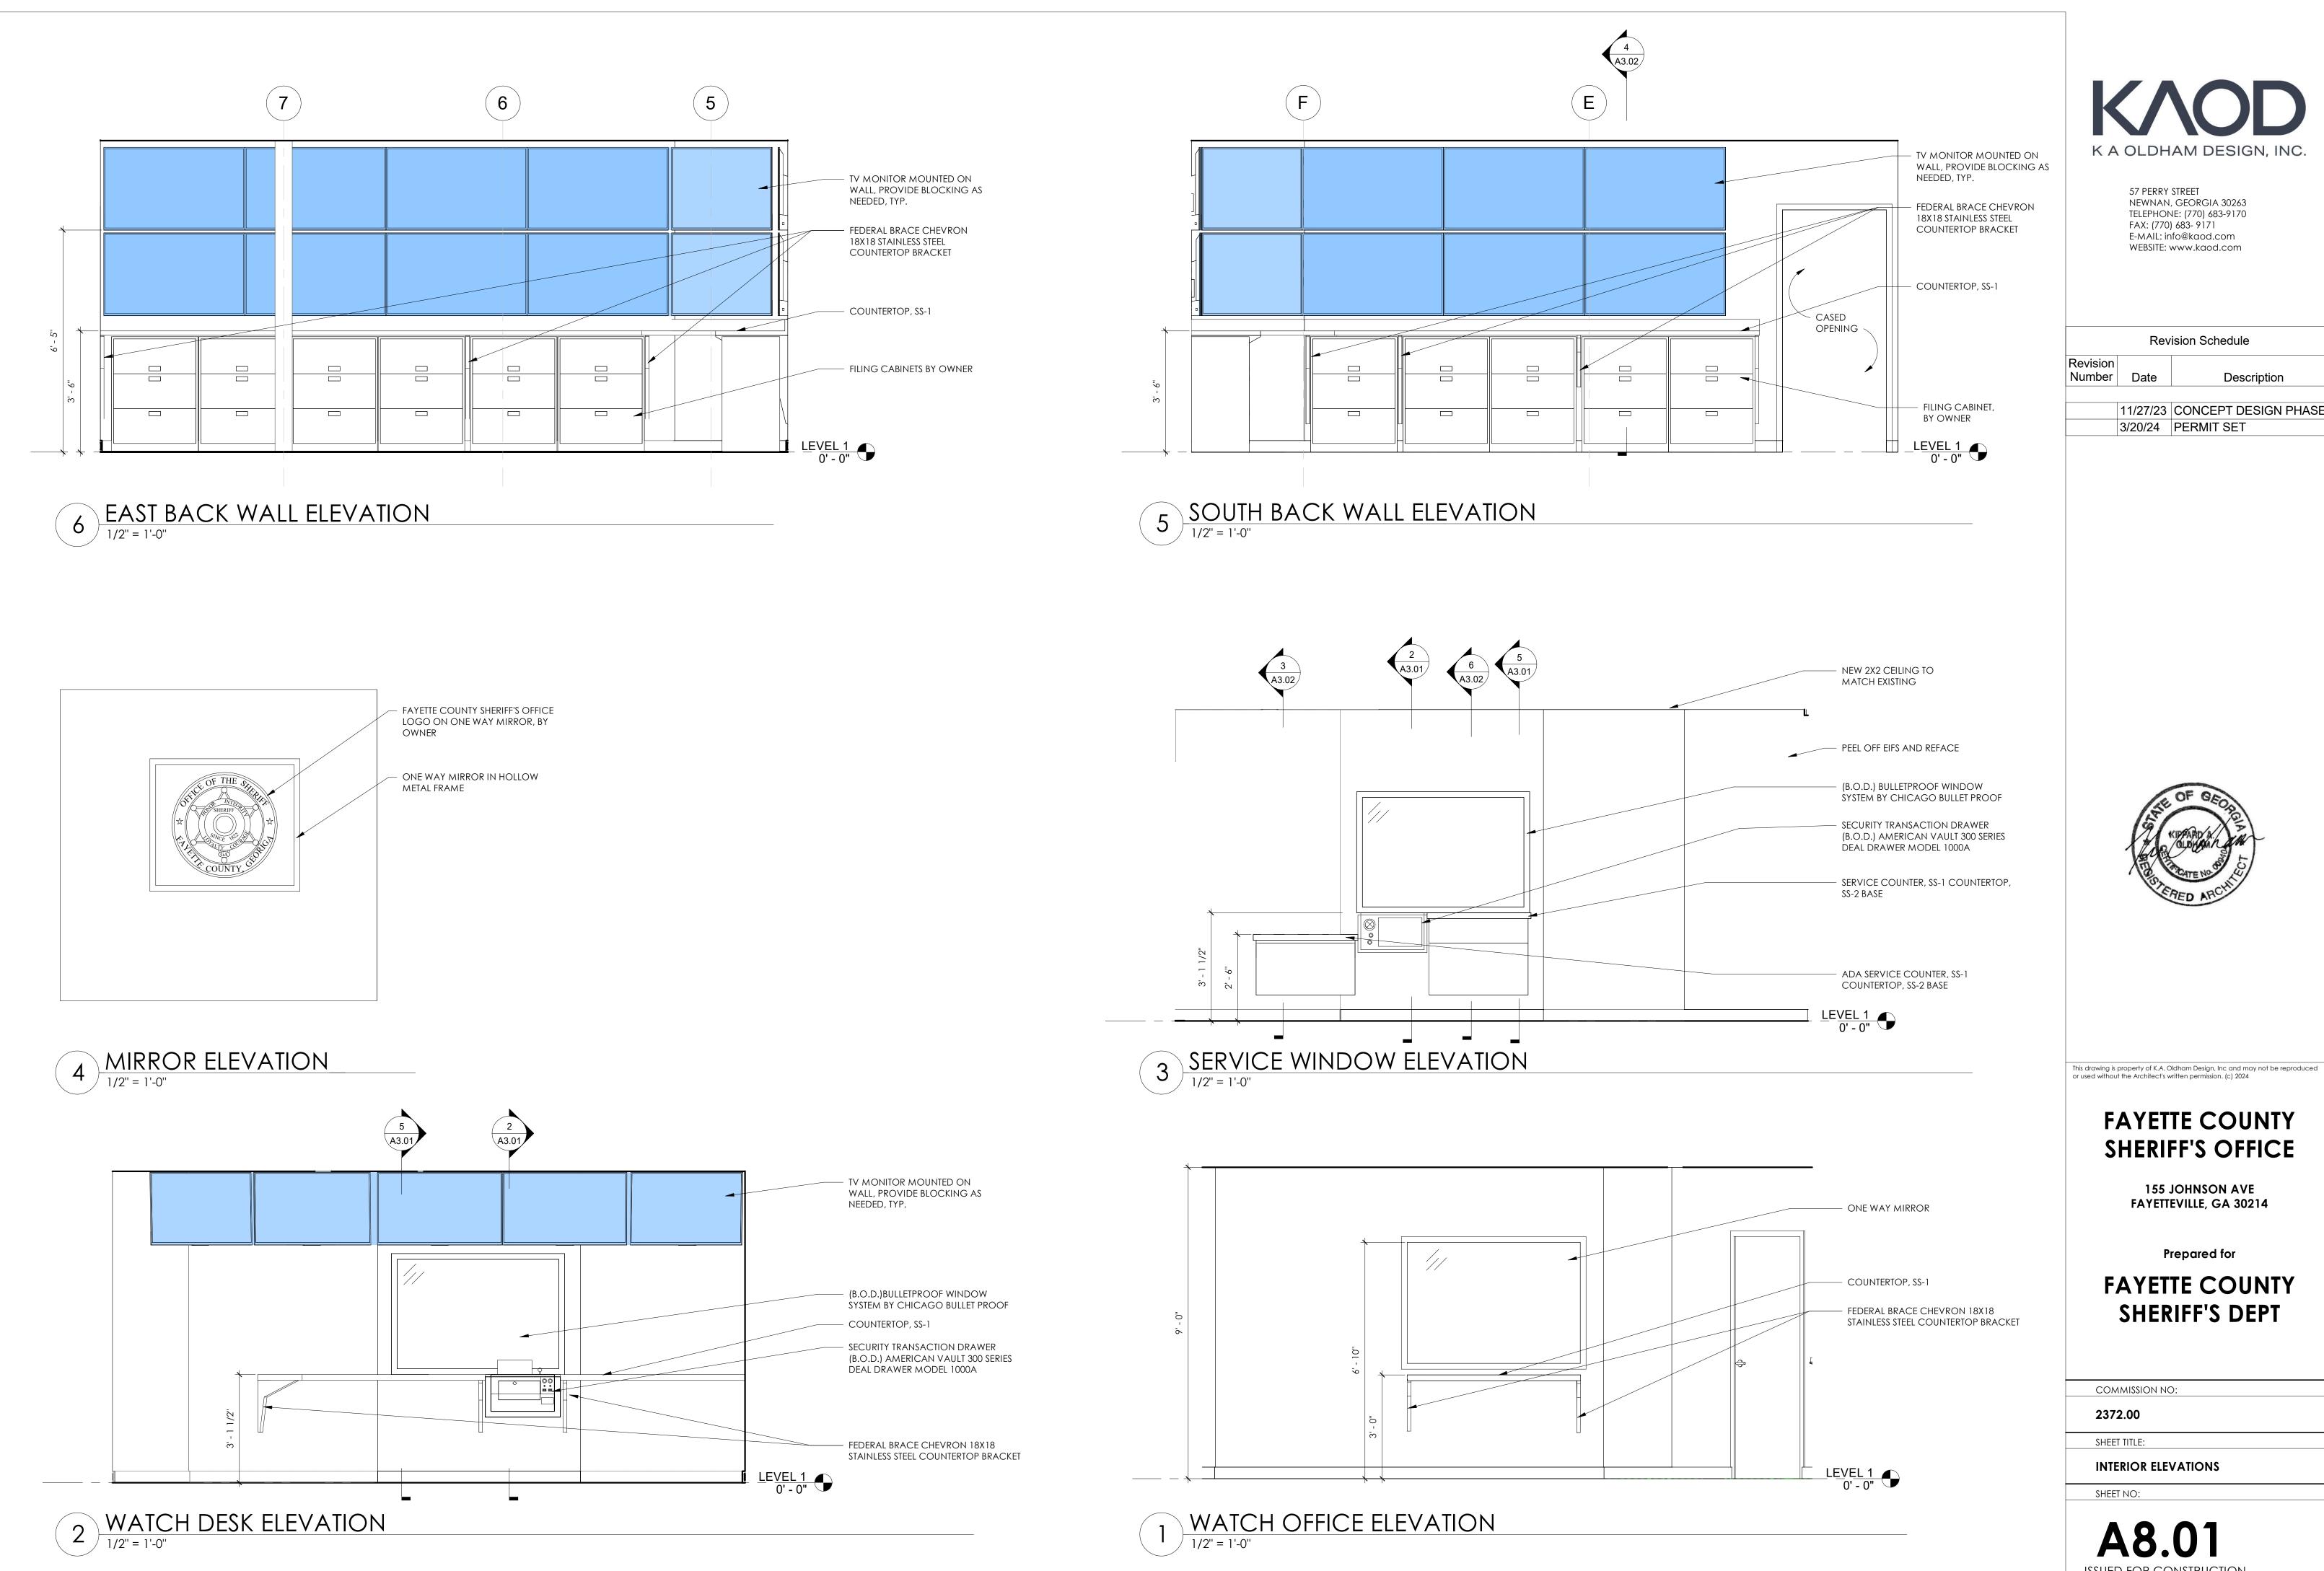


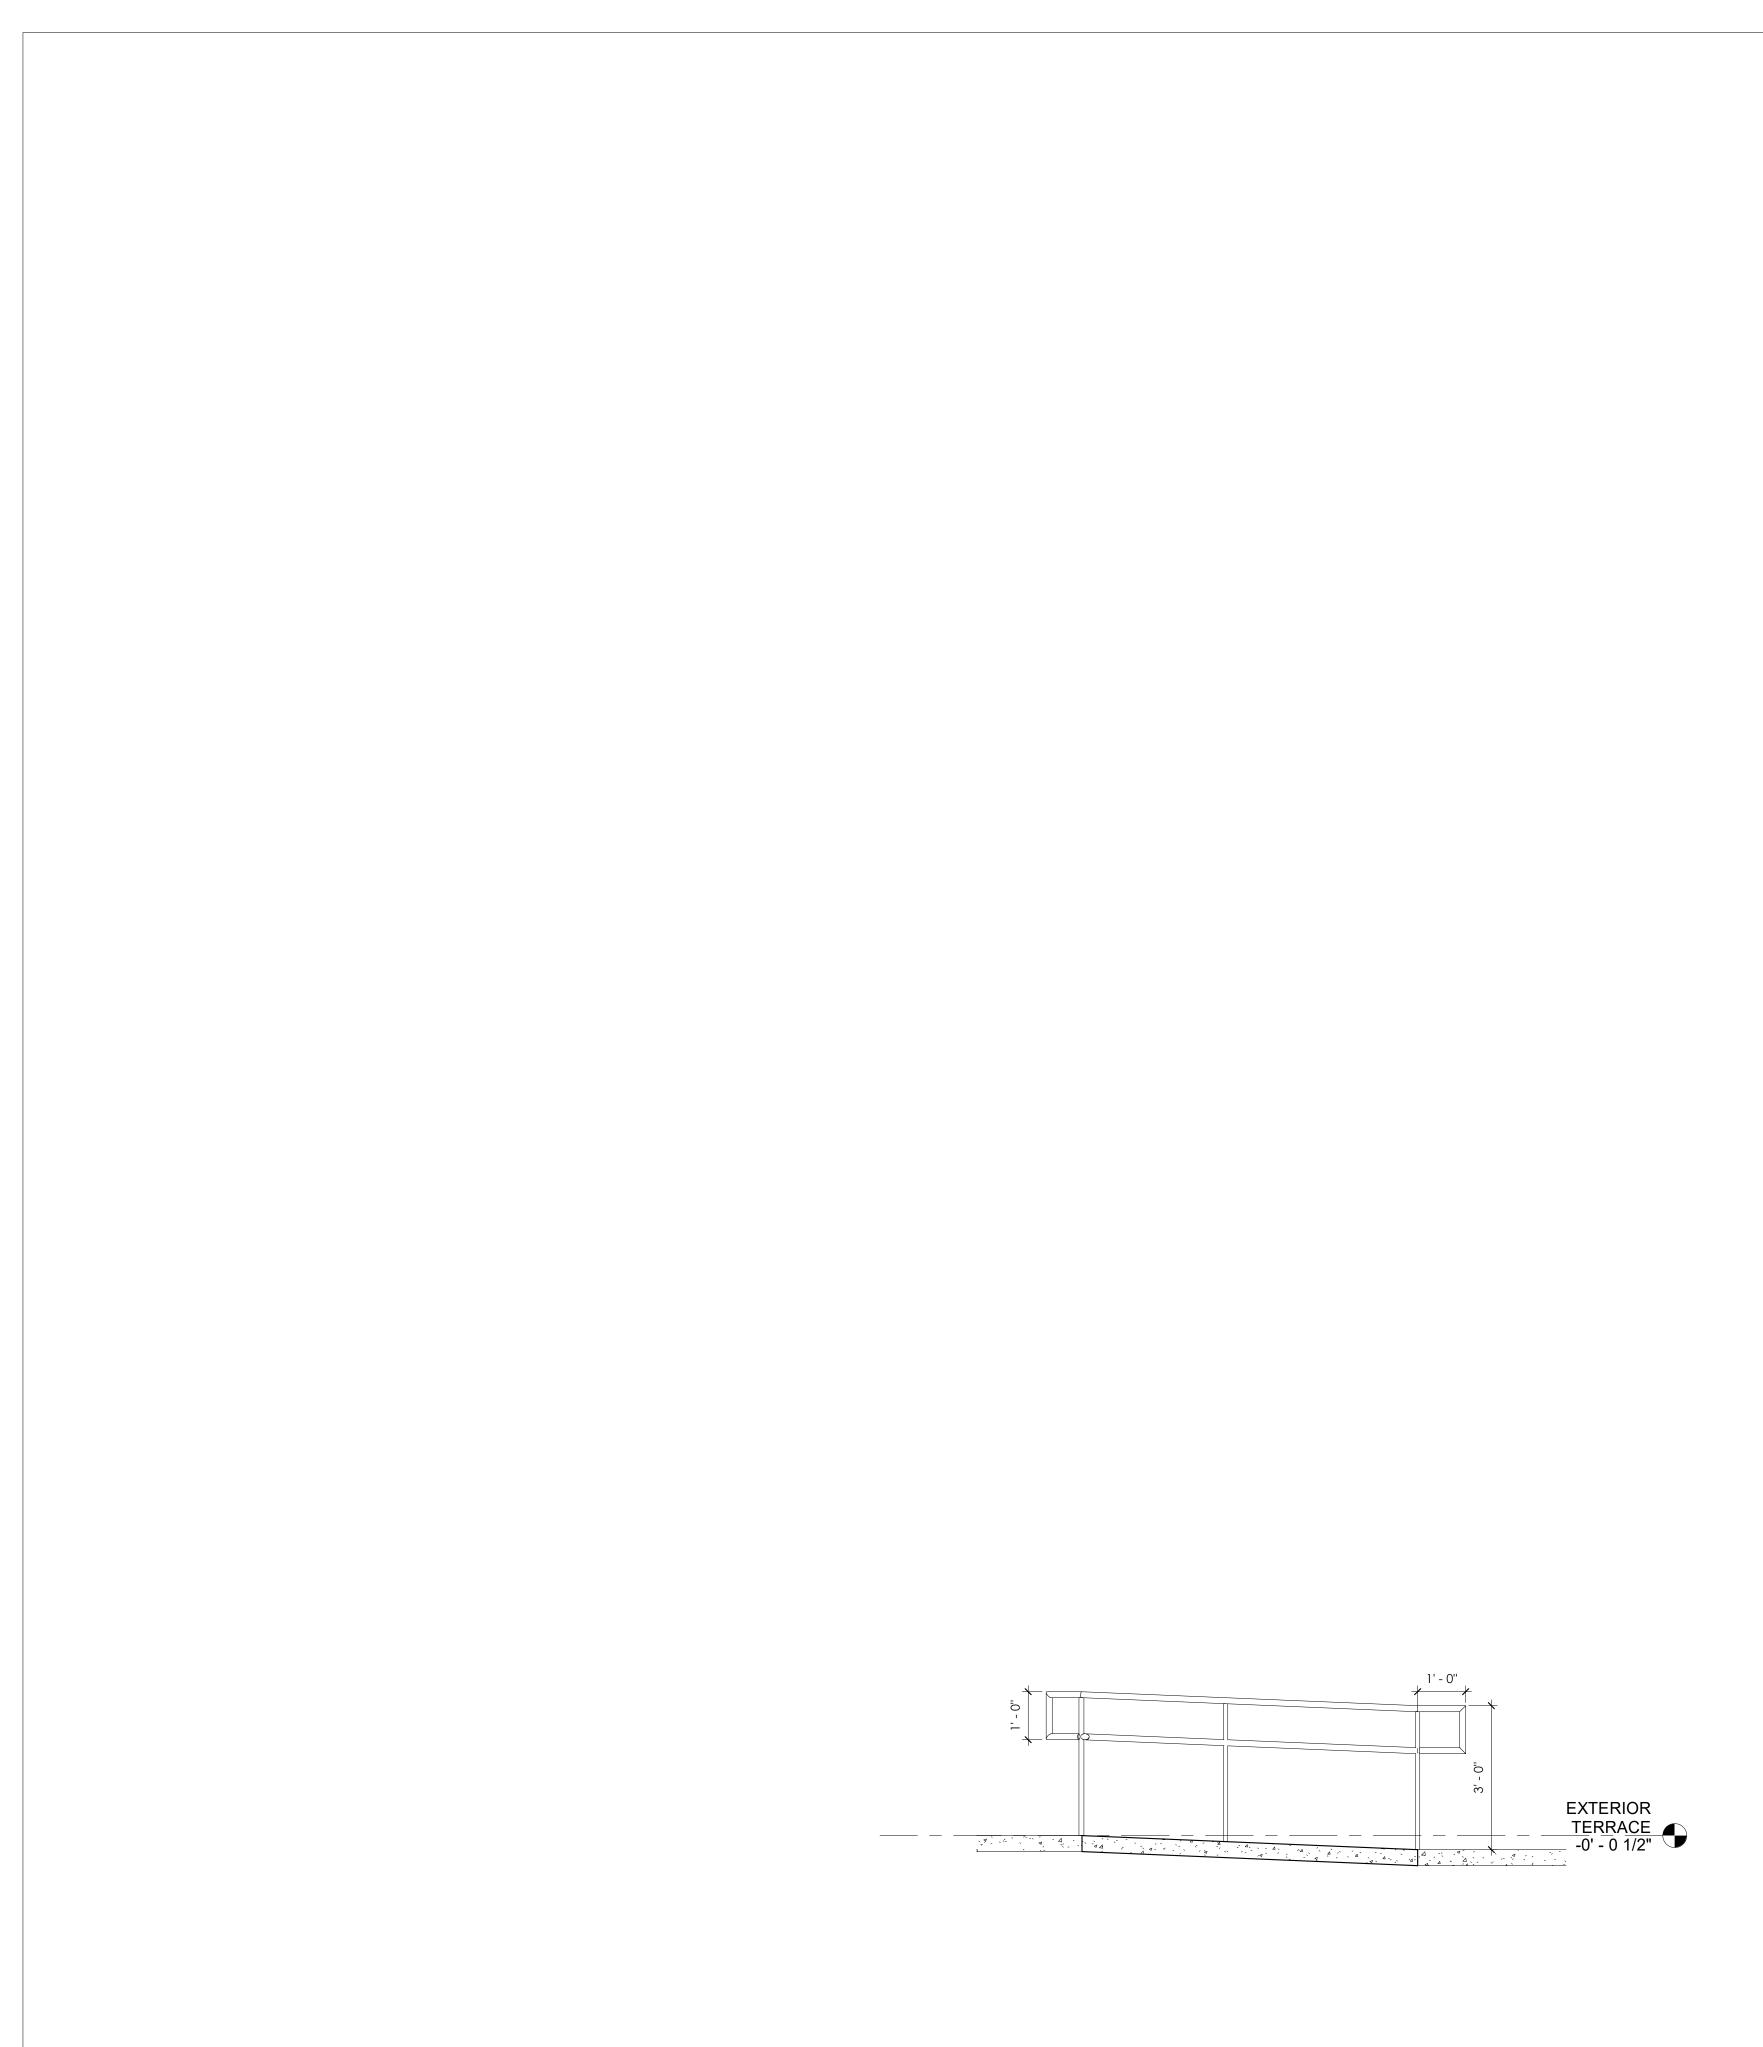



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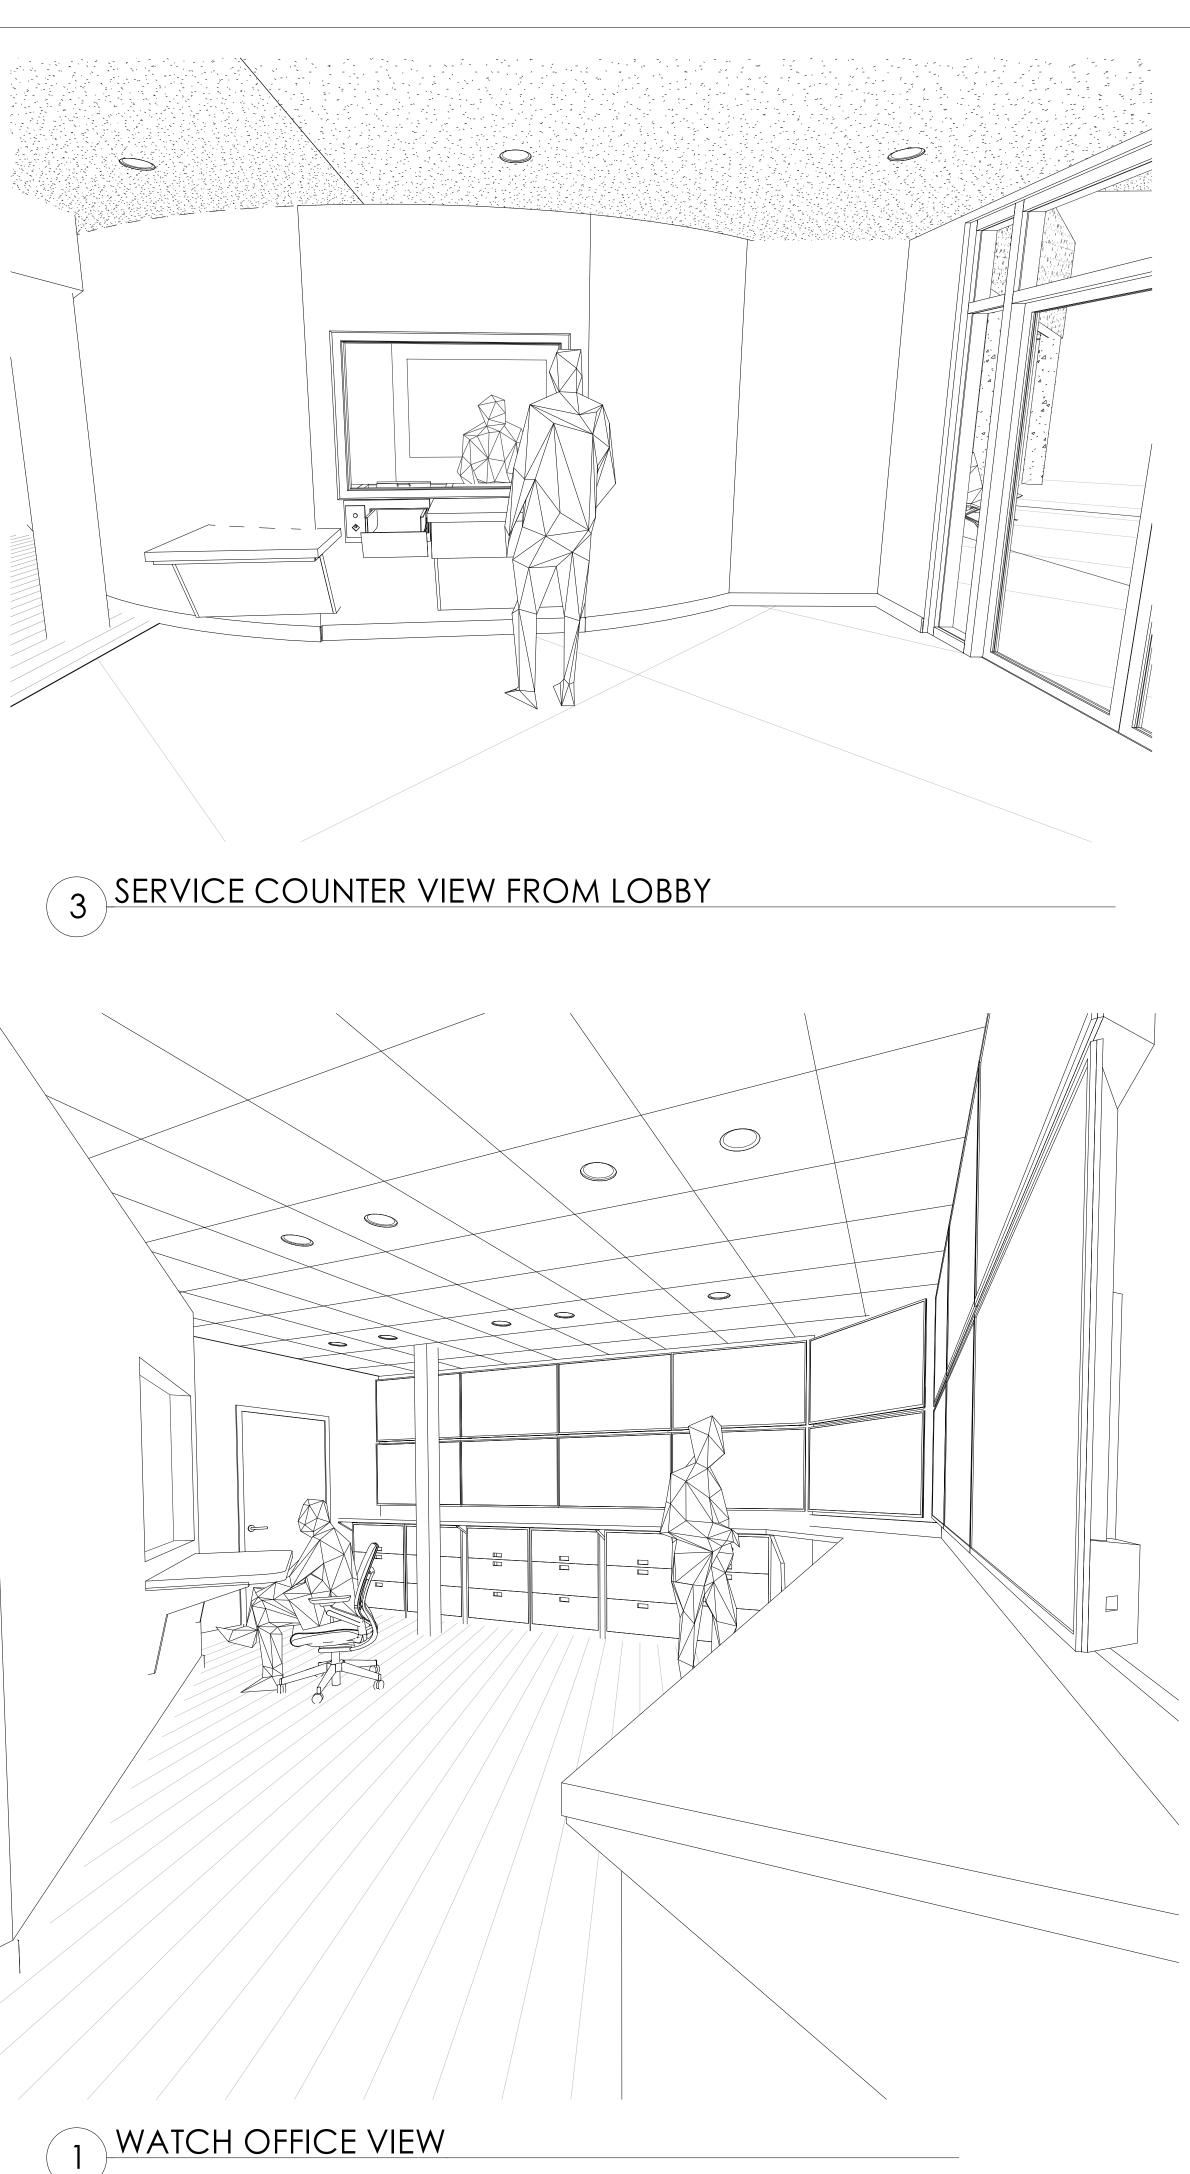
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FAX: (770) 683- 9171 E-MAIL: info@kaod.com WEBSITE: www.kaod.com Revision Schedule
Revision Number Date Description
11/27/23 CONCEPT DESIGN PHASE
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SHERIFF'S OFFICE
155 JOHNSON AVE FAYETTEVILLE, GA 30214
Prepared for FAYETTE COUNTY SHERIFF'S DEPT
COMMISSION NO:
2372.00
SHEET TITLE: RAMP PLANS AND SECTIONS
SHEET NO:
A7.01 ISSUED FOR CONSTRUCTION






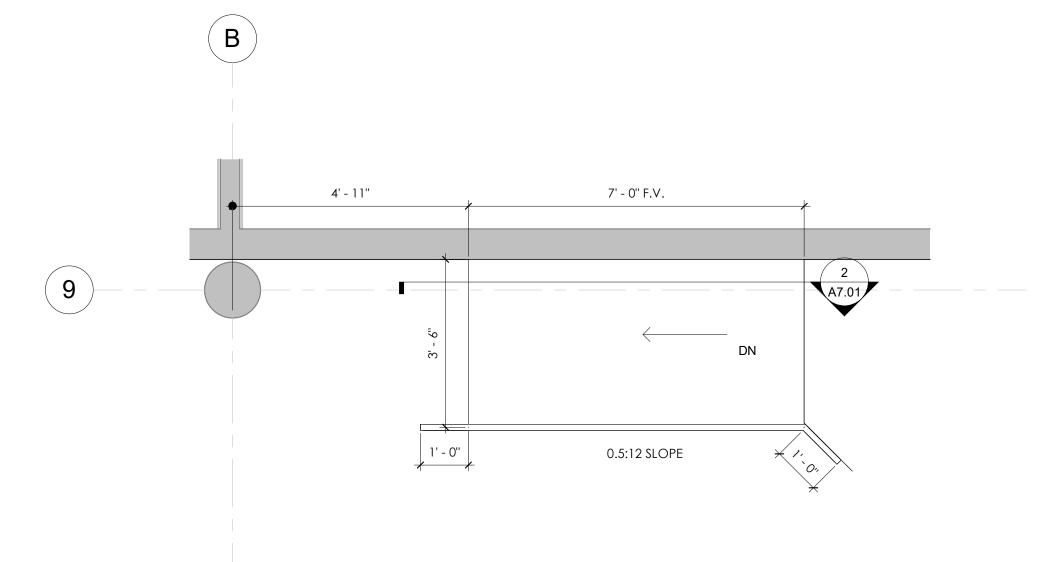

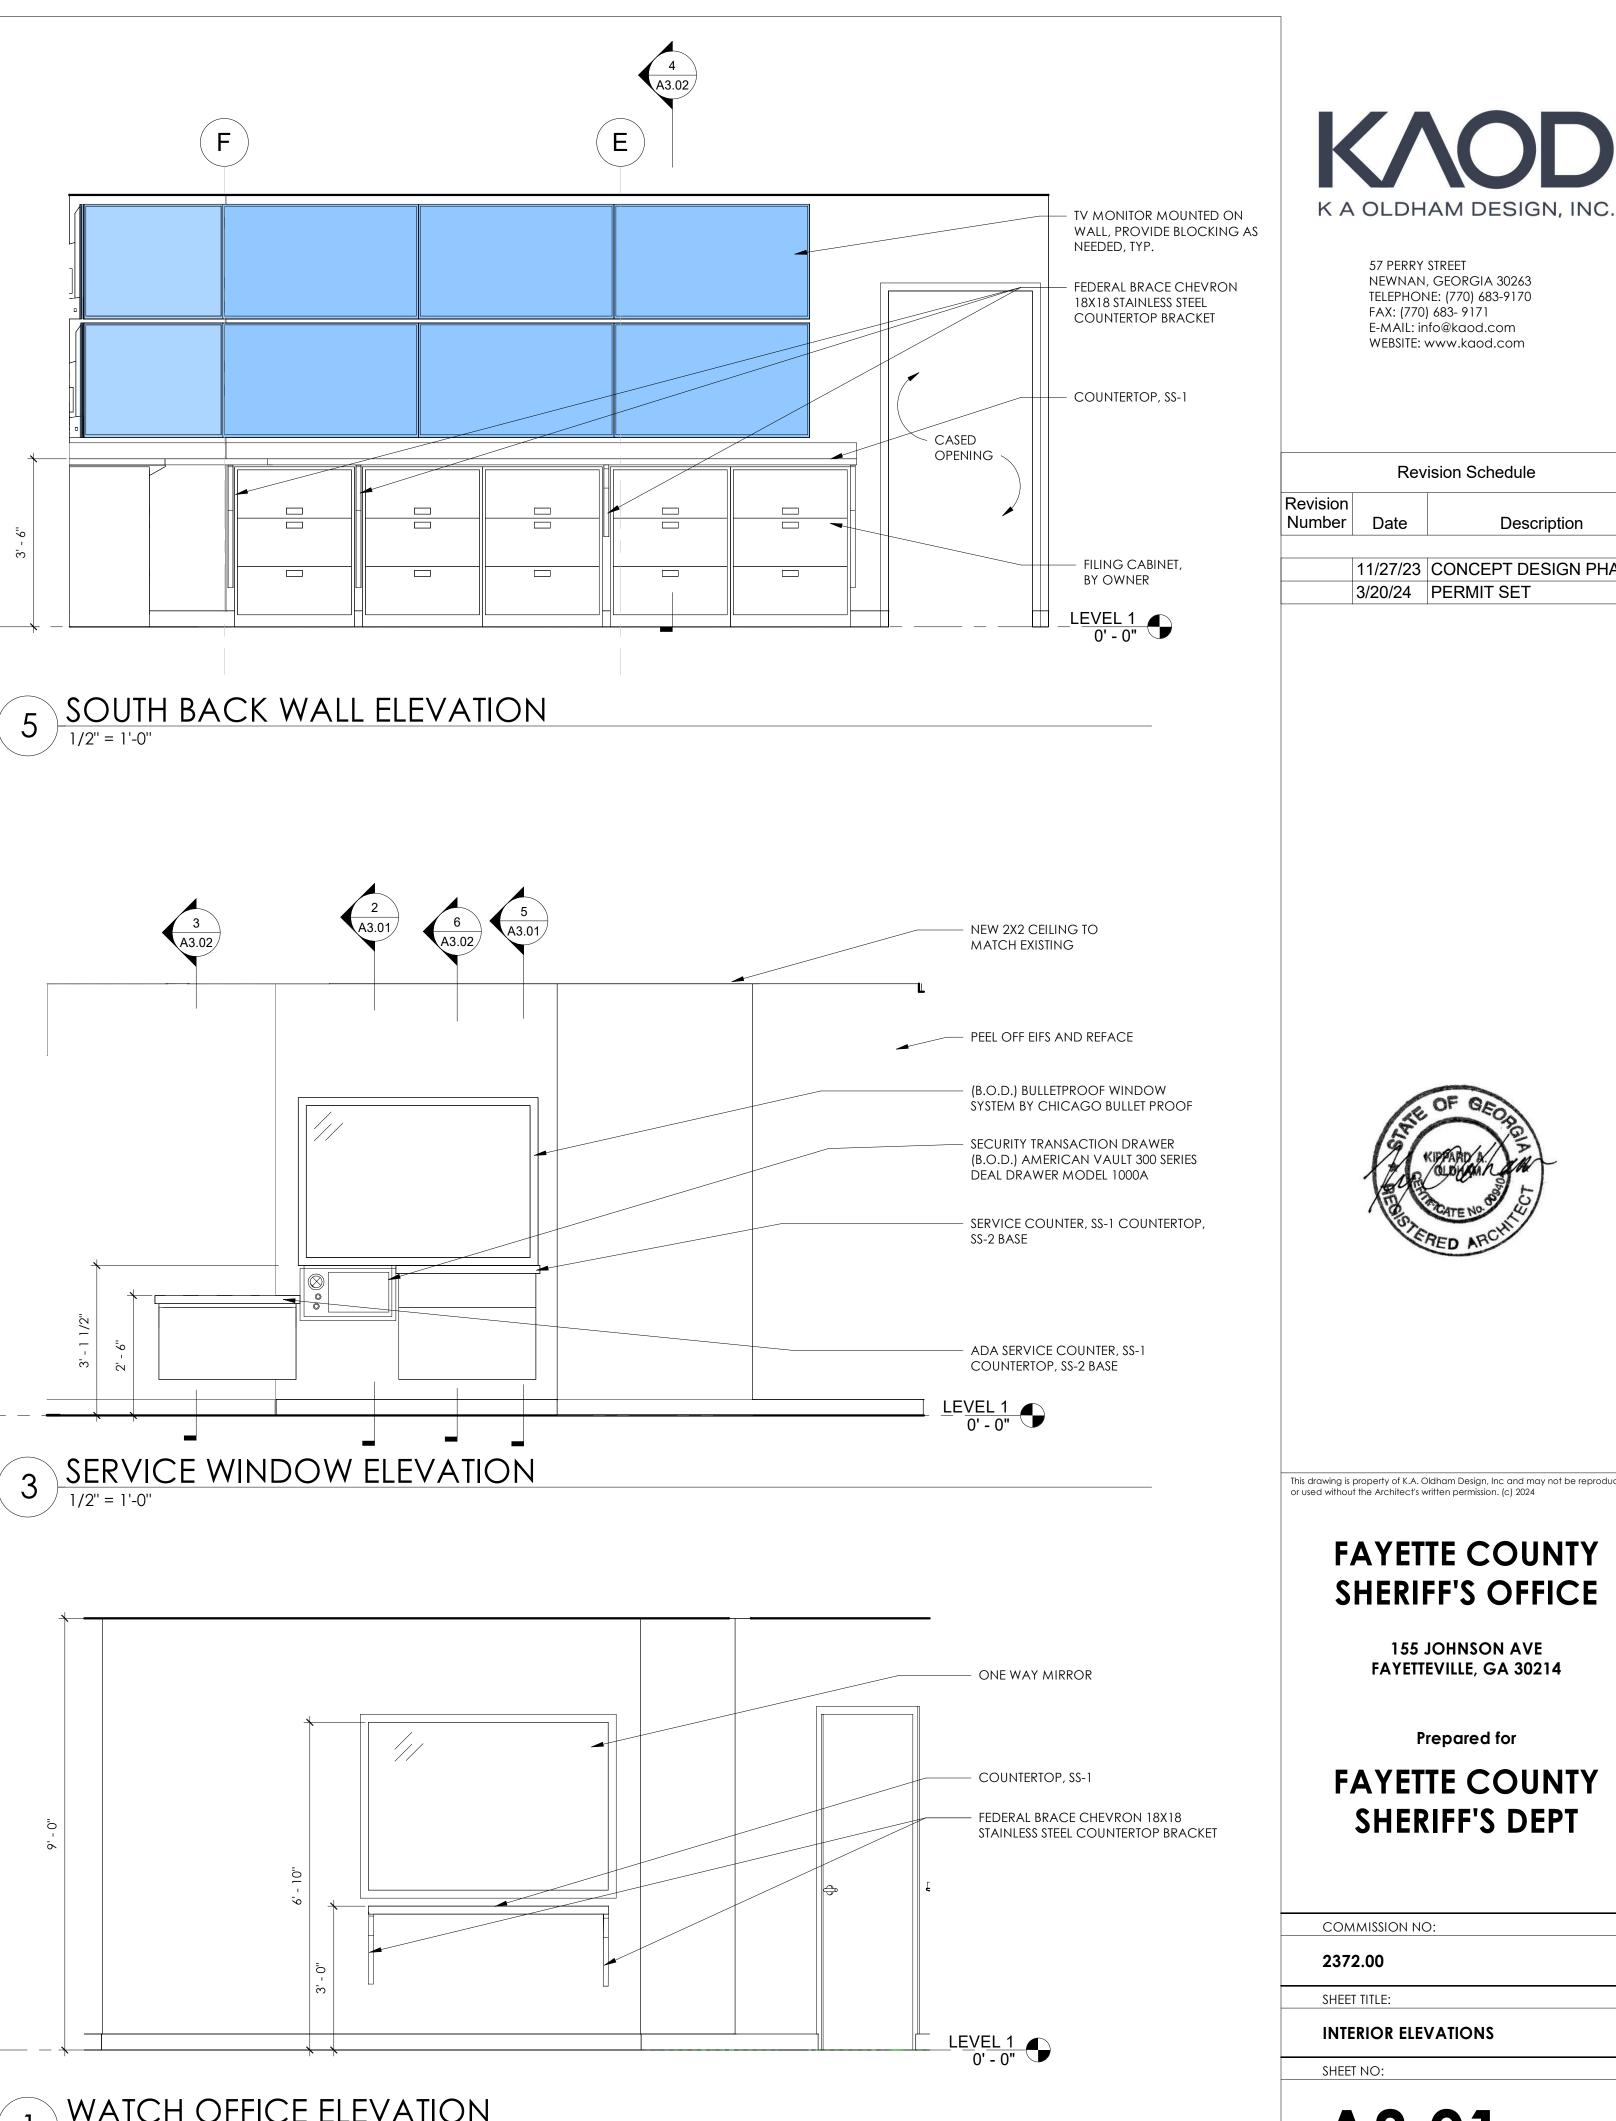

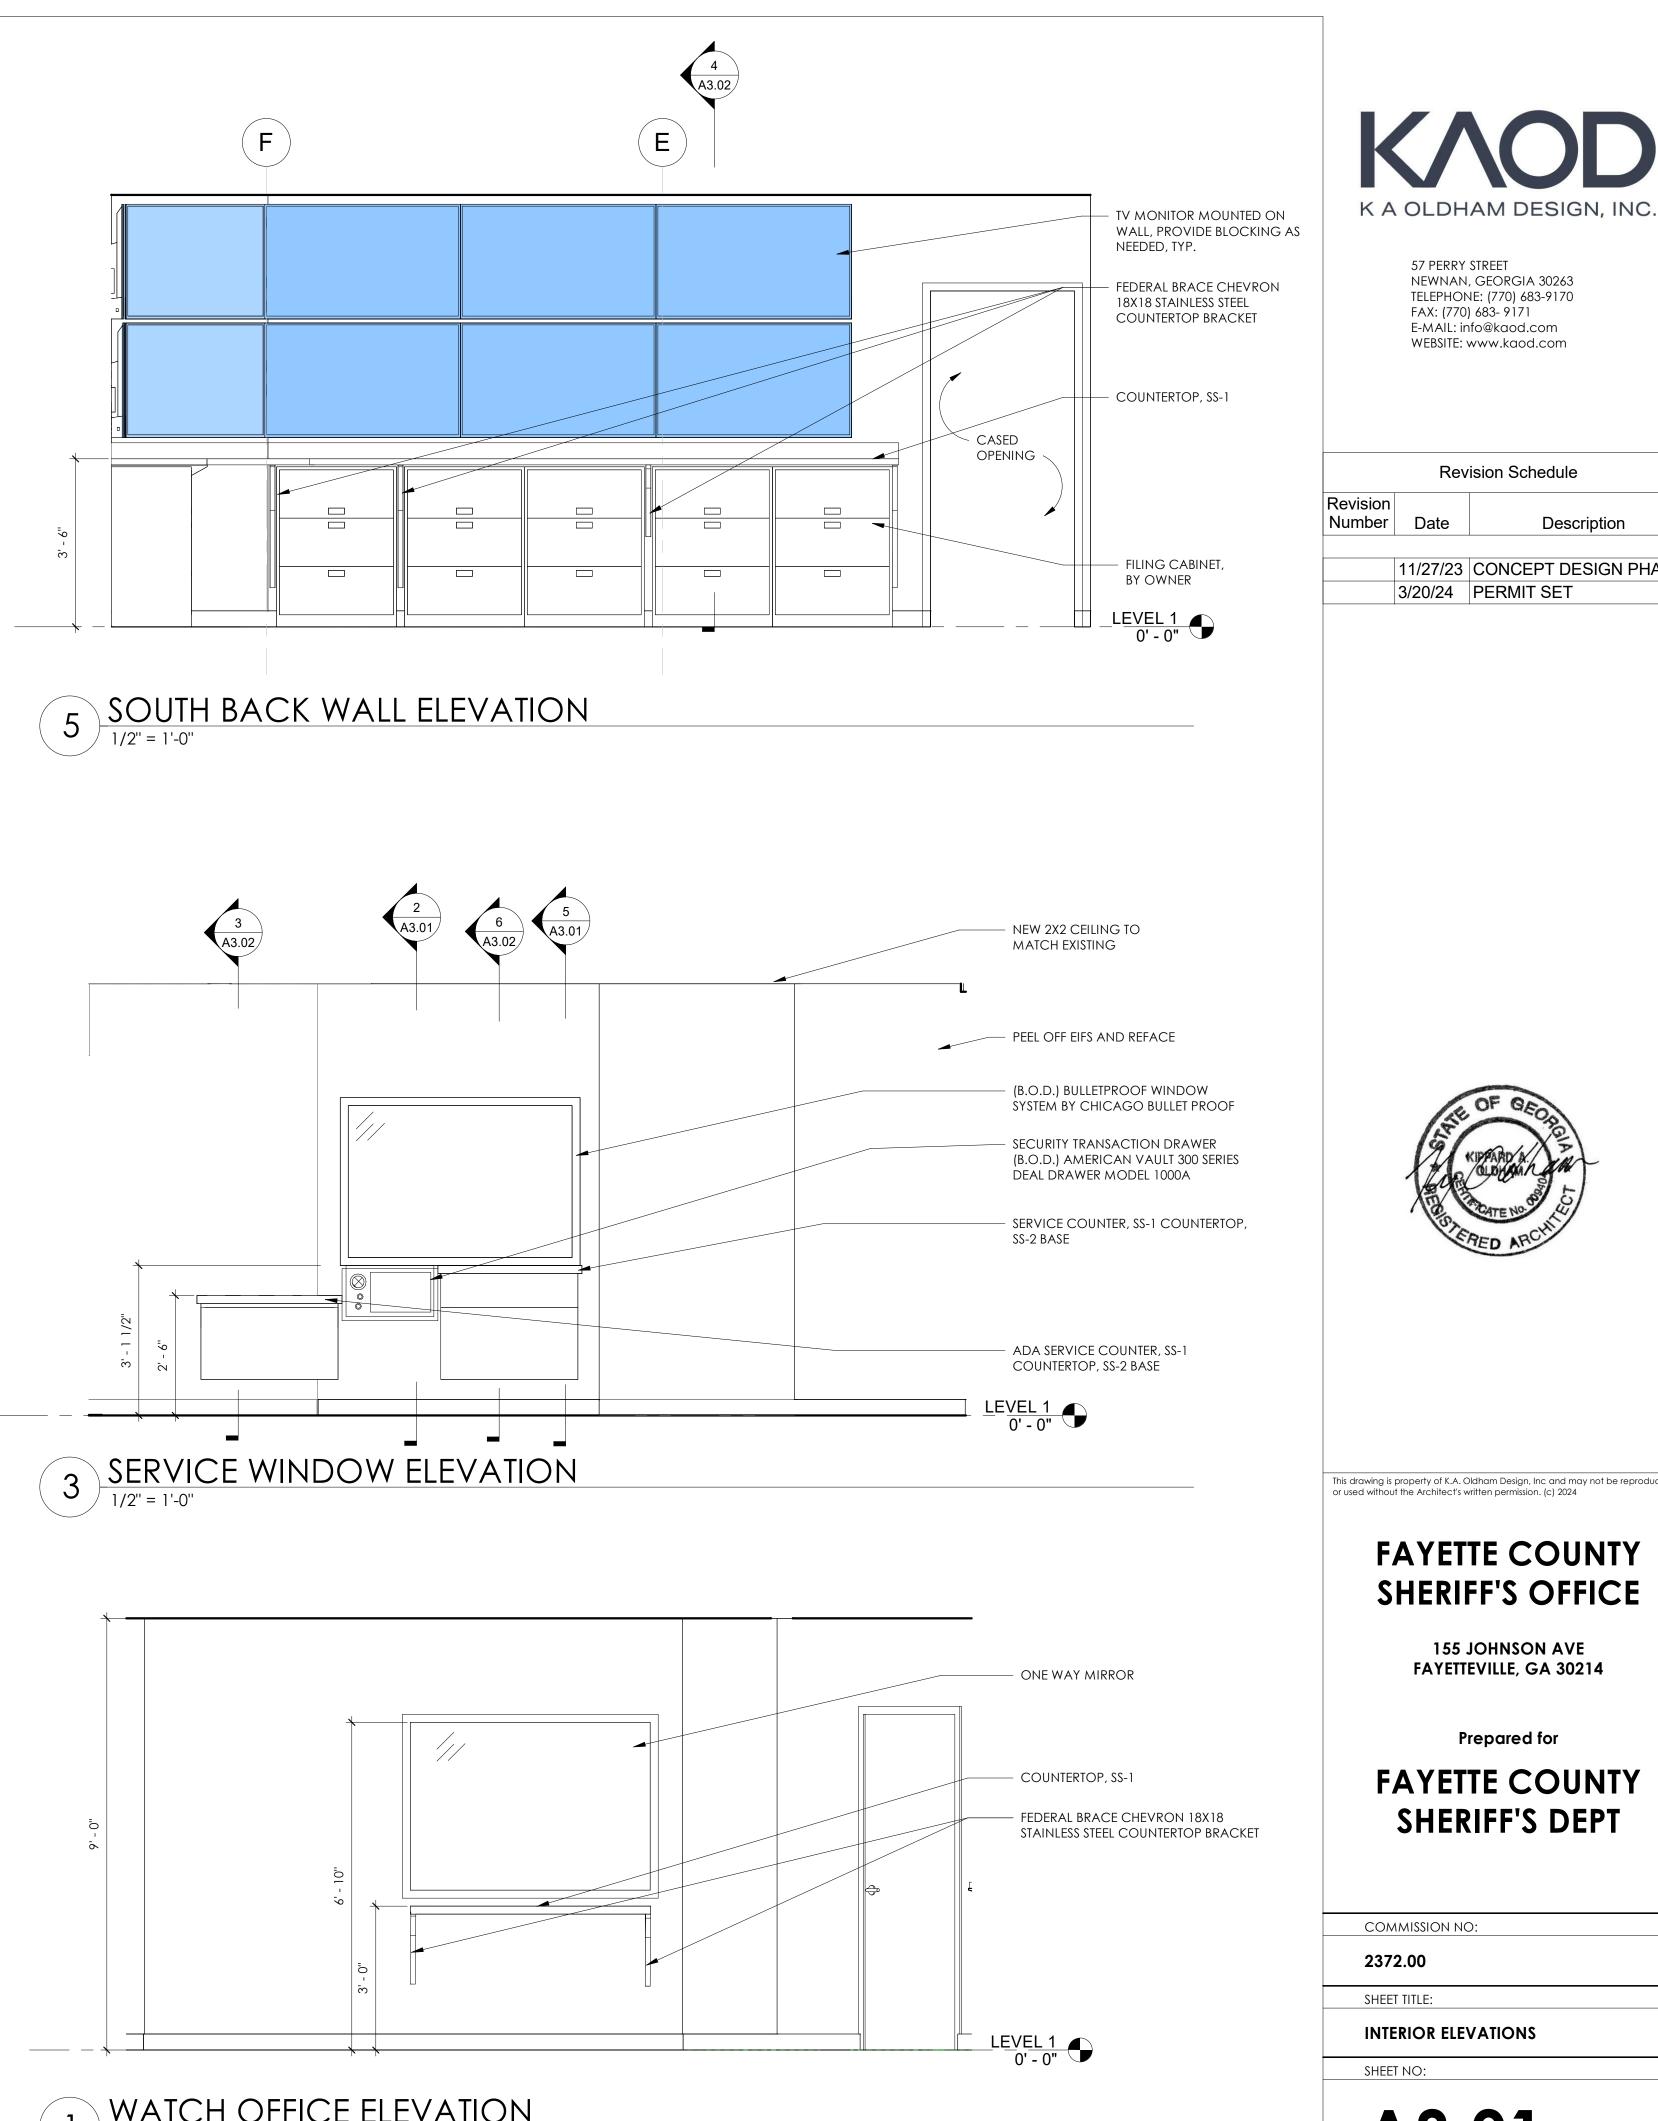





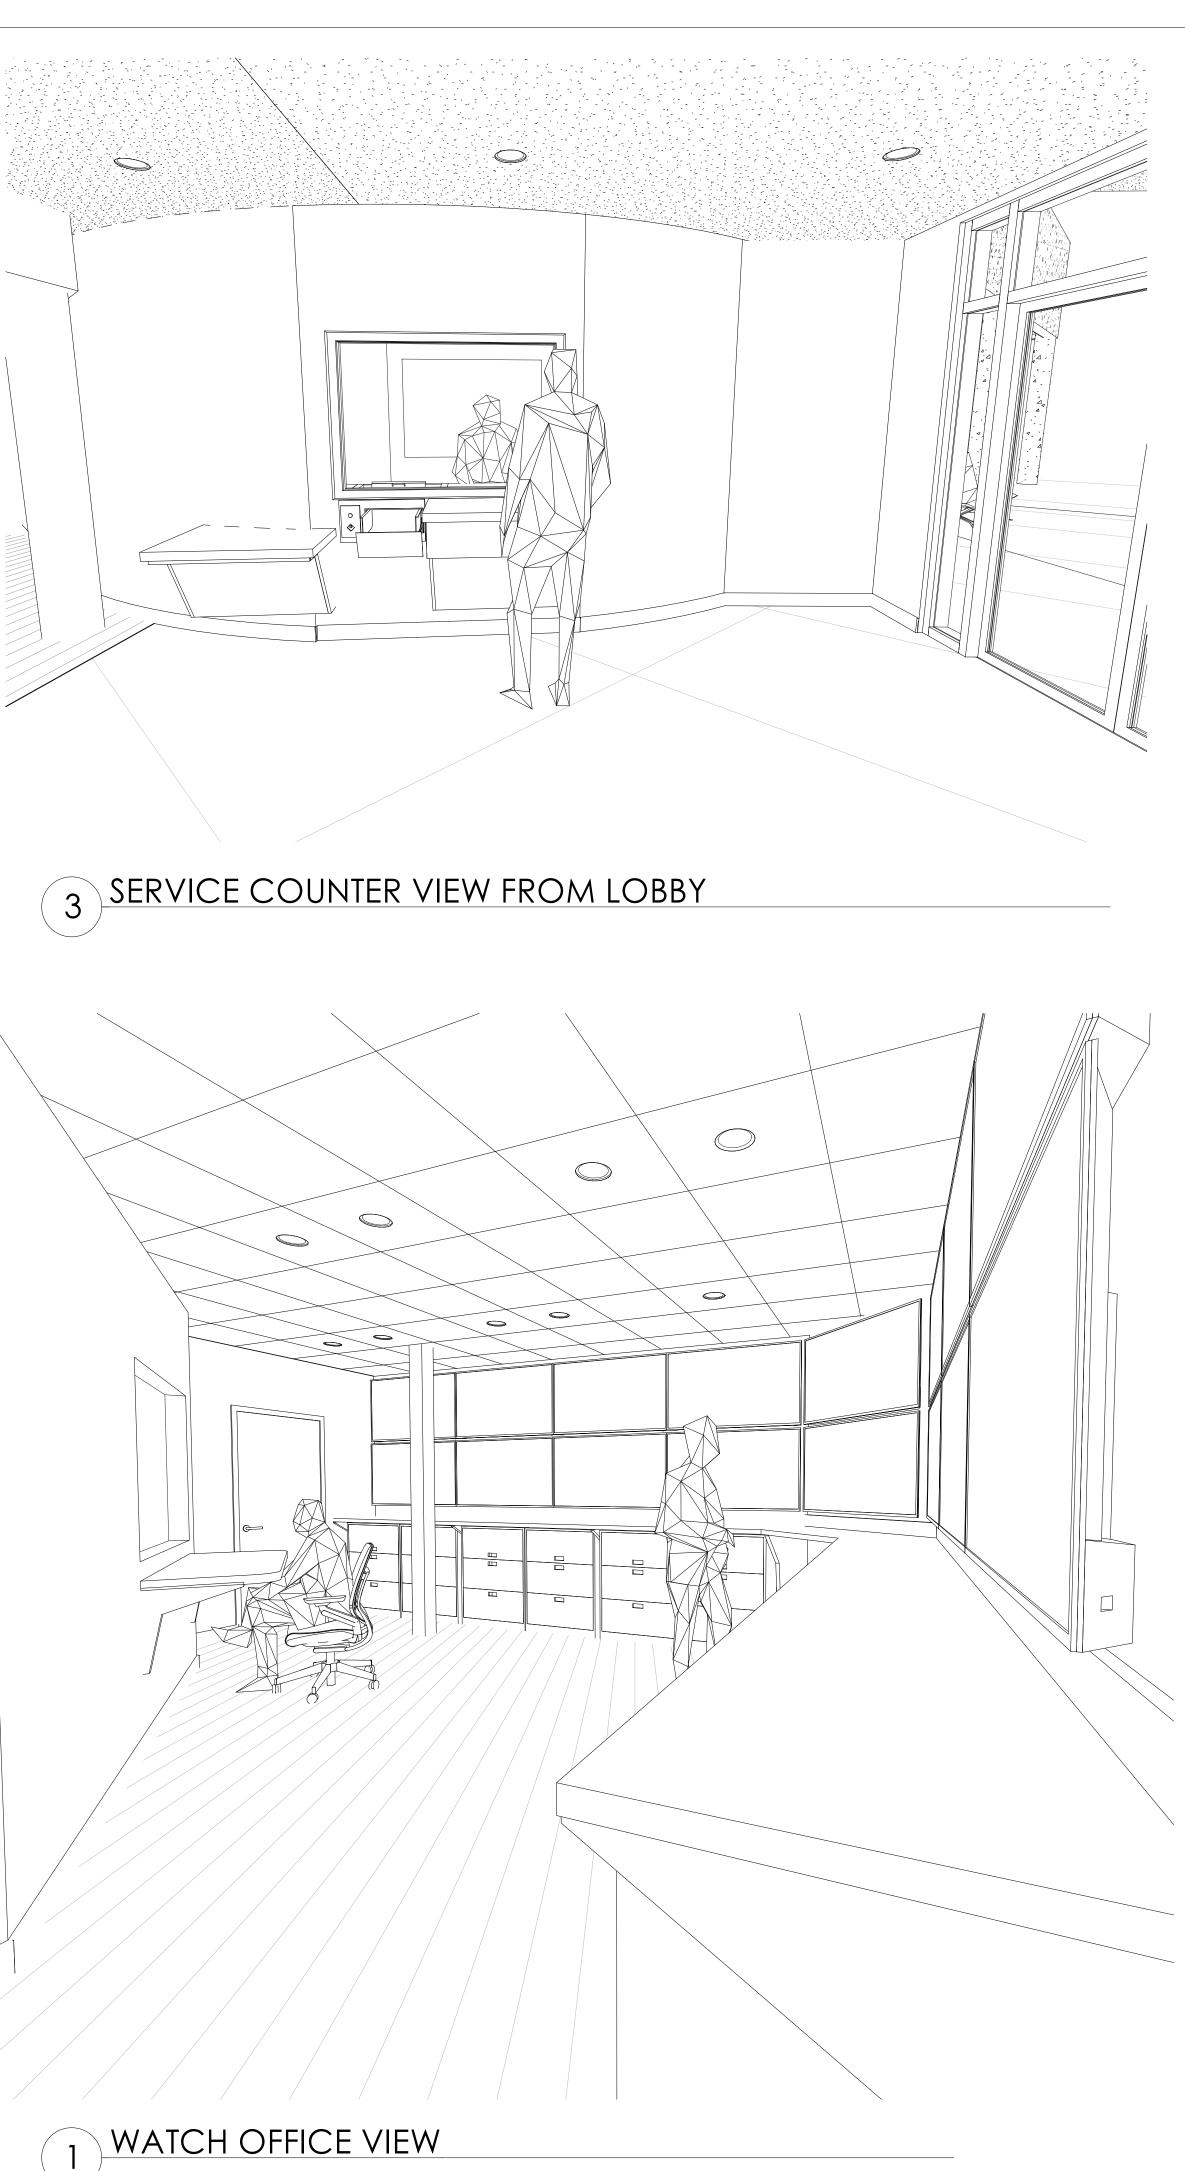

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		CONCEPT DESIGN PHASE			
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A8.03

ELECTRICAL SPECIFICATIONS

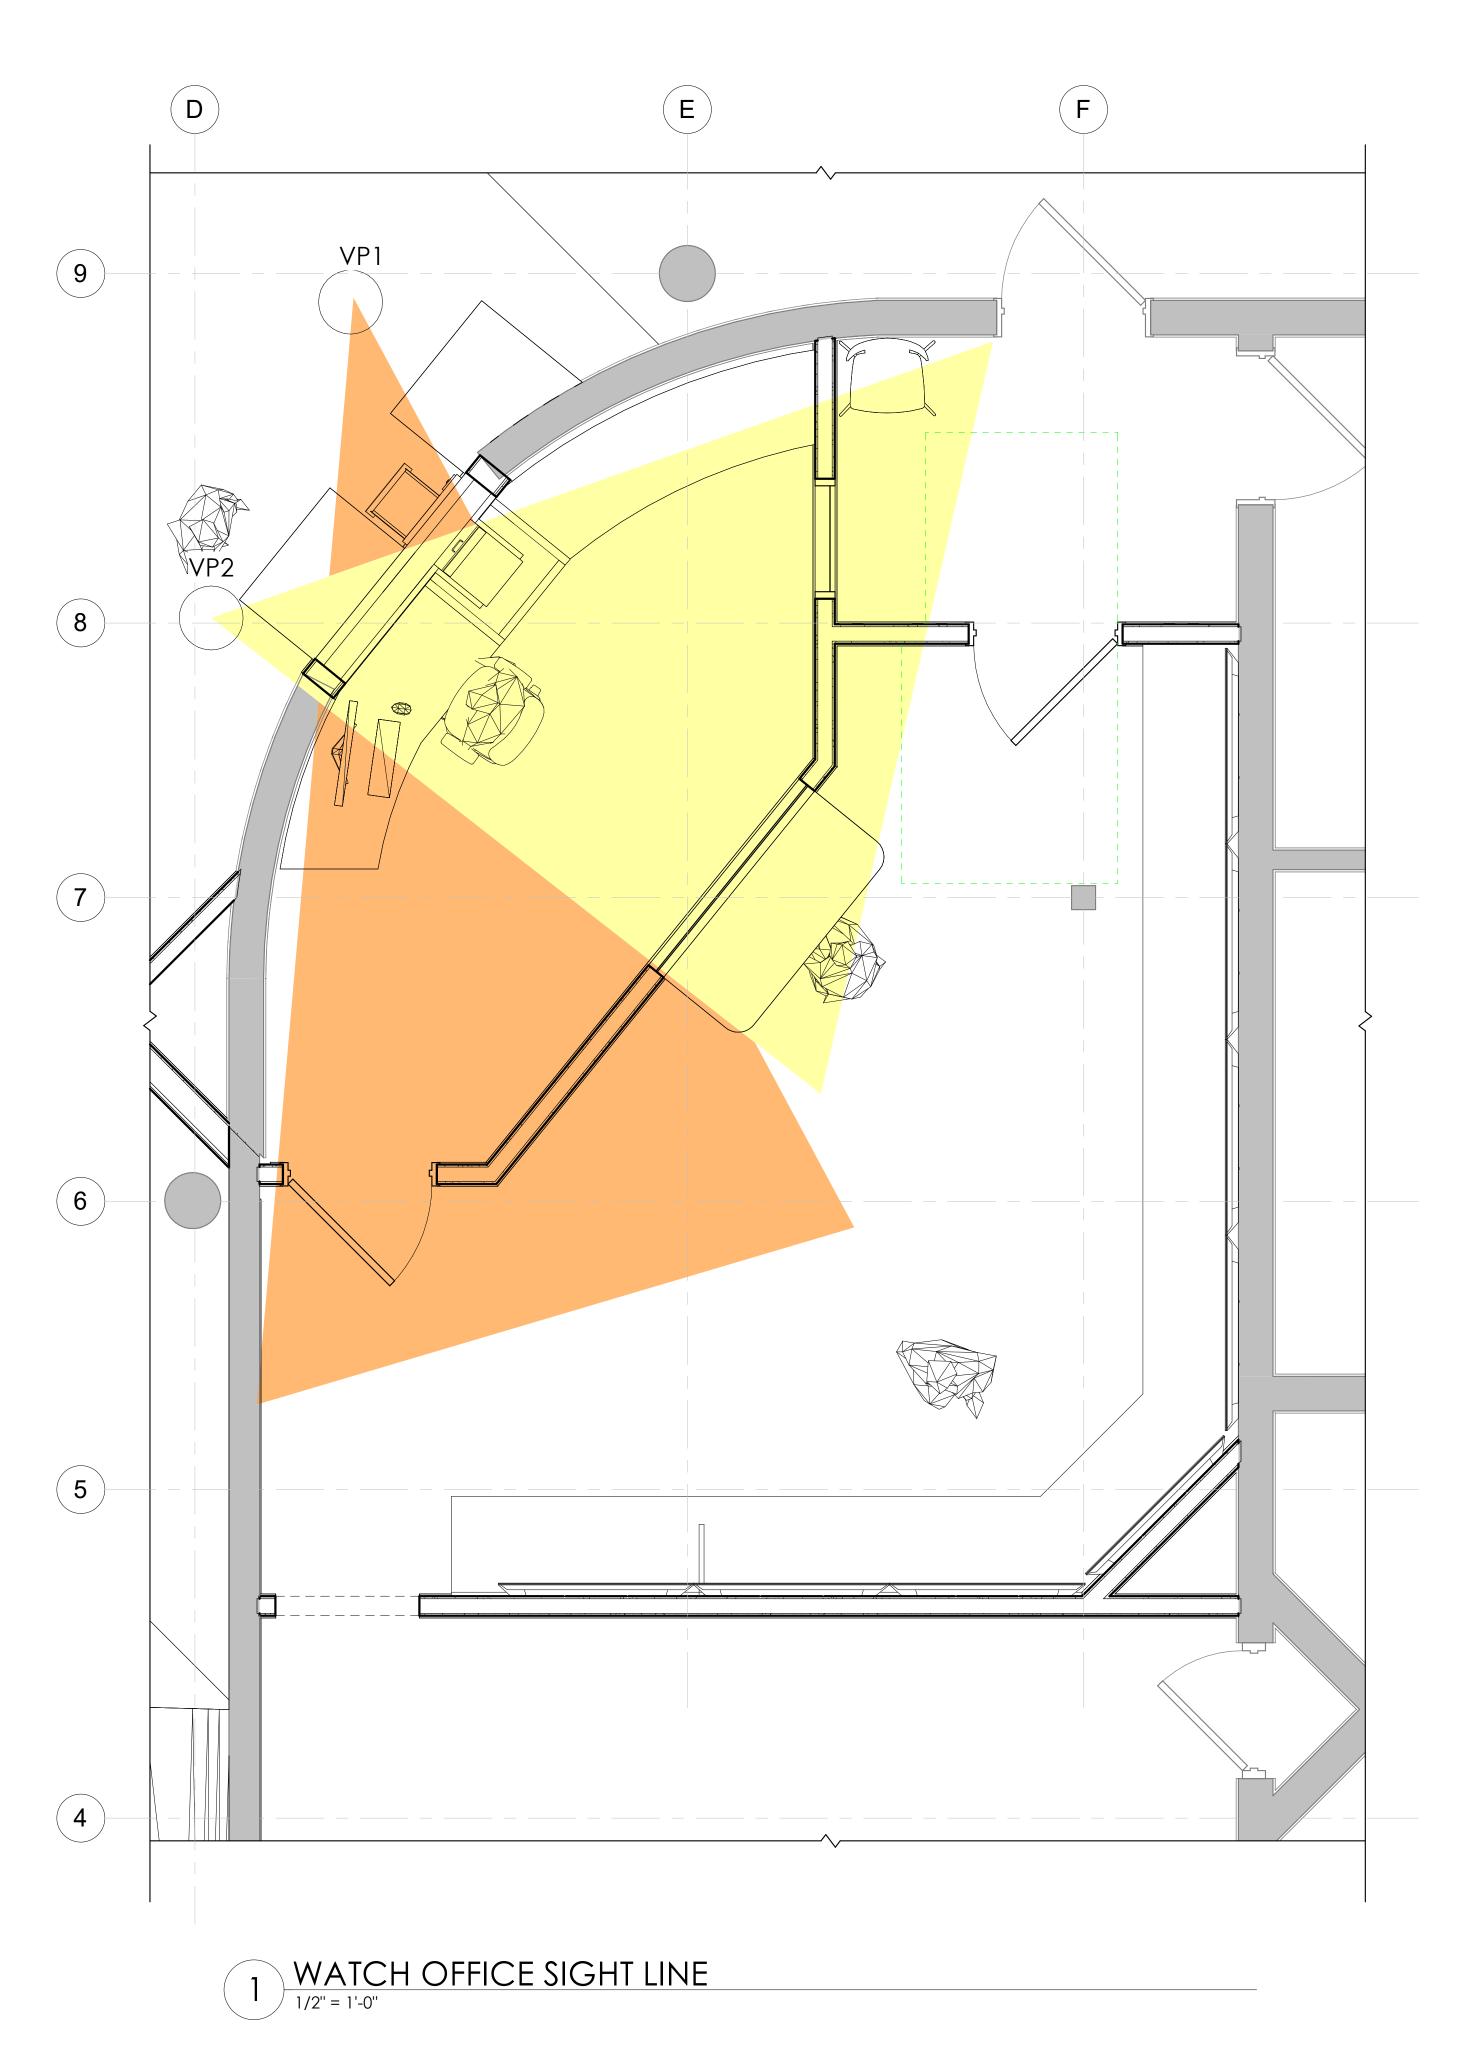- MATERIALS FURNISHED SHALL BE NEW. MATERIALS SHALL BE A MANUFACTURER'S STANDARD AND ESTABLISHED PRODUCT LINE, AND SHALL BE LISTED AND LABELED FOR THE APPLICATION BY UNDERWRITER'S LABORATORIES (U.L.), OR SHALL BE CERTIFIED BY OTHER APPROVED LABORATORY OR BY THE BUILDING GFICIAL HAVING JURSDICTION. IN COMJUNCTION WITH ARCHITECTURAL REQUIREMENTS, PROVIDE SUBMITTALS FOR THE FOLLOWING ELECTRICAL EQUIPMENT: ELECTRICAL PANELS, DISCOMECTS, WIRNG, RECEPTACLES, CONDUIT, LIGHTS, SWITCHES, MOTION SENSORS, TIMECLOCK, BOXES AND ANY OTHER SPECIALTY DEVICES AND EQUIPMENT AS SHOWN.
- 2. THE PLANS ACCOMPANYING THESE SPECIFICATIONS ARE GENERALLY DIAGRAMMATIC AND DO NOT SHOW ALL DETAILS REQUIRED FOR THE COMPLETE WORK, ESTABLISH DETAILS OF THE WORK AS NECESSARY TO PROVIDE FOR THE COMPLETE INSTALLATION OF SYSTEMS AND MATERIALS. ARRANGE THE WORK SO AS TO AVOID INTERFERENCE WITH OTHER BUILDING COMPONENTS OR SYSTEMS AS ACTUALLY INSTALLED.
- 3. COMPLY WITH APPLICABLE OR NECESSARY JOB SAFETY PROVISIONS.
- 4. PROVIDE FOR SYSTEM RACEWAYS, OUTLET BOXES, PULL "WRES" OR "CORDS", OUTLET BOX OPENINGS, BOX EXTENSIONS, DEDICATED RECEPTACLES, BACKBOARDS, ETC. AS SPECIFIED AND INDICATED. TELEPHONE CABLE SHALL BE FURNISHED AND INSTALLED BY OTHERS.
- 5. ELECTRICAL SYSTEMS, EQUIPMENT, AND SUPPORTING STRUCTURES SHALL BE COMPLETELY AND EFFECTIVELY GROUNDED. BONDING JUMPERS SHALL BE PROVIDED WHERE NECESSARY. METAL ELECTRICAL RACEWAYS AND FITTINGS, JOINTS AND CONNECTIONS AT EQUIPMENT SHALL BE MECHANICALLY AND ELECTRICALLY SECURED TO PROVIDE AN APPROVED EQUIPMENT OR ENCLOSURE GROUNDING MEANS, EVEN WHEN NO OTHER SEPARATE GROUNDING MEANS ARE ALSO PROVIDED EITHER INHERDILY OR BY BONDING.
- 6. WHERE GREEN GROUNDING CONDUCTORS ARE NOT INDICATED SPECIFICALLY FOR EACH BRANCH CIRCUIT BY THE DRAWINGS, PROVIDE FOR EACH RACEWAY A GREEN #12 GROUNDING CONDUCTOR IN ADDITION TO BRANCH CIRCUIT CONDUCTORS INDICATED.
- UNLESS OTHERWISE INDICATED OR DIRECTED BY THE ARCHITECT FOR SPECIAL APPLICATIONS, WIRING DEVICES SHALL BE INSTALLED WITH CONTER-OF-BOX MOUNTING HEIGHTS ABOVE FINISHED FLOORS BETWEEN 18-INCHES AND 44-INCHES, AS REQUIRED BY HANDICAPPED CODES. MOUNTING HEIGHTS FOR SPECIFIC DEVICES SHALL BE AS SCHEDULED BY THE FLANS.
- ELECTRICAL CONDUCTORS SHALL BE COLOR CODED AS FOLLOWS: EQUIPMENT GROUND: GREEN. PHASE CONDUCTORS: RED, BLUE, BLACK; NEUTRAL: WHTE:
- NOTIFY THE OWNER'S REPRESENTATIVE OF ANY NONFUNCTIONING MATERIAL OR POTENTIALLY UNSAFE CONDITION WITHIN THE PROJECT SYSTEMS THAT IS OBSERVED DURING THE CONDUCT OF THE WORK.
- 10. WORK SHALL BE FURNISHED AND INSTALLED AS A MINIMUM IN ACCORDANCE WITH THE APPLICABLE REQUIREMENTS AND RECOMMENDATIONS OF THE LATEST LOCALLY ADOPTED EDITION OF CODES AND STANDARDS OF THE FULLOWING:
- 1. NATIONAL ELECTRICAL CODE (NEC) NFPA 70, 2020 EDITION.
- 2. ENERGY CODE ASHRAE/IESNA 90.1.
- 3. LIFE SAFETY CODE NFPA 101.
- 4. OTHER NFPA STANDARDS: 90A AND 99
- 5. UL STANDARDS AND LISTING REQUIREMENTS AND NEMA STANDARDS. 6. FEDERAL, STATE, AND LOCAL LAWS, ORDINANCES, CODES, AND RULINGS OF
- FEDERAL, STATE, AND LOCAL LAWS, ORDINANCE BUILDING OFFICIALS HAVING JURISDICTION.
- 11. THE WORK COVERED BY THIS SPECIFICATION SHALL INCLIDE PROVIDING SUPERVISION, LABOR, SUPPLIES, MATERIALS (TO INCLIDE EQUIPMENT), TOOLS, SERVICES, DOCUMENTATION, TESTS & DEMONSTRATIONS, CERTIFICATES, AND DOLLAR COSTS REQUIRED TO CONSTRUCT THE COMPLETE SYSTEMS AS SPECIFIED HEREIN AND AS SHOWN BY THE PLANS AND OTHER RELEVANT DOCUMENTS.
- 12. UNLESS OTHERWISE SPECIFICALLY SHOWN OR NOTED BY ELECTRICAL PLANS, PLOT DUTY CONTROL SYSTEMS AND RELATED WIRING FOR MECHANICAL EQUIPMENT SHALL BE PROVIDED UNDER THE MECHANICAL SECTION OF THE SPECIFICATIONS.
- 13. SERVICE EQUIPMENT SHALL BE PROVIDED RATED FOR BUILDING LOADS, INCLUDING INTERRUPTING RATINGS. SERVICE EQUIPMENT SHALL BE SERVED USING THE TYPE SERVICE ENTRANCE EQUIPMENT AS INDICATED BY THE PLANS.
- 14. ALL RECEPTACLES SHALL BE 20A, 125V, SPECIFICATION GRADE, MOUNTED 18" AFF UNLESS NOTED OTHERWISE.

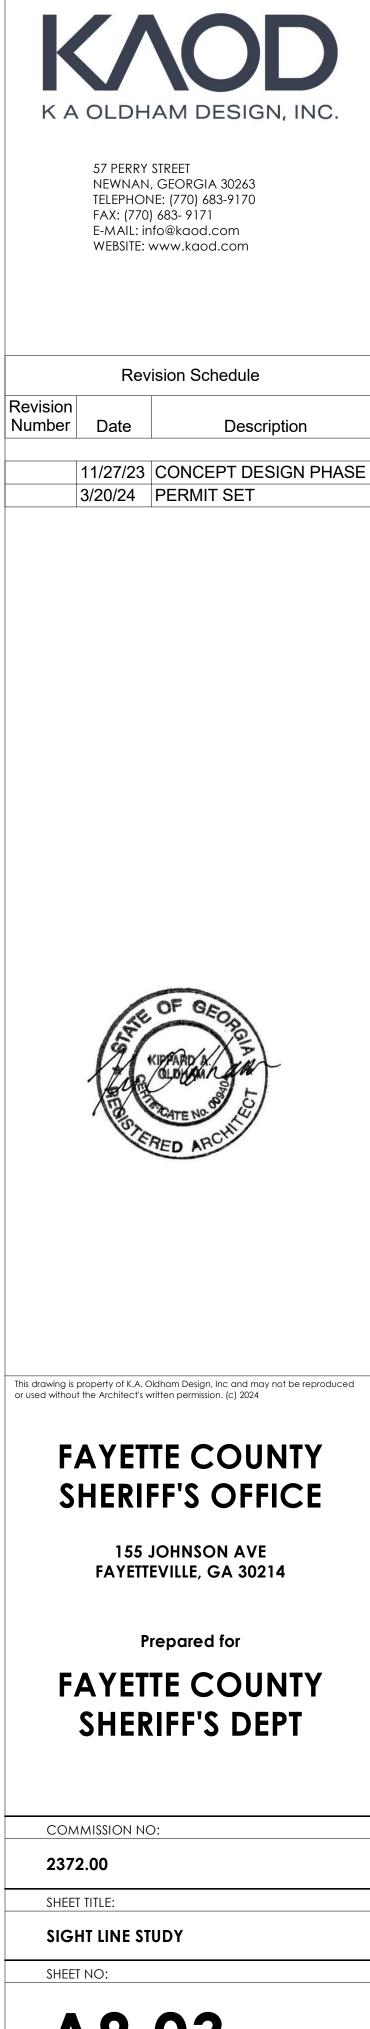- 15. SWITCHES SHALL AS A MINIMUM BE 'HEAVY-DUTY' RATED, QUICK MAKE AND BREAK, SPECIFICATION GRADE, SINGLE THROW DEVICES.
- 16. DISTRIBUTION EQUIPMENT USING CIRCUIT BREAKER TYPE PROTECTIVE DEVICES SHALL USE BOLTED-ON OR "SQUARE D" I-LINE DEVICES.
- 17. DISTRIBUTION EQUIPMENT SHALL BE AS INDICATED AND AS MANUFACTURED BY GENERAL Electric, Eaton/Cutler/Hammer, Schneder/Square-D or Siemens.
- 18. PANELBOARD MAINS SHALL BE COPPER OR ALUMINUM WITH BRANCH DEVICE CONNECTIONS ARRANGED IN A VERTICALLY DISTRIBUTED CONSECUTIVE PHASE SEQUENCE SUCH THAT ONE OR MULTIPLE POLE BREAKERS CAN BE MOUNTED IN ANY POSITION. A SOLD NEUTRAL BUS SHALL BE PROVIDED WITH A FEEDER LUG AND WITH A SEPARATE SET—SCREW TERMINAL FOR EACH BRANCH ORCUT POLE.
- 19. STARTERS AND DISCONNECT SWITCHES SHALL HAVE QUICK-MAKE AND QUICK-BREAK MECHANISMS, AND BE FULLY ENCLOSED.
- 20. FIXTURE SUPPORTS AND HAROWARE SHALL BE SUITABLE METAL UNLESS OTHERWISE INDICATED. SUPPORT STUDS USED FOR INDOOR FIXTURE OR COMPONENT SUPPORT SHALL BE GALVANIZED STEEL OR MALLEABLE IRON, DIECAST STUDS SHALL NOT BE USED. PROVIDE SEISMIC RESTRAINTS ON ALL FIXTURES PER LOCAL REQUIREMENTS.
- 21. CONDUCTORS SHALL BE OF SOFT DRAWN, ANNEALED COPPER HAVING A CONDUCTIVITY OF NOT LESS THAN 98 PERCENT BY 'ASTM' STANDARDS.
- 22. UNLESS OTHERWISE REQUIRED BY CODE OR INDICATED: A. CONDUCTORS NO. 12 AWG AND NO. 10 AWG SIZE SHALL BE SOLID. B. CONDUCTORS NO. 8 AWG SIZE AND LARGER SHALL BE STRANDED.
- 23. Rigid Steel and Inc Steel Conduit, when used, shall be hot DIP Galvanized. Steel Ent, when used, shall be hot DIP Galvanized Cutside, and Enamel OR Galvanized Finished Inside.
- 24. EMT COUPLINGS AND CONNECTORS SHALL BE METAL AND SET-SCREW TYPE.
- 25. UNLESS OTHERWISE INDICATED, WIRING DEVICES SHALL BE: A. SWITCHES: HUBBELL 1221 OR EQUAL B. RECEPTACLES: HUBBELL, PASS SEYNOUR OR LEVITON. C. COLOR AS SELECTED BY OWNER.
- 28. THE TELEPHONE AND SOUND SYSTEMS SHALL INCLUDE PAINTED BACKBOARDS, RACEWAYS, OUTLET ROVES, PULL CORDS IN EMPTY RACEWAYS, COVER PLATES, AND MISCELLANEOUS MATERIALS OR DEVICES FOR TELEPHONE OUTLETS, ETC. AS REQUIRED. PROVIDE CABLE WHERE NDICATED ON THE DRAWINGS.
- 27. FIXTURES SHALL BE INSTALLED IN ACCORDANCE WITH UL LISTING RESTRICTIONS AND LOCAL CODES AND ORDINANCES.
- FIXTURES SHALL BE LOCATED IN A MANNER COORDINATED WITH ANY SUSPENDED ACOUSTIC CELINIC PATTERN, AND IN ACCORDANCE WITH PATTERNS AS SHOWN ON THE ARCHTECTURAL DRAWINGS.
- 29. UNLESS OTHERWISE REQUIRED BY CODE OR FUNCTION OR INDICATED BY THE PLANS, CONDUCTORS FOR POWER AND LIGHTING BRANCH CIRCUITS SHALL BE #12 AWG MINIMUM.
- 30. CONDUCTORS SHALL BE CONNECTED BY U.L. APPROVED CONNECTORS. BRANCH CIRCUIT WIRING TO SIZE 48 SHALL BE CONNECTED BY CONNECTORS WITH LIVE SPRING TENSION

- 31. WRING SHALL BE INSTALLED IN METALLIC RACEWAYS AS ALLOWED AND SIZED PER NEC.
- 32. RACEWAYS AND CABLE SHALL BE RUN CONCEALED, EXCEPT THAT RACEWAYS DESIGNED ONLY FOR SURFACE MOUNTING AND RACEWAYS AND CABLE IN EQUIPMENT ROOMS SHALL BE RUN EXPOSED, UNLESS OTHERINSE NIORCHED, CONCALE MLD CONDUT RUN ABOVE THE CELLING UNE SHALL BE SUPPORTED INDEPENDENTLY OF CELLING CONSTRUCTION. WHERE CELLINGS OF THE LAY-IN TYPE MAY BE USED, CONDUITS MUST BE INSTALLED HIGH EMOUGH TO PERMIT REMOVAL OF CELLING PANELS OF EQUIPMENT.
- 33. RACEWAY OR CABLE, ETC. THAT PENETRATES A FIRE BARRER, SUCH AS FIRE OR SMOKE RATED SLAB, WALL, CELING, OR OTHER ELEMENT, SHALL BE INSTALLED WITH MATERIALS AND METHODS APPROVED FOR THE APPLICATION BY LOCAL BULLIDIG OFFICIALS. THE CONTRACTOR SHALL BE RESPONSIBLE FOR IDENTIFYING EACH FIRE BARRER FROM THE ARCHTECTURAL PLANS, AND FOR SECURING APPROVAL OF MATERIALS AND METHODS TO BE USED FOR EACH TYPE FIDERTATION.
- 34. UNLESS OTHERWISE INDICATED, RACEWAYS SHALL BE AS FOLLOWS: 1. CONCELED INSIDE WHERE NOT IN WEIT OR DAMP LOCATIONS AND NOT EXPOSED TO DAMAGE AND USED FOR 120Y/20A BRANCH CRUCITS: ELECTRICAL METALLIC TUBING (EUT) OR CABLE THAT IS LISTED IN NEC 250.118 AS AN ACCEPTABLE GROUNDING RETURN PATH, SUCH AS TYPE AC/ANC. 2. THENHAL TWO-INDIR DATE DEE PARPERE OR DIN INC. EVIERINGS.
 - 2. THROUGH TWO-HOUR RATED FIRE BARRERS OR BUILDING EXTERIORS: GALVANIZED RIGID STEEL (GRS) CONDUIT MADE UP WATER TIGHT. 3. FINAL CONNECTION RACEWAYS IN DRY LOCATIONS SERVING LIGHTING FIXTURES, OR OTHER NON-MOTING FOURIMENT LIGHT VT DR FORMER MOVABUT FOR
 - ADJUSTNENT OR LIKELY TO TRANSMIT SHOCK OR VIEWTATION INTO THE RACEWAY System, but not requiring flexibility for operation, and where Approved for the Application shall be flexible metallic turing (flex) where Approved for the Application.
- 35. BOXES SHALL NOT BE INSTALLED BACK-TO-BACK AND THRU-WALL TYPE BOXES SHALL NOT BE USED DUE TO TRANSMISSION OF SOUND OR HEAT AND SMOKE OFFSET TO MAINTAIN FIRE RATING PER UL REQUIREMENTS.
- 36. SUSPENDED CELING CONSTRUCTION SHALL NOT BE USED TO SUPPORT RACEWAYS, BOXES OR OTHER ITEMS, EXCEPT AS ALLOWED BY CODE, ACCEPTED BY THE ENGINEER, AND ACCEPTED BY THE ARCHITECT IN WRITING FOR THE SPECIFIC ITEM(S) TO BE SUPPORTED.
- COVER PLATES FOR FLUSH, DRY, ORDINARY LOCATIONS SHALL BE STANDARD CONFIGURATION, ONE PIECE, STANDARD SIZE PLATES WITH MATCHING SCREWS, AND HAVING MATERIALS, STYLES, AND FINISHES AS SELECTED BY ARCHITECT.
- 38. CONDUIT SYSTEM, IF USED, SHALL BE INSTALLED CONCEALED ABOVE CELLING, ABOVE LONEST POINT OF STRUCTURAL STEEL SYSTEM LOWER CHORD FOR HORIZONTAL RUNS. INSTALL PARALLEL OF PERPENDICULAR TO STRUCTURAL INSUBERS.
- CONFIRM THE FOLLOWING WITH THE OWNER PRIOR TO ROUGH-IN: EXACT LOCATIONS OF RECEPTACLES AND VOICE/DATA/TV OUTLETS; EXACT CONNECTION REQUIREMENTS OF OWNER-PURNISHED CONFIDENT.
- 40. CONFIRM THE EXACT LOCATIONS OF RECEPTACLES, SWITCHES, VOICE/DATA/TV OUTLETS WITH MILLWORK/CASEWORK DETAILS AND ARCHITECTURAL ELEVATIONS.
- 41. ANY CONDUIT EXITING FROM THE INTERIOR TO THE EXTERIOR OF THE BUILDING SHALL BE FILLED WITH AN APPROVED MATERIAL TO PREVENT THE CIRCULATION OF WARM AR TO A COLDER SECTION OF THE RACEWAY PER NEC 300.7A. SEAL ALL CONDUITS ENTERING BUILDING TO PREVENT WATER EXPRESS.
- 42. ALL PANELS SHALL HAVE A TYPED PANEL SCHEDULE. ALL PANELS AND EQUIPMENT SHALL BE CLEAN AND DUST FREE. ALL PANELS AND DISCOMMECTS SHALL BE LABELED WITH NAME AND VOLTAGE. PROVIDE LABELING AT PANEL LOCATION INDICATING NO STORAGE ALLOWED AT PANEL LOCATION.
- 43. THERE SHALL BE AN ISOLATION PAD/BARRIER BETWEEN DISSIMILAR TYPES OF METAL.



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SHEET TITLE:
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