

# CIVIL CONSTRUCTION DOCUMENTS FOR FAYETTE COUNTY OLD IVY - STORM DRAIN REPLACEMENT LAND LOT 22, 6TH DISTRICT, FAYETTE COUNTY, GA. JUNE 8, 2023 100% DESIGN - ISSUED FOR CONSTRUCTION

**POND**  
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Suite 500  
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Georgia 30092  
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**FAYETTE COUNTY**  
140 STONEWALL AVE W, STE 203  
FAYETTEVILLE, GA. 30214

PROJECT NAME

**OLD IVY ROAD  
STORM DRAIN  
REPLACEMENT**

FAYETTE COUNTY, GA

DRAWING ISSUE

JUNE 8, 2023      DATE

100% DESIGN PLANS      DESCRIPTION

MARK

DESIGNED BY:      MDW  
DRAWN BY:          MDW  
CHECKED BY:      DMM/MDM  
SUBMITTED BY:    DMM  
DATE:                JUNE 8, 2023  
PROJECT #          1220341

SHEET TITLE

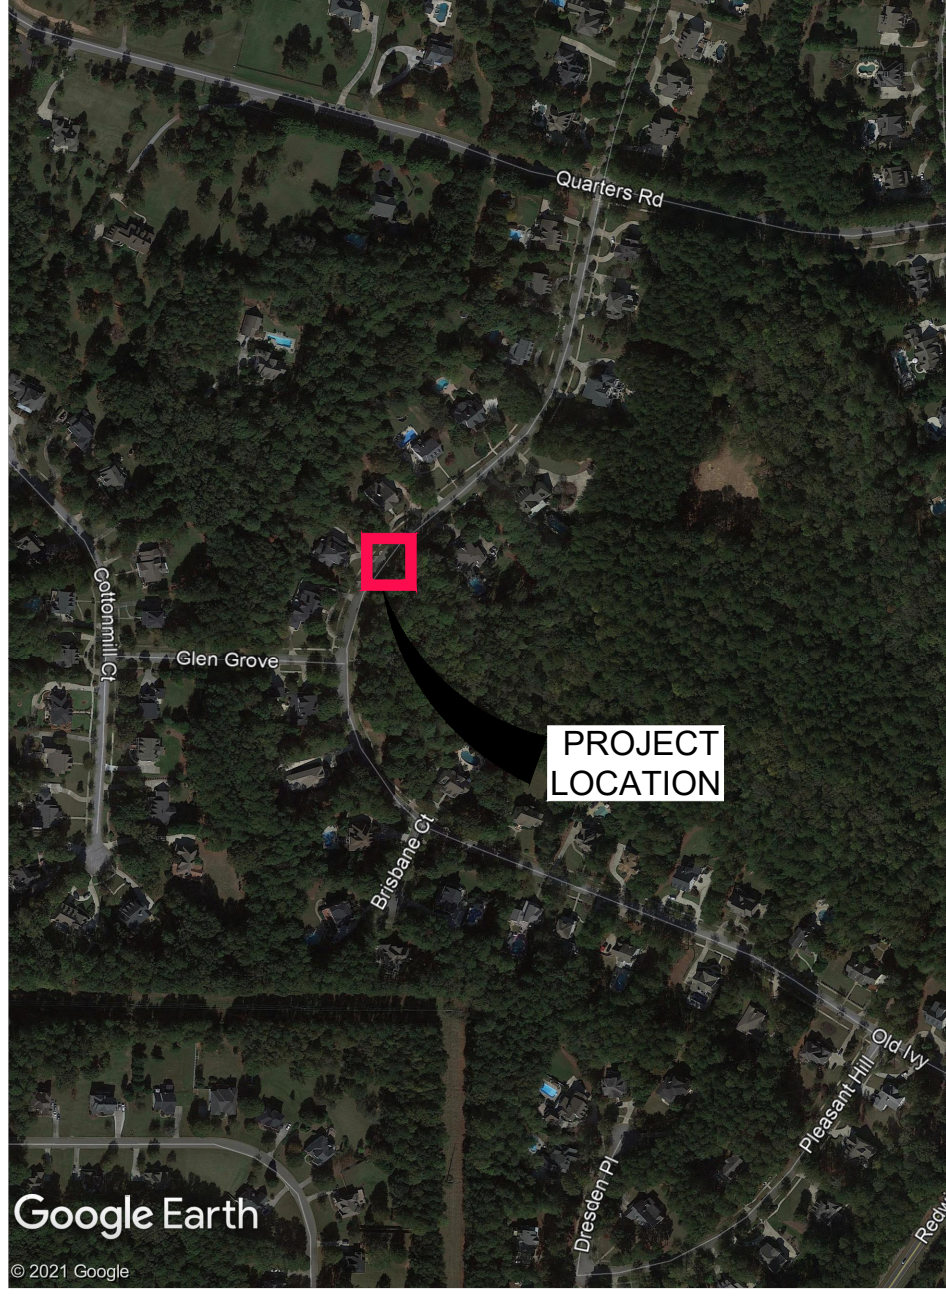
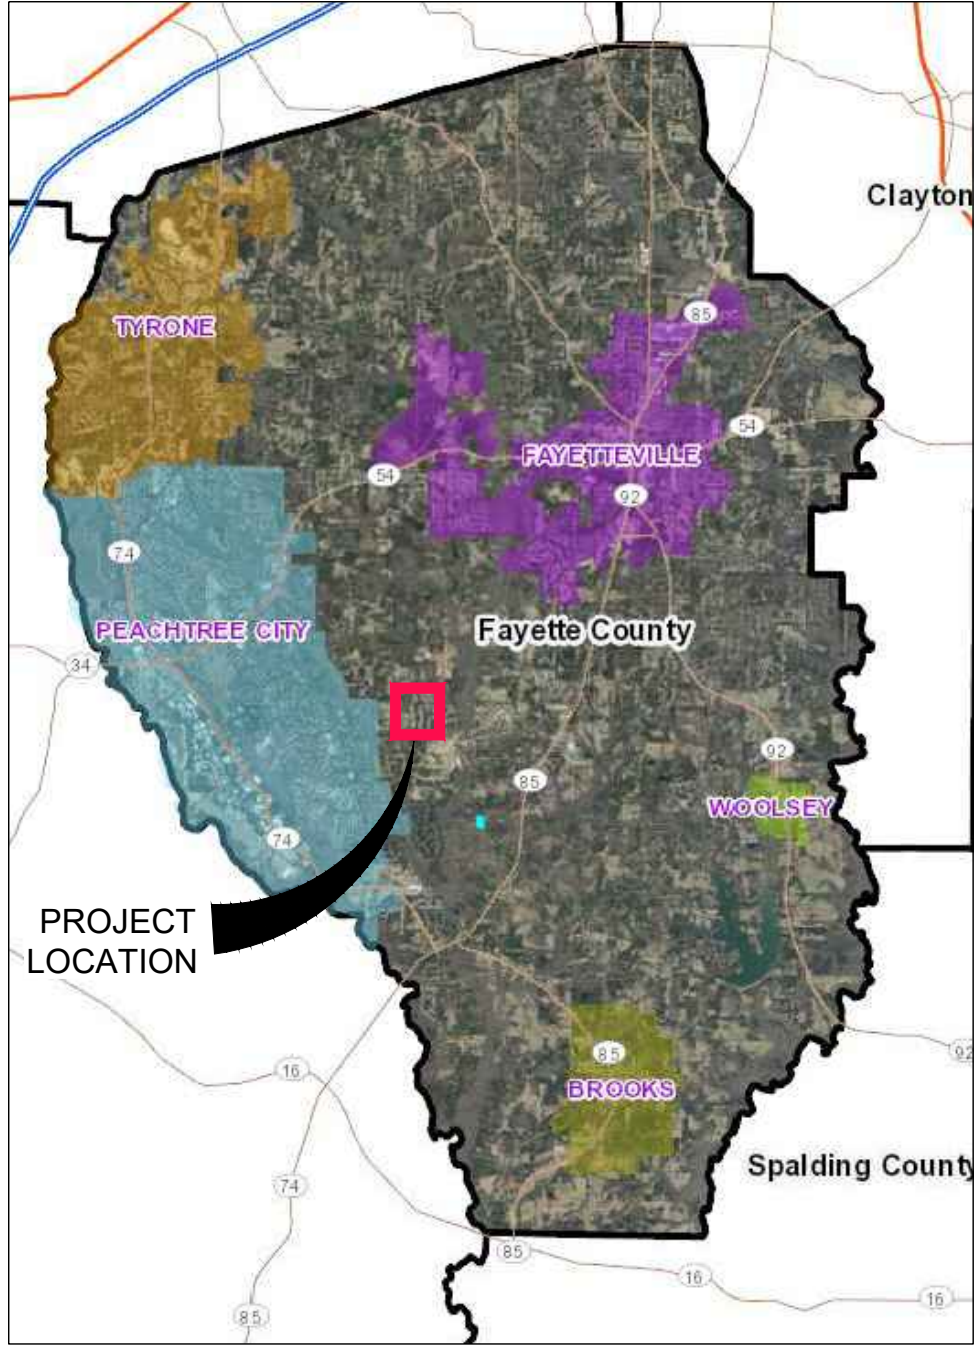
**COVER SHEET**

SHEET NUMBER

**G-001**

SHEET 1 OF 17

ORIGINAL SHEET SIZE:  
22" X 34"



CLIENT INFORMATION	
<b>OWNER CONTACT (24-HR):</b> PHIL MALLON PHONE (770) 313-9855  publicworks@FayetteCountyGA.GOV	<b>CLIENT INFORMATION:</b> FAYETTE COUNTY ENVIRONMENTAL MANAGEMENT 140 STONEWALL AVE. W., SUITE 203, FAYETTEVILLE, GA. 30214
CIVIL DESIGN TEAM	
<b>PROJECT MANAGER:</b> DAVID MORGAN, P.E. MorganD@pondco.com <b>CIVIL ENGINEER:</b> DAVID MORGAN, P.E.	<b>POND AND COMPANY</b> 3500 PARKWAY LANE SUITE 500 PEACHTREE CORNERS, GA 30092 PHONE (678) 336-7740 FAX (678) 336-7744 WEB: www.pondco.com

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CG101	SITE AND GRADING PLAN
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CE002	EROSION & SEDIMENT CONTROL NOTES
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CE503	EROSION & SEDIMENT CONTROL DETAILS
C-501	CONSTRUCTION DETAILS

**PROJECT DESCRIPTION:**  
 THE PROJECT CONSISTS OF REMOVING EXISTING DETERIORATED SINGLE 42" CMP PIPES AND REPLACING WITH 32 LF OF SINGLE 42" PRECAST REINFORCED CONCRETE PIPE CULVERT AND 30 LF AND 40 LF OF SINGLE 42" HDPE PIPE CULVERT. ALL CONSTRUCTION MUST MEET GDOT STANDARD SPECIFICATIONS AND DETAILS.

**PROJECT INFORMATION:**

**DISTURBED AREA:**  
0.08 ACRES

**REFERENCE DATUM:**  
 HORIZONTAL: NAD 1983 (2011) - STATE PLANE COORDINATE SYSTEM OF GEORGIA - WEST ZONE.  
 VERTICAL: NAVD 1988.

**FEMA FIRM:** ZONE X; ZONE AE; 13113C0094E; SEPTEMBER 26, 2008

**PROJECT SPECIFICATION:**  
 THE CONTRACTOR SHALL REFER TO AND USE THE SUPPLIED COUNTY PROJECT SPECIFICATIONS. FOR OTHER APPLICABLE STANDARDS OR SPECIFICATIONS, CONTRACTOR TO USE THE CURRENT GDOT APPROVED STANDARD SPECIFICATION CONSTRUCTION OF TRANSPORTATION SYSTEM DOCUMENT FOR THIS PROJECT.

UTILITY NOTIFICATION/RELOCATION CHECKBOX				
UTILITY COMPANY	PLAN PHASE	CONTACT	DATE NOTIFIED	UTILITY RESPONSE
SOUTHERN COMPANY	95% DESIGN	MFLOYD@SOUTHERNCO.COM WCBRITTI@SOUTHERNCO.COM X2KSTEPH@SOUTHERNCO.COM	9/12/2022	NO RESPONSE
	100% DESIGN		2/16/2023	ACKNOWLEDGED
FAYETTE COUNTY WATER SYSTEM (FCWS)	95% DESIGN	BENJAMIN MARTIN (BMARTIN@FAYETTECOUNTYGA.GOV)	9/12/2022	NO RESPONSE
	100% DESIGN		2/7/2023	ACKNOWLEDGED
COMCAST	95% DESIGN	REGINALD ARNEY (REGINALD_ARNEY@COMCAST.COM)	9/12/2022	NO RESPONSE
	100% DESIGN		2/7/2023	NO RESPONSE
COWETA-FAYETTE EMC	95% DESIGN	STEVE JONES (STJONES@UTILITY.ORG)	9/12/2022	NO RESPONSE
	100% DESIGN		2/7/2023	NO RESPONSE
ATT	95% DESIGN	ANDRE WALTON AW9750@ATT.COM	9/12/2022	NO RESPONSE
	100% DESIGN		2/7/2023	NO RESPONSE
ZAYO	95% DESIGN	ZAYOGEORGIARELOCATIONS@COBBFENDLEY.COM	9/12/2022	NO RESPONSE
	100% DESIGN		2/7/2023	ACKNOWLEDGED

**811** Know what's below.  
Call before you dig.  
Dial 811  
Or Call 800-282-7411

FILE PATH: X:\FY22\122034104\CAD\_BIM\04\_02\CAD\G-001 PLOTTED BY: SANTMIER, ANNA DATE: 6/12/23



GENERAL NOTES

- BENCHMARK FOR CONSTRUCTION HAS BEEN PROVIDED ON SHEET V-001.
- ALL LABOR, MATERIALS, AND METHODS OF CONSTRUCTION SHALL BE IN STRICT ACCORDANCE WITH THE MINIMUM ENGINEERING AND CONSTRUCTION STANDARDS ADOPTED BY GEORGIA DEPARTMENT OF TRANSPORTATION STANDARDS AND SPECIFICATIONS AND FAYETTE COUNTY STANDARDS. WHERE CONFLICTS OR OMISSIONS EXIST, FAYETTE COUNTY STANDARDS SHALL DICATE. SUBSTITUTIONS AND DEVIATION FROM PLANS AND SPECIFICATIONS SHALL BE PERMITTED ONLY WHEN WRITTEN APPROVAL HAS BEEN ISSUED BY THE ENGINEER.
- SHOP DRAWINGS OF ALL MATERIALS BEING USED SHALL BE SUBMITTED TO THE ENGINEER FOR APPROVAL PRIOR TO INSTALLATION.
- ALL MATERIALS AND CONSTRUCTION TO BE IN ACCORDANCE WITH THE GEORGIA DEPARTMENT OF TRANSPORTATION STANDARDS AND SPECIFICATIONS AND FAYETTE COUNTY DEVELOPMENT REGULATIONS, LATEST EDITION, UNLESS OTHERWISE WAIVED.
- IT WILL BE THE RESPONSIBILITY OF THE CONTRACTOR TO ENSURE THAT ALL REQUIRED PERMITS ARE OBTAINED AND IN HAND BEFORE BEGINNING ANY CONSTRUCTION. NO CONSTRUCTION OR FABRICATION OF ANY ITEM SHALL BEGIN UNTIL THE CONTRACTOR HAS RECEIVED ALL PLANS AND ANY OTHER DOCUMENTATION FROM ALL OF THE PERMITTING AND ANY OTHER REGULATORY AUTHORITIES. ANY PENALTIES, STOP WORK ORDERS OR ADDITIONAL WORK RESULTING FROM THE CONTRACTOR BEING IN VIOLATION OF THE REQUIREMENTS ABOVE, SHALL BE FULLY BORNE BY THE CONTRACTOR.
- THE LOCATION OF ALL EXISTING UTILITIES AND STORM DRAINAGE SHOWN ON THE PLANS HAVE BEEN DETERMINED FROM THE BEST INFORMATION AVAILABLE AND ARE GIVEN FOR THE CONVENIENCE OF THE CONTRACTOR. THE ENGINEER ASSUMES NO RESPONSIBILITY FOR INACCURACY. PRIOR TO THE START OF ANY CONSTRUCTION ACTIVITY IT SHALL BE THE CONTRACTOR'S RESPONSIBILITY TO NOTIFY THE VARIOUS UTILITIES AND TO MAKE THE NECESSARY ARRANGEMENTS FOR ANY RELOCATION OF THESE UTILITIES WITH THE OWNER OF THE UTILITY. THE CONTRACTOR SHALL EXERCISE CAUTION WHEN CROSSING UNDERGROUND UTILITIES, WHETHER SHOWN ON THE PLAN OR LOCATED BY THE UTILITY COMPANY. ALL UTILITIES WHICH INTERFERE WITH THE PROPOSED CONSTRUCTION SHALL BE BROUGHT TO THE ATTENTION OF THE ENGINEER FIRST. ANY FEES ASSOCIATED WITH UTILITY RELOCATIONS SHALL BE BORNE IN ACCORDANCE WITH RESPECTIVE UTILITY COMPANY STANDARDS. IT IS REQUESTED UTILITY COMPANIES MOVE THEIR PARTICULAR UTILITIES. ANY DELAY OR INCONVENIENCE CAUSED TO THE CONTRACTOR BY THE RELOCATION OF THE VARIOUS UTILITIES SHALL BE INCIDENTAL TO THE CONTRACT AND NO EXTRA COMPENSATION WILL BE ALLOWED. DIAL 811 BEFORE DIGGING OR CALL 800-282-7411.
- THE CONTRACTOR SHALL SCHEDULE A PRE-CONSTRUCTION MEETING TO BE HELD BETWEEN FAYETTE COUNTY, UTILITIES, ENGINEER OF RECORD, CONTRACTOR AND ANY SUBCONTRACTOR PRIOR TO COMMENCEMENT OF CONSTRUCTION.
- THE SEQUENCE OF CONSTRUCTION SHALL BE SUCH THAT ALL UNDERGROUND INSTALLATIONS OF EVERY KIND, INCLUDING LANDSCAPE SPRINKLERS, SHALL BE PLACED BENEATH THE PAVEMENT AND ITS EDGES PRIOR TO THE CONSTRUCTION OF THE PAVEMENT. THE PAVEMENT SHALL NOT BE CUT WITHOUT PRIOR APPROVAL OF THE ENGINEER.
- THE CONTRACTOR SHALL NOTIFY THE ENGINEER AT LEAST 48 HOURS PRIOR TO BEGINNING CONSTRUCTION AND AT LEAST 48 HOURS BEFORE REQUIRED INSPECTION ON EACH AND EVERY PHASE OF WORK. THE CONTRACTOR SHALL NOTIFY THE ENGINEER A MINIMUM OF 48 HOURS NOTICE PRIOR TO ANY SCHEDULED TESTING. NO PRESSURE TESTING, OR FINAL TESTING WILL BE ACCEPTED UNLESS WITNESSED BY THE ENGINEER'S REPRESENTATIVE. THE CONTRACTOR IS REQUIRED TO NOTIFY 48 HOURS TO FAYETTE COUNTY FOR PROOF ROLL, OF GAB PLACEMENT.
- ALL CONTRACTORS, FAYETTE COUNTY REPRESENTATIVES, AND UTILITY COMPANIES ARE RESPONSIBLE FOR THEIR RESPECTIVE SURVEYING AND LAYOUT FROM BENCHMARK PROVIDED ON CONSTRUCTION PLANS. ANY SURVEY MONUMENTATION DISTURBED DURING CONSTRUCTION SHALL BE REPLACED UPON COMPLETION OF THE WORK BY A REGISTERED LAND SURVEYOR.
- THE CONTRACTOR SHALL BE RESPONSIBLE FOR PREVENTING ANY CONSTRUCTION ACTIVITIES FROM TAKING PLACE OUTSIDE OF THE LIMITS OF CONSTRUCTION SHOWN ON THE PLANS. ANY ON-SITE OR OFFSITE AREAS DISTURBED SHALL BE RESTORED TO ORIGINAL CONDITION OR BETTER.
- THE CONTRACTOR SHALL MAINTAIN A CURRENT SET OF CONSTRUCTION PLANS AND ALL PERMITS ON THE JOB SITE DURING ALL PHASES OF CONSTRUCTION. THE CONTRACTOR SHALL PROVIDE TWO (2) SETS OF RECORD DRAWINGS TO THE ENGINEER OF RECORD WITHIN TWO (2) WEEKS AFTER CONSTRUCTION HAS BEEN COMPLETED ON EACH PHASE.
- TOPOGRAPHIC INFORMATION SHOWN ON THESE PLANS WAS TAKEN FROM SURVEY PROVIDED BY: TERRAMARK LAND SURVEYING INC, DATED: 06-10-2022.
- ANY CONSTRUCTION BEYOND THE RIGHT-OF-WAY AND/OR ESTABLISHED EASEMENT LINES, ONTO ADJACENT PROPERTY, REQUIRES ADJACENT PROPERTY OWNER PERMISSION AND NECESSARY EASEMENTS PRIOR TO PERFORMING ANY WORK. THE CONTRACTOR IS TO VERIFY SUCH EASEMENTS AND PERMISSIONS PRIOR TO DISTURBING ANY OFF-SITE PROPERTY.
- IT IS THE CONTRACTOR'S RESPONSIBILITY TO DETERMINE EXISTING SITE CONDITIONS OF SOIL PRIOR TO N.T.P. CONSTRUCTION TO DETERMINE IF ANY OFF SITE MATERIALS WILL NEED TO BE IMPORTED TO ACHIEVE THE GRADES SPECIFIED ON THE PLANS.
- CLEAR AREAS INDICATED SHALL BE COMPLETELY CLEAR OF ALL TIMBER, BRUSH, STUMPS, ROOTS, GRASS, WEEDS, RUBBISH, AND ALL OTHER DEBRIS AND OBSTRUCTIONS RESTING ON OR PROTRUDING THROUGH THE SURFACE OF THE GROUND.
- PRIOR TO BID PREPARATION, THE CONTRACTOR MUST BECOME FAMILIAR WITH THE OVERALL SITE CONDITIONS AND PERFORM ADDITIONAL INVESTIGATIONS AS DETERMINED NECESSARY TO UNDERSTAND THE LIMIT AND DEPTH OF EXPECTED ORGANIC SILT PEAT AREAS. PRESENCE OF ROCK, ADEQUACY OF EXISTING MATERIALS AS FILL, DEWATERING REQUIREMENTS, CLEAN FILL REQUIRED FROM OFFSITE, AND MATERIALS TO BE DISPOSED OF OFFSITE, ALL OF WHICH WILL AFFECT THE PRICING. ANY DELAY, INCONVENIENCE, OR EXPENSE CAUSED TO THE CONTRACTOR DUE TO INADEQUATE INVESTIGATION OF EXISTING CONDITIONS SHALL BE INCIDENTAL TO THE CONTRACT, AND NO EXTRA COMPENSATION WILL BE ALLOWED. THE MATERIALS ANTICIPATED TO BE ENCOUNTERED DURING CONSTRUCTION MAY REQUIRE DRYING PRIOR TO USE AS BACKFILL, AND THE CONTRACTOR MAY HAVE TO IMPORT MATERIALS, AT NO EXTRA COST, FROM OFFSITE TO MEET THE REQUIREMENTS FOR COMPACTION AND PROPER FILL.
- NEITHER OWNER NOR ENGINEER ASSUMES ANY RESPONSIBILITY FOR ERRORS OR MISINTERPRETATIONS RESULTING FROM USE OF INCOMPLETE SETS OF BIDDING DOCUMENTS.

DEMOLITION NOTES

- THE CONTRACTOR SHALL OBTAIN NECESSARY PERMITS AND LICENSES FOR PERFORMING THE DEMOLITION WORK AND SHALL FURNISH A COPY OF THESE ITEMS TO THE ENGINEER PRIOR TO COMMENCING THE WORK. THE CONTRACTOR SHALL COMPLY WITH THE REQUIREMENTS OF THE PERMITS.
- THE CONTRACTOR SHALL NOTIFY ALL UTILITY COMPANIES OR LOCAL AUTHORITIES FURNISHING GAS, WATER, ELECTRICAL, TELEPHONE, OR SEWER SERVICE SO THEY CAN REMOVE, RELOCATE, DISCONNECT, CAP OR PLUG THEIR EQUIPMENT IN ORDER TO FACILITATE DEMOLITION. DIAL 811 BEFORE DIGGING OR CALL 800-282-7411.
- THE CONTRACTOR IS RESPONSIBLE FOR THE PROTECTION OF ALL TREES, STRUCTURES, AND UTILITIES NOT MARKED FOR REMOVAL OR DEMOLITION AND SHALL PROMPTLY REPAIR ANY DAMAGE AS DIRECTED BY THE ENGINEER AT NO COST TO THE OWNER.
- THE CONTRACTOR SHALL REMOVE PAVING MARKED FOR DEMOLITION WHICH INCLUDES ALL ASPHALT, CONCRETE, BASE, AND RETAINING WALLS (INCLUDING THE FOOTERS).
- THE CONTRACTOR SHALL REMOVE TREES MARKED FOR REMOVAL WHICH INCLUDES THE ROOTS ASSOCIATED WITH THE TREE. TREES NOT MARKED FOR REMOVAL SHALL BE PROTECTED IN ACCORDANCE WITH THE FAYETTE COUNTY REGULATIONS.
- THE CONTRACTOR SHALL REMOVE UNSALVAGEABLE MATERIALS AND YARD WASTE FROM THE SITE IMMEDIATELY AND DISPOSE OF IN ACCORDANCE WITH APPLICABLE FEDERAL, STATE, AND LOCAL REGULATIONS
- THE CONTRACTOR SHALL SAW-CUT A SMOOTH STRAIGHT EDGE ON ANY PAVEMENT PROPOSED FOR DEMOLITION PRIOR TO ITS REMOVAL. PRIOR TO CONNECTING PROPOSED PAVEMENT TO EXISTING PAVEMENT, THE CONTRACTOR SHALL ENSURE THAT THE EDGE OF THE EXISTING PAVEMENT IS STRAIGHT AND UNIFORM.
- CONTRACTOR TO FOLLOW ALL APPLICABLE OSHA STANDARDS FOR ALL EXCAVATIONS.

FAYETTE COUNTY WATER SYSTEM NOTES:

- ALL CONSTRUCTION TO BE IN STRICT ACCORDANCE WITH FAYETTE COUNTY WATER SYSTEM SPECIFICATIONS.
- ALL MATERIALS SHALL CONFORM TO FAYETTE COUNTY DEVELOPMENT SPECIFICATIONS. THE CONTRACTOR SHALL PROVIDE FAYETTE COUNTY WATER SYSTEM SUBMITTALS ON ALL PIPE AND MATERIALS USED FOR APPROVAL. ANY WORK DONE BY THE CONTRACTOR SHALL BE AT HIS OWN RISK UNTIL REVIEW AND APPROVAL OF THESE SUBMITTALS ARE COMPLETE.
- THE CONTRACTOR SHALL NOTIFY THE FAYETTE COUNTY WATER SYSTEM 48 HOURS PRIOR TO CONSTRUCTION TO SCHEDULE A PRE-CONSTRUCTION CONFERENCE.
- THE CONTRACTOR SHALL SCHEDULE AN INSPECTION BY THE FAYETTE COUNTY WATER SYSTEM BEFORE ANY WORK IS HIDDEN FROM VIEW.
- THE CONTRACTOR IS RESPONSIBLE FOR NOTIFYING ALL UTILITIES BEFORE CONSTRUCTION AND VERIFYING THE LOCATION OF ALL UTILITIES SHOWN OR NOT SHOWN.
- IT SHALL BE THE CONTRACTOR'S RESPONSIBILITY TO NOTIFY AND COORDINATE HIS WORK WITH EXISTING UTILITIES WHICH CONFLICT WITH HIS WORK. CONTRACTOR SHALL MAINTAIN SUCH UTILITIES SHOWN OR NOT SHOWN ON THIS PLAN.
- ALL VALVE BOXES ARE TO HAVE COLLARS AND MARKERS AS REQUIRED BY THE FAYETTE COUNTY WATER SYSTEM DEPARTMENT.
- WATER LINES SHALL HAVE A MINIMUM COVER OF 4 FEET FROM FINISHED GRADE.
- MINIMUM HORIZONTAL DISTANCE BETWEEN WATER LINES AND SEWER SHALL BE 10 FEET AND VERTICAL DISTANCE MINIMUM OF 2 FEET.
- ALL OTHER UNDERGROUND UTILITIES OR STRUCTURES SHALL BE A MINIMUM HORIZONTAL AND VERTICAL DISTANCE OF 2 FEET FROM WATER LINES.
- WATER LINES SHALL BE LOCATED 7'-0" FROM THE BACK OF THE CURB OR PER AS APPROVED UTILITY PLACEMENT DETAIL.
- ALL WATER SERVICES SHALL BE MARKED WITH A SAWED "W" NOTCH PAINTED BLUE ON THE CURB.
- ALL WATER MAIN CROSSING UNDER PAVEMENT SHALL BE DIP IN STEEL CASING AS PER FAYETTE COUNTY WATER SYSTEM SPECIFICATIONS.
- ALL VALVES AND FITTINGS ARE TO BE RESTRAINED WITH APPROPRIATE TYPE AND NUMBER OF EBBA IRON OR UNIFLANGE RESTRAINT SYSTEM APPURTENANCES APPROVED BY THE FAYETTE COUNTY WATER SYSTEM PRIOR TO CONSTRUCTION. ANY CONCRETE BLOCKING THAT IS ALLOWED SHALL BE INSTALLED TO UNDISTURBED EARTH.
- ALL SERVICE LINES CROSSING UNDER PAVEMENT OR IN FRONT OF LOTS SHALL BE ENCASED IN 2" CONDUIT MATERIAL APPROVED BY FAYETTE COUNTY WATER SYSTEM.

ESPC NOTES

- AMENDMENTS/REVISIONS TO THE ES&PC PLAN WHICH HAVE A SIGNIFICANT EFFECT ON BMPS WITH A HYDRAULIC COMPONENT MUST BE CERTIFIED BY THE DESIGN PROFESSIONAL.
- WASTE MATERIALS SHALL NOT BE DISCHARGED TO WATERS OF THE STATE, EXCEPT AS AUTHORIZED BY A SECTION 404 PERMIT.
- ALL BUFFERS AND TREE SAVE AREAS SHALL BE CLEARLY IDENTIFIED WITH FLAGGING AND/OR FENCING PRIOR TO COMMENCEMENT OF ANY LAND DISTURBANCE.
- SEDIMENT STORAGE MAINTENANCE INDICATORS MUST BE INSTALLED IN SEDIMENT STORAGE STRUCTURES, INDICATING THE 1/3 FULL VOLUME.
- INSPECT AND DOCUMENT THE CONDITION OF RUNOFF CONTROLS EVERY 7 DAYS, OR EVERY 14 DAYS AND WITHIN 24 HOURS AFTER EACH RAIN OF 0.5 INCH OR MORE.
- PERMITEE SHALL SUBMIT A SIGNED NOTICE OF TERMINATION (NOT) FORM TO THE GEORGIA DIVISION OF WATER AFTER THE SITE HAS BEEN FINALLY STABILIZED.
- 67 CY/AC SEDIMENT STORAGE SUBSTANTIALLY HANDLED BY SILT FENCE. THE LINEAR NATURE OF THIS PROJECT COUPLED WITH LIMITED WORK AREA (ESPECIALLY ADJACENT TO STATE WATER) DOES NOT PROVIDE OPPORTUNITY FOR INSTALLATION OF PERMANENT BMPS TO PREVENT POLLUTANTS FROM DISCHARGING THE SITE WITHOUT FURTHER ENCRACHMENT INTO ADJACENT PRIVATE PROPERTY. DURING CONSTRUCTION, SILT FENCE WILL BE USED TO PREVENT POLLUTANTS FROM DISCHARGING THE SITE. AFTER CONSTRUCTION IS COMPLETE ALL AREAS WILL BE STABILIZED.
- SOIL STOCKPILES MUST BE LOCATED AWAY FROM STREAMS, PONDS, SWALES AND CATCH BASINS. STOCKPILES MUST BE SEEDED, MULCHED, AND ADEQUATELY CONTAINED THROUGH THE USE OF SILT FENCE.
- SEDIMENT-LODEN WATER ENCOUNTERED DURING TRENCHING, BORING, OR OTHER EXCAVATION ACTIVITIES MUST BE PUMPED TO A SEDIMENT TRAPPING OR FILTERING DEVICE AND CLEANED BEFORE BEING DISCHARGED. DISCHARGES TO STORM DRAINS, DITCHES, OR WATER BODIES MUST BE COVERED UNDER A EPD PERMIT.
- ALL BARE SOIL AREAS NOT SUBJECT TO ACTIVE CLEARING, EXCAVATION, GRADING, OR FILL ACTIVITIES MUST BE STABILIZED WITH TEMPORARY OR PERMANENT SEEDING OR MULCHING WITHIN 14 DAYS.
- GOOD HOUSEKEEPING PRACTICES MUST BE APPLIED TO PREVENT CONTAMINATED RUNOFF OR OTHER IMPACTS FROM PAINT OR CONCRETE WASTES, FUELS AND OILS, TRASH AND LITTER, OR OTHER MATERIALS.
- SILT FENCES, DITCH CHECKS, NON-PERMANENT SEDIMENT TRAPS, AND OTHER TEMPORARY CONTROLS MUST BE REMOVED AFTER VEGETATION IN UPGRADING AREAS IS ESTABLISHED AND DITCHES ARE STABLE.
- GOOD HOUSEKEEPING MEASURES FOR MATERIALS STORAGE AND HANDLING, VEHICLE FUELING AND MAINTENANCE, SPILL RESPONSE AND CLEANUP, AND WASTE MANAGEMENT MUST BE FOLLOWED TO ENSURE THAT RUNOFF FROM THE SITE IS FREE OF CONTAMINANTS.
- ALL BMPS SELECTED SHALL BE INSTALLED, OPERATED, AND MAINTAINED ACCORDING TO GSWCC FIELD MANUAL, GEORGIA DIVISION OF WATER GUIDELINES, MANUFACTURER'S REQUIREMENTS, OR STANDARD INDUSTRY PRACTICE, AS APPROPRIATE.
- APPROVED PLANS AND NPDES DAILY LOG MUST BE ONSITE AT ALL TIMES.

EARTHWORK, GRADING, STABILIZATION, PAVING AND DRAINAGE NOTES

- COMPACT ALL UTILITY TRENCHES WITHIN ROADWAYS TO 98% OF THE MODIFIED PROCTOR MAXIMUM DENSITY (AASHTO T - 180) AND TO 95% WITHIN OTHER AREAS.
- ALL ORGANIC SOILS AS DETERMINED WITHIN UTILITY TRENCHES SHALL BE REMOVED AND REPLACED WITH SUITABLE MATERIAL AND COMPACTED TO NO LESS THAN 98% OF THE MODIFIED PROCTOR MAXIMUM DENSITY (AASHTO T - 180).
- STABILIZED SUBGRADE TO MEET SPECIFIED REQUIREMENTS.
- ASPHALTIC CONCRETE TO GDOT STANDARD SPECIFICATION (LATEST EDITION) SECTION 916.1 AND FAYETTE COUNTY, WHICHEVER IS GREATER.
- ALL PAVEMENT MARKINGS SHALL BE THERMOPLASTIC.
- ALL CONCRETE FLUMES, WALKS, AND CURBS SHALL BE CONSTRUCTED WITH 3000 PSI CONCRETE.
- ALL ON-SITE AREAS DISTURBED BY THE CONSTRUCTION SHALL BE STABILIZED USING MEASURES THAT MATCH THE EXISTING VEGETATIVE CONDITIONS OF THE SITE. CONTRACTOR IS RESPONSIBLE FOR IRRIGATION OF PERMANENT GRASSING.
- THE REINFORCED CONCRETE PIPE SHALL BE CLASS III WITH WALL THICKNESS "B" CONFORMING TO ASTM C - 76 OR AWWA 302 -74 AND GASKETS SHALL BE IN ACCORDANCE WITH ASTM C - 443 OR ASTM D - 412.
- ALL PIPE CALL OUTS ARE MEASURED CENTER LINE TO CENTER LINE FOR MANHOLES AND INLETS AND FROM THE END OF THE PIPE FOR MITERED END SECTIONS.
- ALL DEWATERING COSTS ASSOCIATED WITH THE INSTALLATION AND CONSTRUCTION OF THE UNDERGROUND UTILITIES; STORM WATER PIPES AND MANHOLES; SANITARY SEWER MAINS, FORCE MAINS, MANHOLES, AND LIFT STATIONS; AND STORM WATER MANAGEMENT SYSTEMS SHALL BE INCLUDED AS PART OF THE CONSTRUCTION BID COSTS. THE CONTRACTOR SHALL SUBMIT FOR WATER USE PERMITS IF REQUIRED FOR DEWATERING ACTIVITIES.
- ALL PIPES SHALL HAVE 3 FEET MINIMUM COVER UNLESS OTHERWISE SPECIFIED IN PLANS, CONTRACTOR SHALL TAKE CARE TO PROVIDE PROPER GRADE ELEVATIONS AND ALIGNMENTS.
- THE CONTRACTOR MUST INSTALL AND MAINTAIN GRASS OR SOD ON EXPOSED SLOPES WITHIN 48 HOURS OF COMPLETED FINAL GRADES, AS NOTED ON PLANS, AND AT ANY OTHER TIME AS NECESSARY TO PREVENT EROSION, SEDIMENTATION OR TURBID DISCHARGES TO ANY DOWNSTREAM WATER BODY, WETLAND, OR OFF-SITE PROPERTY. SODDING ON SLOPES 3:1 AND STEEPER SHALL BE STAKED.
- THE CONTRACTOR SHALL TAKE ALL MEASURES NECESSARY TO CONTROL TURBIDITY AND SEDIMENT INCLUDING, BUT NOT LIMITED TO, THE INSTALLATION OF TURBIDITY BARRIERS AND SILT FENCES AT ALL LOCATIONS WHERE THE POSSIBILITY OF TRANSFERRING SUSPENDED SOLIDS INTO THE RECEIVING WATER BODY EXISTS DUE TO THE PROPOSED WORK. TURBIDITY AND SEDIMENT BARRIERS MUST BE MAINTAINED AT ALL LOCATIONS UNTIL CONSTRUCTION IS COMPLETED AND DISTURBED SOIL AREAS ARE STABILIZED. THE CONTRACTOR SHALL ALSO BE RESPONSIBLE FOR REMOVING THE BARRIERS.
- EXISTING RUNOFF CURVE NUMBER FOR THE PROJECT: 62. PROPOSED RUNOFF CURVE NUMBER FOR THE PROJECT: 62.
- ALL CONCRETE STRUCTURES SHOWN ARE PRE-CAST FROM AN APPROVED VENDOR. CAST-IN-PLACE METHODS MAY BE USED FOR STRUCTURE COMPONENTS WHERE APPLICABLE FOR APPROVAL.

OTHER UTILITY INFORMATION

- THE CONTRACTOR SHALL NOTIFY UTILITY COMPANIES WHICH MAY HAVE THEIR UTILITIES WITHIN THE CONSTRUCTION AREAS TO LOCATE THEIR FACILITIES IN THE FIELD FORTY-EIGHT (48) HOURS PRIOR TO BEGINNING CONSTRUCTION. DIAL 811 BEFORE DIGGING OR CALL 800-282-7411.
- DUCTILE IRON PIPE SHALL BE ENCASED IN POLYETHYLENE TWENTY-FIVE (25) FEET ON EACH SIDE OF ANY PERPENDICULAR CROSSING OF METALLIC GAS MAINS OR ANY OTHER CATHODICALLY PROTECTED PIPELINE AND FOR LOCATIONS PARALLEL TO AND WITHIN TEN FEET OF METALLIC GAS MAINS OR OTHER CATHODICALLY PROTECTED PIPE AND THROUGH THE AREA OF INFLUENCE OF CATHODIC PROTECTION ANODE BED.

SPILL CONTROL NOTES:

- IN ADDITION TO THE GOOD HOUSEKEEPING AND MATERIAL MANAGEMENT PRACTICES DISCUSSED IN THE PREVIOUS NOTES OF THIS PLAN, THE FOLLOWING PRACTICES WILL BE FOLLOWED FOR SPILL PREVENTION AND CLEANUP:
  - MANUFACTURERS' RECOMMENDED METHODS FOR SPILL CLEANUP WILL BE CLEARLY POSTED AND SITE PERSONNEL WILL BE MADE AWARE OF THE PROCEDURES AND THE LOCATION OF THE INFORMATION AND CLEANUP SUPPLIES.
  - ALL SPILLS WILL BE CLEANED UP IMMEDIATELY AFTER DISCOVERY.
  - SPILLS OF TOXIC OR HAZARDOUS MATERIAL WILL BE REPORTED TO THE APPROPRIATE STATE OR LOCAL GOVERNMENT AGENCY, REGARDLESS OF SIZE.
  - THE SPILL PREVENTION PLAN WILL BE ADJUSTED TO INCLUDE MEASURES TO PREVENT THIS TYPE OF SPILL FROM REOCCURRING AND HOW TO CLEAN UP THE SPILL IF THERE IS ANOTHER ONE. A DESCRIPTION OF THE SPILL, WHAT CAUSED IT, AND THE CLEANUP MEASURES WILL ALSO BE INCLUDED.
  - THE SITE SUPERINTENDENT RESPONSIBLE FOR THE DAY-TO-DAY SITE OPERATIONS WILL BE THE SPILL PREVENTION AND CLEANUP COORDINATOR.
- PETROLEUM BASED PRODUCTS - CONTAINERS FOR PRODUCTS SUCH AS FUELS, LUBRICANTS, AND TARS WILL BE INSPECTED DAILY FOR LEAKS AND SPILLS. THIS INCLUDES ON-SITE VEHICLE AND MACHINERY DAILY INSPECTIONS AND REGULAR PREVENTATIVE MAINTENANCE OF SUCH EQUIPMENT. EQUIPMENT MAINTENANCE AREAS WILL BE LOCATED AWAY FROM STATE WATERS, NATURAL DRAINS AND STORM WATER DRAINAGE INLETS. IN ADDITION, TEMPORARY FUELING TANKS SHALL HAVE A SECONDARY CONTAINMENT LINER TO PREVENT/MINIMIZE SITE CONTAMINATION. DISCHARGE OF OILS, FUELS AND LUBRICANTS IS PROHIBITED. PROPER DISPOSAL METHODS WILL INCLUDE IN A SUITABLE CONTAINER AND DISPOSAL AS REQUIRED BY LOCAL AND STATE REGULATIONS.

TRAFFIC CONTROL NOTES

- A SINGLE INSTANCE OF ROAD CLOSURE FOR UP TO 5 CONSECUTIVE CALENDAR DAYS IS ALLOWED.
- THE CONTRACTOR SHALL SUBMIT A TEMPORARY TRAFFIC CONTROL PLAN TO THE COUNTY FOR APPROVAL PRIOR TO COMMENCEMENT OF CONSTRUCTION ACTIVITIES.
- ALL REQUIRED TRAFFIC SIGNAGE MUST MEET MUTCD STANDARDS.
- ALL REQUIRED TRAFFIC STRIPING MUST MEET MUTCD AND GDOT PLAN SPECIFICATIONS AND MUST BE THERMO-PLASTIC.
- ALL STRIPING LAYOUTS MUST BE APPROVED BY THE COUNTY TRAFFIC ENGINEER PRIOR TO FINAL APPLICATION. CHANGEABLE MESSAGE SIGNS, INFORMING MOTORIST OF THE ROAD CLOSURE SHALL BE INSTALLED A MINIMUM OF TWO (2) WEEKS PRIOR TO THE ROAD CLOSURE. THESE SIGNS SHALL BE INSTALLED AT OR AS NEAR AS POSSIBLE TO THE ROAD CLOSURE (SEE SPECIFICATIONS BELOW):

(ROAD NAME) WILL BE CLOSED TO THRU TRAFFIC FROM (SIDE ROAD) TO (SIDE ROAD)  
(DATE) THRU (DATE)  
FOR INFO CALL (770) 305-5410

Typical Fayette County Water System Construction Notes

- All construction to be in strict accordance with Fayette County Water System (FCWS) Specifications.
- All newly installed water main shall be ductile iron pipe.
- All materials shall conform to Fayette County Development Specifications.
- The contractor shall provide FCWS submittals on all pipe and materials used for approval. Any work done by the contractor shall be at his own risk until review and approval of these submittals are complete.
- Contractors shall adhere to all applicable OSHA regulations.
- The contractor shall notify the FCWS Field Operations Specialist (770) 320-6020 to schedule a pre-construction conference a minimum of 48 hours prior to construction.
- The contractor shall schedule Tie-in, Blocking, Bacterial, and Pressure & Chlorination testing inspections through SagesGov Portal (<https://www.sagesgov.com/fayettecounty-ga>).
- The contractor shall notify the FCWS Field Operations Specialist (770) 320-6020 to schedule additional site visits for inspections before any work is hidden from view.
- The contractor is responsible for notifying all utilities before construction and verifying the location of all utilities shown or not shown.
- All utilities within the public right-of-way requiring relocation or adjustment in order to accommodate proposed improvements shall be relocated or adjusted at the contractor's expense.
- It shall be the contractor's responsibility to notify and coordinate his work with existing utilities which conflict with his work. Contractor shall maintain such utilities shown or not shown on this plan.
- Water lines shall have a minimum cover of 4 feet from finished grade.
- All water main crossing under a roadway (paved or unpaved) intended for vehicular passage shall be in steel casing as per FCWS specifications.
- All valves and fittings are to be restrained with appropriate type and number of EBBA Iron or Uniflange restraint system appurtenances approved by the FCWS prior to construction. Any concrete blocking that is allowed shall be installed to undisturbed earth.
- All valve boxes are to have collars and markers as required by the FCWS. In addition, all valves shall be marked with a sawed "V" notch painted blue on the curb.
- Minimum horizontal and vertical distances between water lines and other underground utilities or structures shall be 2 feet.
- Water lines shall be installed after curb and gutter and 7 feet from the back of the curb or per as approved utility placement detail. End of main shall have hydrant.
- No service taps shall be installed beneath pavement.
- All service lines crossing under pavement or in front of lots shall be encased in 2 inch conduit material approved by Fayette County Water System.
- All water services shall be marked with a sawed "W" notch painted blue on the curb.
- Single and double water service lines shall be minimum of 1 inch Type K copper. For double services 3/4 inch copper after weye will be allowed and shall be no more than 4 feet in length. Service shall terminate with curb stop and meter box. Meter box location shall be approved by FCWS.
- Meter boxes shall be plastic/composite with 1-7/8" diameter opening to allow for attachment of cellular meter endpoint.
- Curb stop shall be horizontal with a depth between 9-11 inches center of flow from final grade.
- All Fire Hydrants shall be 5 1/4 inch valve opening M&H Style 129.
- New water line shall be pressure tested for 2 hours at 200 PSI. Unacceptable leakage shall be repaired and water line shall be retested prior to acceptance by Fayette County Water System. Main must be disinfected prior to being placed in service and have pass bacterial test.



3500 Parkway Lane  
Suite 500  
Peachtree Corners  
Georgia 30092

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DPR SEAL



CLIENT INFORMATION

FAYETTE COUNTY

140 STONEWALL AVE W, STE 203  
FAYETTEVILLE, GA 30214

PROJECT NAME

OLD IVY ROAD STORM DRAIN REPLACEMENT

FAYETTE COUNTY, GA

DRAWING ISSUE

DATE	DESCRIPTION	MARK
JUNE 8, 2023	100% DESIGN PLANS	

DESIGNED BY: MDW  
DRAWN BY: MDW  
CHECKED BY: DMM/MDM  
SUBMITTED BY: DMM  
DATE: JUNE 8, 2023  
PROJECT # 1220341

SHEET TITLE

GENERAL NOTES

SHEET NUMBER

C-002

SHEET 3 OF 17

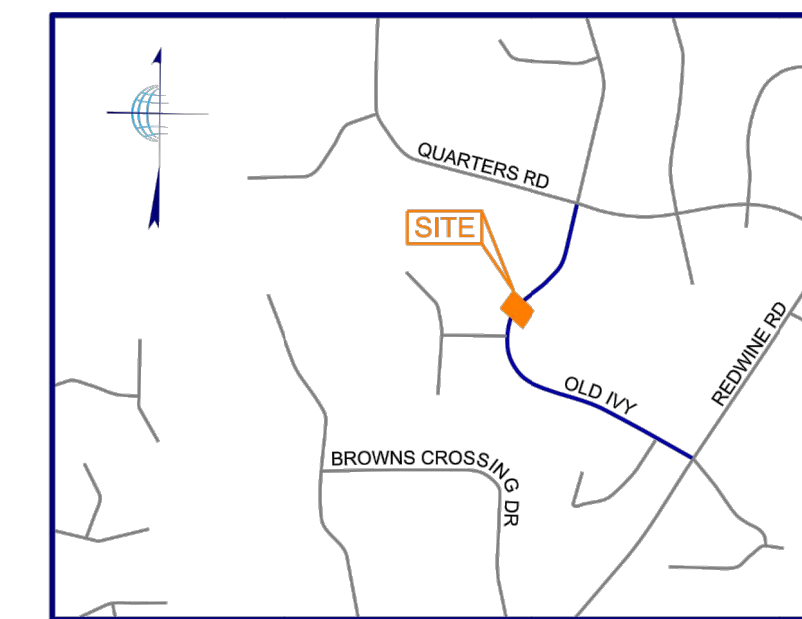
ORIGINAL SHEET SIZE: 22" X 34"

### LEGEND

	CURB AND GUTTER (C&G)		CATCH BASIN (DWCB)		IRRIGATION CONTROL VALVE (ICV)		LIGHT POLE (LP)		CROSSWALK
	FENCE		CATCH BASIN (SWCB)		FIRE HYDRANT (FH)		POWER POLE WITH LIGHT		SPOT ELEVATION
	HANDRAIL		DROP INLET (DI)		WATER VALVE (WV)		UTILITY MANHOLE (UM)		CONCRETE AREA
	STORM DRAIN LINE		JUNCTION BOX (JB)		WATER METER (WM)		SPOTLIGHT		OVERHANG AREA
	SANITARY SEWER		HEAD WALL (HW)		FIRE DEPT. CONNECTION (FDC)		GAS METER (GM)		RIP-RAP AREA
	WATER LINE		CURB INLET (CI)		WATER VALVE MARKER		GAS VALVE (GV)		BRICK AREA
	GAS LINE		FLARED END SECTION (FES)		TRANSFORMER BOX (TX)		TELEPHONE PEDESTAL		TREELINE
	UNDERGROUND POWER LINE		OUTLET CONTROL STRUCTURE		AIR CONDITIONER (AC)		COMMUNICATION BOX		
	OVERHEAD POWER LINE		YARD DRAIN INLET		ELECTRIC METER (EM)		TRAFFIC SIGNAL		
	UNDERGROUND COMMUNICATION		SS MANHOLE (MH)		ELECTRIC UTILITY		BOLLARD (BO)		
	TOPOGRAPHIC CONTOUR		CLEAN OUT (CO)		MAIL BOX		SIGN		
	PROPERTY LINE				GREASE TRAP (GT)				

### TREE LEGEND (ABBREVIATIONS)

	DECIDUOUS (TREE)		BIRCH		HOLLY
	CONIFEROUS (TREE)		BEECH		HARDWOOD
			CRAPE MYRTLE		MAGNOLIA
			CHERRY		MAPLE
			CYPRESS		OAK
			FIR		ORNAMENTAL
			GINKGO		PEAR
			SWEET GUM		POPULAR
			HICKORY		SYCAMORE



### LOCATION MAP

NOT TO SCALE  
LAT - 33°22'44.43"N  
LONG - 84°31'16.43"W

### SURVEY NOTES

**EQUIPMENT USED:**  
A TRIMBLE "S" SERIES TOTAL STATION WAS USED TO OBTAIN ANGULAR MEASUREMENTS AND DISTANCE MEASUREMENTS.

A TRIMBLE R-10 DUAL FREQUENCY GPS UNIT WAS USED FOR ESTABLISHING CONTROL. A NETWORK ADJUSTED RTK SURVEY WAS PERFORMED AND ADJUSTED BY RELATIVE POSITIONAL ACCURACY.

**CLOSURE STATEMENT:**  
NO BOUNDARY SURVEY HAS BEEN PERFORMED BY TERRAMARK LAND SURVEYING, INC. AT THIS TIME. BOUNDARY LINES ARE SHOWN FOR GRAPHICAL REFERENCE ONLY.

THE FIELD DATA UPON WHICH THIS SURVEY IS BASED WAS GENERATED FROM A GPS CONTROL BASELINE.

THE BEARINGS SHOWN ON THIS SURVEY ARE COMPUTED ANGLES BASED ON A GRID BEARING BASE (GA WEST ZONE) NAD83.

ALL HORIZONTAL DISTANCES SHOWN ARE GROUND DISTANCES. MEASURING UNITS OF THIS SURVEY ARE IN U.S. SURVEY FEET.

CONTOURS ARE SHOWN AT ONE FOOT INTERVALS. ELEVATIONS ARE BASED ON RTK GLOBAL POSITIONING SYSTEMS OBSERVATION AND ARE RELATIVE TO NAVD 88 DATUM.

FIELD WORK FOR THIS PROPERTY WAS COMPLETED ON JUNE 8, 2022.

DUE TO VARIANCES IN GPS EQUIPMENT, TECHNIQUES, FEDERAL ADJUSTMENTS TO STATE PLANE MODELS AND DAILY CONDITIONS IMPACTING GPS RECEPTIVITY, GPS SOLUTIONS MAY VARY FROM THOSE PROVIDED ON THIS SURVEY BOTH HORIZONTALLY AND VERTICALLY. ANY AND ALL CONTRACTORS, CONSULTANTS, INDIVIDUALS OR ENTITIES RELYING ON STATE PLANE COORDINATES TO RELATE TO DATA PROVIDED ON THIS SURVEY MUST LOCALIZE TO THE SURVEY CONTROL, BENCHMARKS OR PROPERTY MONUMENTATION ESTABLISHED BY THIS SURVEY IN ORDER TO ENSURE ACCURACY OF DATA. THE OWNER, HIS EMPLOYEES, HIS CONSULTANTS, HIS CONTRACTORS, AND/OR HIS AGENTS SHALL HEREBY DISTINCTLY UNDERSTAND THAT THE SURVEYOR IS NOT RESPONSIBLE FOR ISSUES ENCOUNTERED DUE TO FAILURE TO LOCALIZE DIRECTLY TO THIS SURVEY DATUM.

**INFORMATION REGARDING SIZE, LOCATION, AND SPECIES OF EXISTING TREES IS SHOWN HEREON. THERE IS NO CERTAINTY OF THE SIZE AND SPECIES OF THE SAID TREES WITHOUT VERIFICATION FROM THE DESIGNATED ARBORIST BY THE LOCAL REGULATORY AUTHORITY. THE OWNER, HIS EMPLOYEES, HIS CONSULTANTS, HIS CONTRACTORS, AND/OR HIS AGENTS SHALL HEREBY DISTINCTLY UNDERSTAND THAT THE SURVEYOR IS NOT RESPONSIBLE FOR THE CORRECTNESS OR SUFFICIENCY OF THIS INFORMATION SHOWN HEREON EXCEPT BY APPROVAL OF SAID AUTHORITY.**

THIS SURVEY MAY NOT REPRESENT OFFSITE PAINT STRIPING TO THE ACCURACY REQUIRED FOR LANE DESIGN. TERRAMARK LOCATES THE EDGE OF PAVING AND CRITICAL POINTS TO REFLECT ACCURATE TOPOGRAPHIC DATA ONLY. ACCURACY OF PAINT LOCATIONS SHOULD BE VERIFIED WITH SURVEYOR PRIOR TO USING THIS SURVEY FOR DESIGN.

**INFORMATION REGARDING THE REPUTED PRESENCE, SIZE, CHARACTER, AND LOCATION OF EXISTING UNDERGROUND UTILITIES AND STRUCTURES IS SHOWN HEREON. THERE IS NO CERTAINTY OF THE ACCURACY OF THIS INFORMATION AND IT SHALL BE CONSIDERED IN THAT LIGHT BY THOSE USING THIS DRAWING. THE LOCATION AND ARRANGEMENT OF UNDERGROUND UTILITIES AND STRUCTURES SHOWN HEREON MAY BE INACCURATE AND UTILITIES AND STRUCTURES NOT SHOWN MAY BE ENCOUNTERED. THE OWNER, HIS EMPLOYEES, HIS CONSULTANTS, HIS CONTRACTORS, AND/OR HIS AGENTS SHALL HEREBY DISTINCTLY UNDERSTAND THAT THE SURVEYOR IS NOT RESPONSIBLE FOR THE CORRECTNESS OR SUFFICIENCY OF THIS INFORMATION SHOWN HEREON AS TO SUCH UNDERGROUND INFORMATION.**

**INFORMATION REGARDING STORM SEWER AND SANITARY SEWER AS SHOWN HEREON, IS BASED ON OBSERVATIONS TAKEN BY TERRAMARK EMPLOYEES AT THE GROUND ELEVATION OF THE EXISTING STRUCTURE. TERRAMARK EMPLOYEES ARE NOT AUTHORIZED TO ENTER A CONFINED SPACE SUCH AS A STRUCTURE. THEREFORE, THERE IS NO CERTAINTY OF THE PIPE SIZES AND PIPE MATERIAL THAT ARE SHOWN ON THIS SURVEY. EXCAVATION BY A CERTIFIED CONTRACTOR IS THE ONLY WAY TO VERIFY PIPE SIZE AND MATERIAL. THE OWNER, HIS EMPLOYEES, HIS CONSULTANTS, HIS CONTRACTORS, AND/OR HIS AGENTS SHALL HEREBY DISTINCTLY UNDERSTAND THAT THE SURVEYOR IS NOT RESPONSIBLE FOR THE CORRECTNESS OR SUFFICIENCY OF THE PIPE INFORMATION SHOWN HEREON.**

TERRAMARK LAND SURVEYING, INC. WAS UNABLE TO DETERMINE THE EXTENT OF PIPES MARKED AS APPROXIMATE DIRECTION ONLY. AFORESAID PIPE IS DRAWN ON THE SURVEY TO REFLECT THE OBSERVED DIRECTION BASED UPON A VISUAL INSPECTION OF THE STRUCTURE ONLY AND IS SHOWN FOR INFORMATIONAL PURPOSES.

STATE WATERS AND BUFFERS AS SHOWN OR NOT SHOWN HEREON ARE SUBJECT TO REVIEW BY LOCAL JURISDICTION OFFICIALS. IT IS THE RESPONSIBILITY OF THE LOCAL AUTHORITY TO DETERMINE SPECIFIC WATER CLASSIFICATION. THEREFORE, TERRAMARK LAND SURVEYING ACCEPTS NO RESPONSIBILITY IN THE IDENTIFICATION OF SAID WATERS OR BUFFERS IDENTIFIED OR NOT IDENTIFIED HEREON.

PROPERTY IS SUBJECT TO RIGHTS OF UPPER AND LOWER RIPARIAN OWNERS IN AND TO THE WATER OF CREEKS AND BRANCHES CROSSING OR ADJOINING SUBJECT PROPERTY AND THE NATURAL FLOW, FREE FROM CONTAMINATION OR POLLUTION.

THIS SURVEY WAS PREPARED FOR THE EXCLUSIVE USE OF THE PERSON, PERSONS OR ENTITY NAMED HEREON. THIS SURVEY DOES NOT EXTEND TO ANY UNNAMED PERSON, PERSONS OR ENTITY WITHOUT THE EXPRESS CERTIFICATION BY THE SURVEYOR NAMING SAID PERSON, PERSONS OR ENTITY.

TERRAMARK LAND SURVEYING, INC. DOES NOT WARRANT THE EXISTENCE OR NON-EXISTENCE OF ANY WETLANDS OR HAZARDOUS WASTE IN THE SURVEY AREA.

### TITLE NOTES

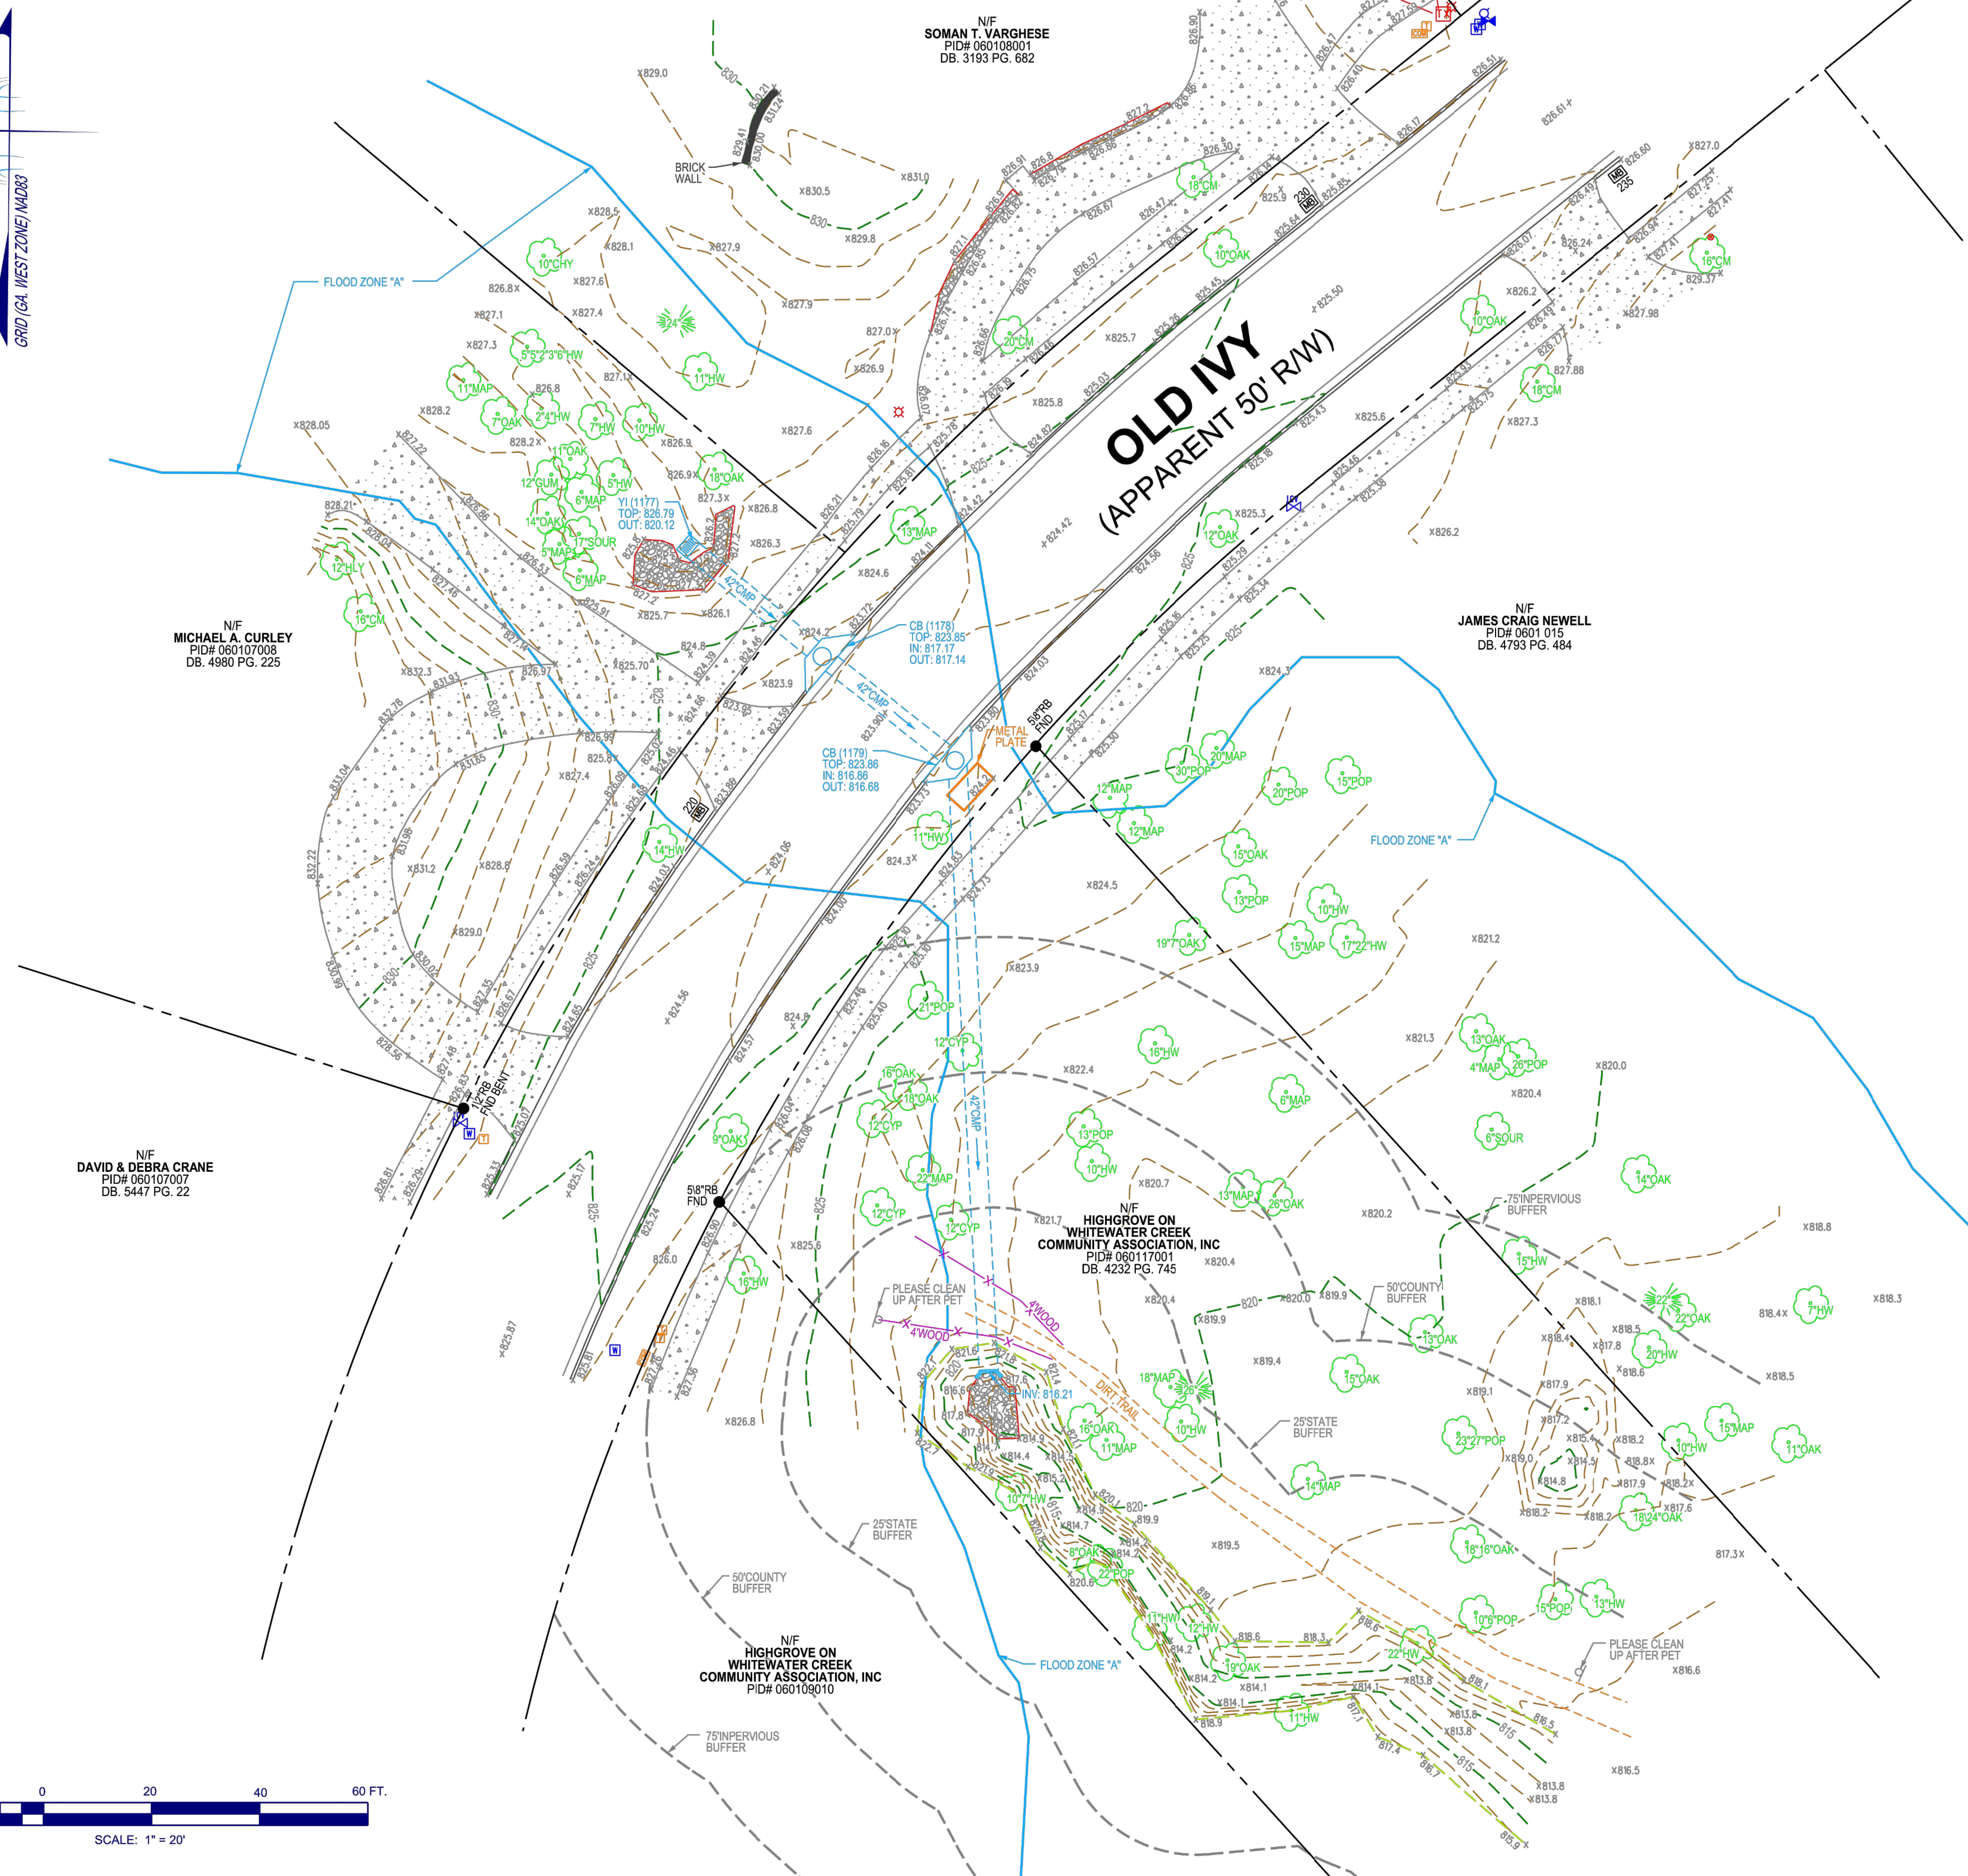
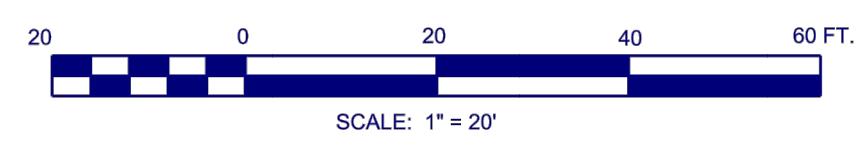
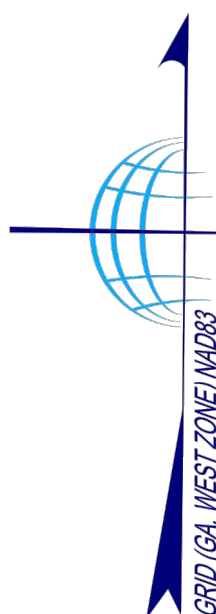
ACCORDING TO THE "FIRM" (FLOOD INSURANCE RATE MAP) OF FAYETTE COUNTY, GEORGIA (PANEL NUMBER 13113C0094E), DATED 9/25/2008, A PORTION OF THIS PROPERTY LIES WITHIN A SPECIAL FLOOD HAZARD AREA.

THIS SURVEY WAS PREPARED WITHOUT THE BENEFIT OF A TITLE REPORT, WHICH COULD REVEAL ENCUMBRANCES NOT SHOWN ON THIS SURVEY.

SUBJECT PROPERTY HAS ACCESS TO THE PUBLIC RIGHT OF WAY OF OLD IVY.

### REFERENCE MATERIAL

- REVISED FINAL PLAT OF HIGHGROVE ON WHITEWATER CREEK PHASE ONE DATED AUGUST 14, 1996 RECORDED IN PLAT BOOK 28 PAGE 109 AMONG THE LAND RECORDS OF FAYETTE COUNTY, GEORGIA
- REVISED FINAL PLAT OF HIGHGROVE ON WHITEWATER CREEK PHASE TWO A DATED JANUARY 5, 1998 RECORDED IN PLAT BOOK 30 PAGE 60 AMONG AFORESAID RECORDS
- MINOR REVISION TO A FINAL OF: LOT 50 & RECREATION AREA HIGHGROVE ON WHITEWATER CREEK PHASE TWO B DATED MAY 30, 2014 RECORDED IN PLAT BOOK 47 PAGE 193 AMONG AFORESAID RECORDS



### BENCHMARK DETAIL

### ABBREVIATIONS

A	ARC LENGTH	IPS	IRON PIN SET (CAPPED)
AC	ACRE	N/F	NOW OR FORMERLY
AE	ACCESS EASEMENT	OTF	OPEN TOP PIPE
B&L	BUILDING SETBACK LINE	PL	PLAT BOOK
BW	BARBWARE	PG	PAGE
CH	CHORD LENGTH	POB	POINT OF BEGINNING
CLF	CHAIN LINK FENCE	POC	POINT OF COMMENCEMENT
CMF	CONCRETE MONUMENT FOUND	R	RADIUS LENGTH
CMP	CORRUGATED METAL PIPE	R/W	RIGHT OF WAY
CONC.	CONCRETE	R/W MON	RIGHT OF WAY MONUMENT
CTP	CRIMP TOP PIPE	RB	REBAR
DB	DEED BOOK	RCB	REINFORCED CONCRETE PIPE
DIP	DUCTILE IRON PIPE	SDE	STORM DRAINAGE EASEMENT
FDC	FIRE DEPARTMENT CONNECTION	SG. FT.	SQUARE FEET
FN	FOUND	SSE	SANITARY SEWER EASEMENT
HDPE	HIGH DENSITY POLYETHYLENE PIPE	WPF	WOOD PRIVACY FENCE
IPF	IRON PIN FOUND		

### UTILITY NOTE

UNDERGROUND UTILITIES SHOWN HEREON ARE BASED ON UTILITY MARKINGS BY REQUEST SUBMITTED TO GA 811. UNDERGROUND UTILITIES MAY EXIST WHICH ARE NOT SHOWN HEREON.

### SPECIAL NOTES

- CERTIFICATION AND DECLARATION IS MADE TO THE ENTITIES AS LISTED IN THE TITLE BLOCK AND/OR CERTIFICATIONS. THE CERTIFICATIONS AND DECLARATIONS ON THIS PLAT ARE NOT TRANSFERABLE TO ADDITIONAL INSTITUTIONS OR SUBSEQUENT OWNERS.
- SUBSURFACE AND ENVIRONMENTAL CONDITIONS WERE NOT EXAMINED OR CONSIDERED AS A PART OF THIS SURVEY. NO STATEMENT IS MADE CONCERNING THE EXISTENCE OF UNDERGROUND OR OVERHEAD CONTAINERS OR FACILITIES THAT MAY AFFECT THE USE OR DEVELOPMENT OF THIS PROPERTY.
- PURSUANT TO RULE 180-4-09 OF THE GEORGIA STATE BOARD OF REGISTRATION FOR PROFESSIONAL ENGINEERS AND SURVEYORS, THE TERM "CERTIFICATION" RELATING TO PROFESSIONAL ENGINEERING AND LAND SURVEYING SERVICES SHALL MEAN A SIGNED STATEMENT BASED UPON FACTS AND KNOWLEDGE KNOWN TO THE REGISTRANT AND IS NOT A GUARANTEE OR WARRANTY, EITHER EXPRESSED OR IMPLIED.
- THIS SURVEY IS NOT PREPARED IN ACCORDANCE TO HB 76 AND SHALL NOT BE RECORDED WITHIN THE APPLICABLE LAND RECORDS.

### SURVEYOR'S CERTIFICATE

THIS SURVEY WAS PREPARED UNDER MY DIRECT SUPERVISION, THE INFORMATION SHOWN HEREON IS ACCURATE AND CORRECT TO THE BEST OF MY KNOWLEDGE, INFORMATION AND BELIEF.



PAUL B. CANNON, RLS  
REGISTERED NUMBER: 2928

PARTIAL TOPOGRAPHIC SURVEY FOR POND AND COMPANY (220 OLD IVY) LOCATED IN LAND LOT 22, 6TH DISTRICT FAYETTE COUNTY, GEORGIA

SHEET NO.

1/1

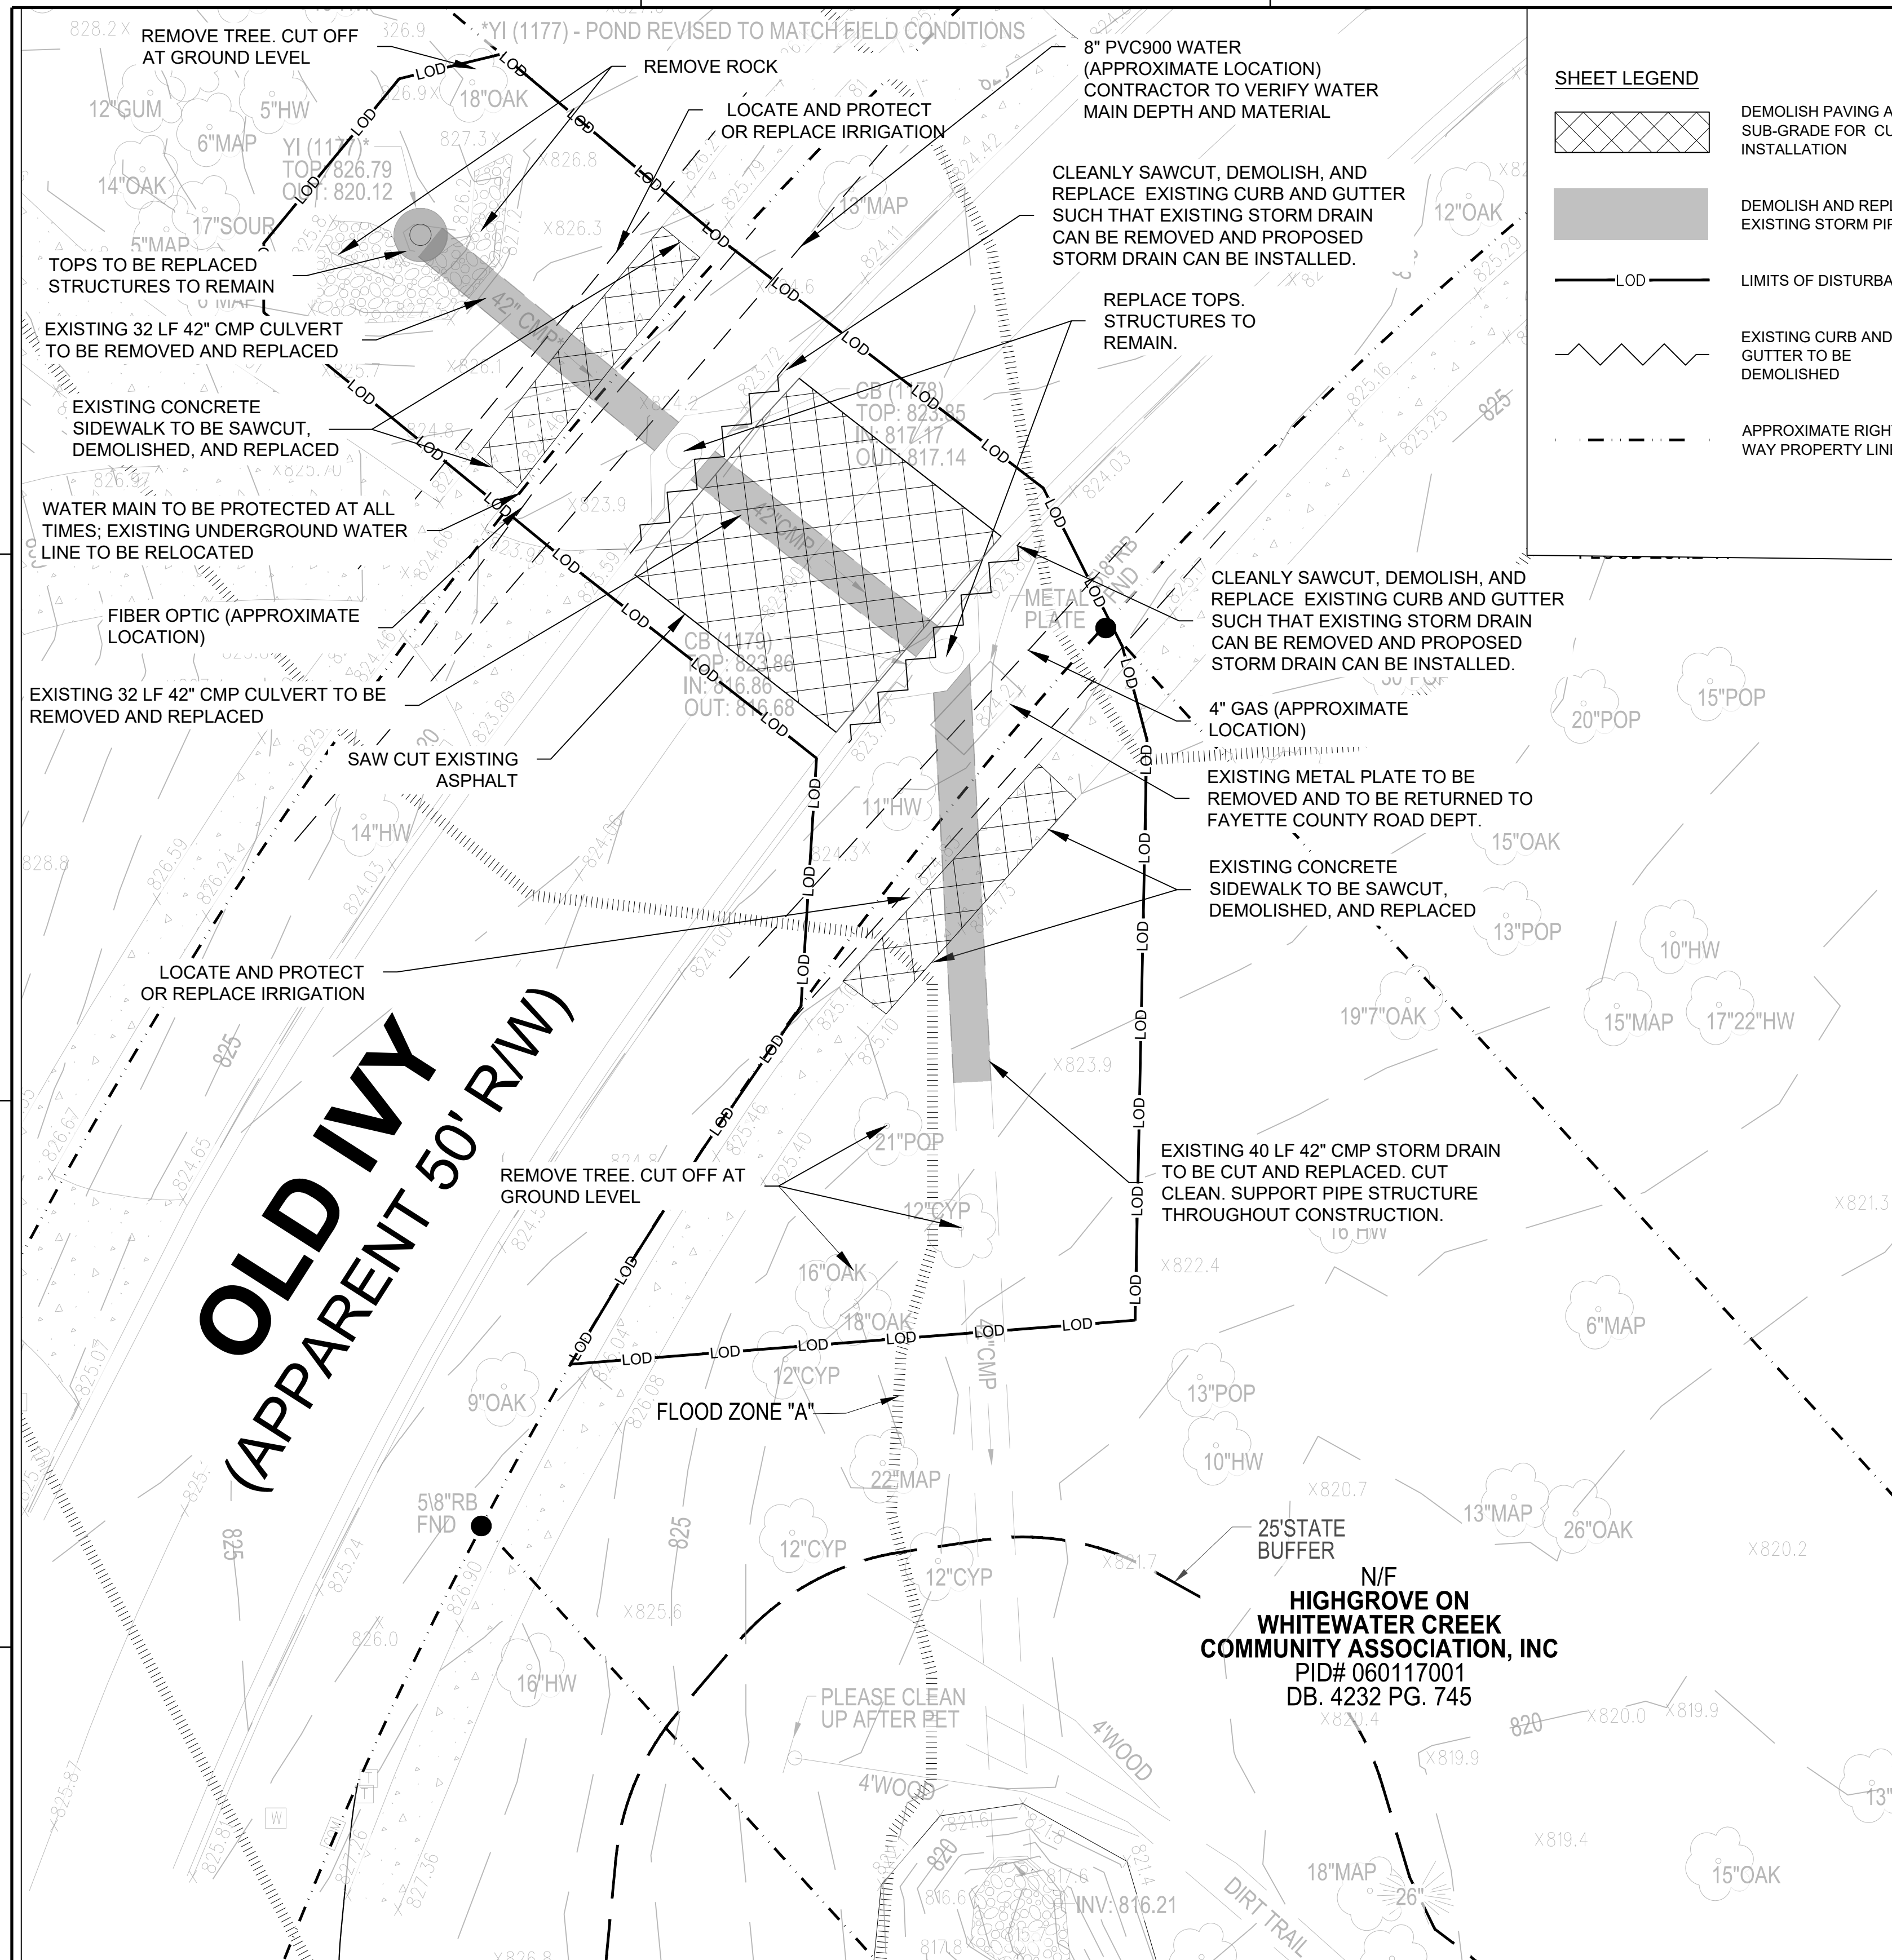
DRAWING# TM 22-137

TerraMark Land Surveying, Inc.  
10000 Georgia 30086  
Phone No. (770) 421-1927  
Fax No. (770) 421-0552  
www.TerraMark.com  
C. O. A.#LSF000810



Project No.	No.	Date	Revision
2022-137	#1		
	#2		
	#3		
	#4		
	#5		
	#6		
	#7		
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**SHEET LEGEND**


- DEMOLISH PAVING AND SUB-GRADE FOR CULVERT INSTALLATION
- DEMOLISH AND REPLACE EXISTING STORM PIPE
- LIMITS OF DISTURBANCE
- EXISTING CURB AND GUTTER TO BE DEMOLISHED
- APPROXIMATE RIGHT OF WAY PROPERTY LINE

- GENERAL SHEET NOTES:**
- REFER TO SHEETS C-001 AND C-002 FOR LEGENDS, ABBREVIATIONS, AND CIVIL NOTES.
  - THIS SHEET IS PART OF A MULTI-SHEET SET OF CONSTRUCTION PLANS AND SHALL BE READ WITH THE FULL SET TO BEST ENSURE PROPER INTERPRETATION.
  - CONTRACTOR TO COORDINATE ROAD AND LANE CLOSURE WITH FAYETTE COUNTY AND ENGINEER.
  - ALL CONCRETE FORMWORK AND REINFORCING BARS TO BE INSPECTED BY THE FIELD REPRESENTATIVE IN CONJUNCTION WITH THE CONTRACTORS REPRESENTATIVE BEFORE CONCRETE IS PLACED.
  - AS-BUILT DRAWINGS SHALL CONTAIN ALL RELEVANT ELEVATIONS AND INVERTS. (SHALL BE CERTIFIED BY A GEORGIA REGISTERED LAND SURVEYOR)
  - CONTRACTOR TO ESTABLISH TEMPORARY SUPPORT FOR EXISTING UTILITIES AND MAINTAIN THROUGHOUT CONSTRUCTION.
  - CONTRACTOR TO MAINTAIN UTILITY SERVICES DURING CONSTRUCTION, WITH MINIMAL INTERRUPTION.
  - CONTRACTOR TO BE RESPONSIBLE FOR THE REPAIR OF ANY DAMAGED CURB, DRIVEWAYS, ASPHALT, FENCING OR EXISTING ROADWAY OUTSIDE OF PROJECT LIMITS DURING CONSTRUCTION.
  - ANY DAMAGED ASPHALT OUTSIDE OF THE RESURFACE OR PAVING LIMITS SHOWN ON PLANS WILL BE REQUIRED TO BE MILLED AND RESURFACED AT NO ADDITIONAL COST TO THE COUNTY.
  - CONTRACTOR SHALL COORDINATE WITH UTILITY OWNERS TO PROTECT OR RELOCATE THE EXISTING INFRASTRUCTURE INCLUDING BUT NOT LIMITED TO GAS, COMMUNICATIONS, POWER, AND WATER.
  - EXISTING CONDITIONS AS SHOWN ARE BASED ON SURVEY PROVIDED IN GENERAL NOTES #13 FROM SHEET C-002. EXISTING CONDITIONS SHOULD BE CONSIDERED APPROXIMATE AND SHOULD BE CONFIRMED BY CONTRACTOR PRIOR TO WORK.
  - CULVERT STREAM BEDDING MATERIAL IS ALLOWED BY FAYETTE COUNTY TO BE EMBED NATURALLY WITH FLOW.
  - THE LIMITS OF DISTURBANCE SHALL BE CLEARED IN ENTIRETY.
  - TOPOGRAPHIC SURVEY OF 220 OLD IVY FOR FAYETTE COUNTY, PREPARED BY: TERRAMARK, DATED: 6/10/2022.

- DEMOLITION NOTES:**
- A. PROTECTION:**
- PERFORM DEMOLITION SO AS TO PREVENT DAMAGE TO ADJACENT IMPROVEMENTS AND FACILITIES TO REMAIN TO INCLUDE AREAS OUTSIDE OF APPROVED LIMITS OF DISTURBANCE
  - PROTECT NEW OR EXISTING WORK FROM DAMAGE DURING DEMOLITION OPERATIONS.
  - PROTECT EXISTING SITE APPURTENANCES AND LANDSCAPING TO REMAIN.
  - DAMAGES: WITHOUT COST TO THE OWNER AND WITHOUT DELAY, REPAIR ANY DAMAGES CAUSED TO FACILITIES TO REMAIN. CONTRACTOR TO BE RESPONSIBLE FOR THE REPAIR OF ANY DAMAGED ROADWAY/ASPHALT DURING PROJECT CONSTRUCTION.
  - CONTRACTOR TO ESTABLISH TEMPORARY BENCHMARKS ON SITE AT LOCATIONS THAT WILL REMAIN UNDISTURBED THROUGHOUT CONSTRUCTION.
  - CONTRACTOR TO COORDINATE WITH THE COUNTY AND UTILITY COMPANIES ON THE RELOCATION OF UTILITIES.
  - CONTRACTOR TO MAINTAIN ACCESS TO AFFECTED PROPERTIES AT ALL TIMES.
- B. REMOVAL & DISPOSAL OF DEMOLISHED MATERIALS:**
- ALL DEMOLISHED OR REMOVED ITEMS AND MATERIALS SHALL BE CONSIDERED SCRAP EXCEPT FOR THOSE INDICATED TO REMAIN, THOSE INDICATED TO BE REINSTALLED, THOSE INDICATED TO BE SALVAGED, AND HISTORICAL ITEMS.
  - ALL ITEMS INDICATED TO REMAIN SHALL BE PROTECTED AGAINST DAMAGE DURING DEMOLITION OPERATIONS.
  - PROMPTLY DISPOSE OF MATERIALS RESULTING FROM DEMOLITION OPERATIONS. DO NOT ALLOW MATERIALS TO ACCUMULATED ON SITE.
  - TRANSPORT MATERIALS RESULTING FROM DEMOLITION OPERATIONS AND LEGALLY DISPOSE OF OFF-SITE.
  - OFF-SITE DISPOSAL LOCATION SHALL NOT BE WITHIN ONE-HALF MILE OF ANY PORTION OF THE PROJECT SITE OR WITHIN SIGHT OF THE PROJECT SITE.
  - DO NOT BURN REMOVED MATERIALS ON PROJECT SITE.
  - CONTRACTOR TO COORDINATE THE LOCATION OF ANY MATERIAL LAYDOWN AREAS WITH THE COUNTY AND MAINTAIN ENOUGH CLEAR SPACE FOR CONSTRUCTION EQUIPMENT ACCESS.
  - ONSITE EXCAVATED MATERIAL MAY NOT BE SUITABLE FOR RE-USE. CONTRACTOR PRICING SHALL INCLUDE ALL MATERIALS INCLUDING IMPORTED FILL, AS NECESSARY.
- C. POLLUTION CONTROLS:**
- CONTROL THE SPREAD OF DUST AND DIRT WITH PRACTICAL MEANS.
  - OBSERVE ENVIRONMENTAL PROTECTION REGULATIONS.
  - DO NOT ALLOW WATER USAGE THAT RESULTS IN FREEZING OR FLOODING.
  - DO NOT ALLOW ADJACENT IMPROVEMENTS TO REMAIN TO BECOME SOILED BY DEMOLITION OPERATIONS.
- D. CLEANING:**
- REMOVE TOOLS AND EQUIPMENT. DISPOSE OF SCRAP.
  - LEAVE EXTERIOR AREAS FREE OF DEBRIS.
  - CLEAN SOIL, SMUDGES, AND DUST FROM SURFACES TO REMAIN.
  - RETURN STRUCTURES AND SURFACES TO REMAIN TO CONDITION EXISTING PRIOR TO COMMENCEMENT OF DEMOLITION.

**POND**  
 3500 Parkway Lane  
 Suite 500  
 Peachtree Corners  
 Georgia 30092

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CLIENT INFORMATION

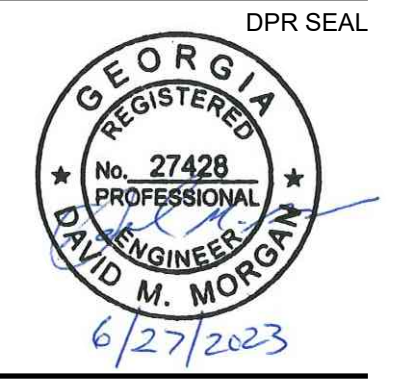**FAYETTE COUNTY**  
 140 STONEWALL AVE W, STE 203  
 FAYETTEVILLE, GA. 30214

PROJECT NAME

**OLD IVY ROAD  
 STORM DRAIN  
 REPLACEMENT**

FAYETTE COUNTY, GA

DRAWING ISSUE

JUNE 8, 2023 DATE

100% DESIGN PLANS DESCRIPTION

MARK

DESIGNED BY: MDW  
 DRAWN BY: MDW  
 CHECKED BY: DMM/MDM  
 SUBMITTED BY: DMM  
 DATE: JUNE 8, 2023  
 PROJECT #: 1220341

SHEET TITLE

**SITE  
 DEMOLITION  
 PLAN**

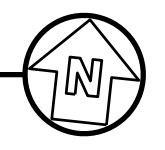
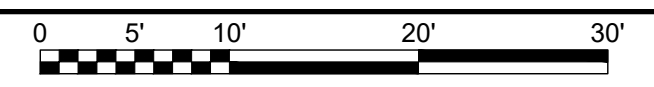
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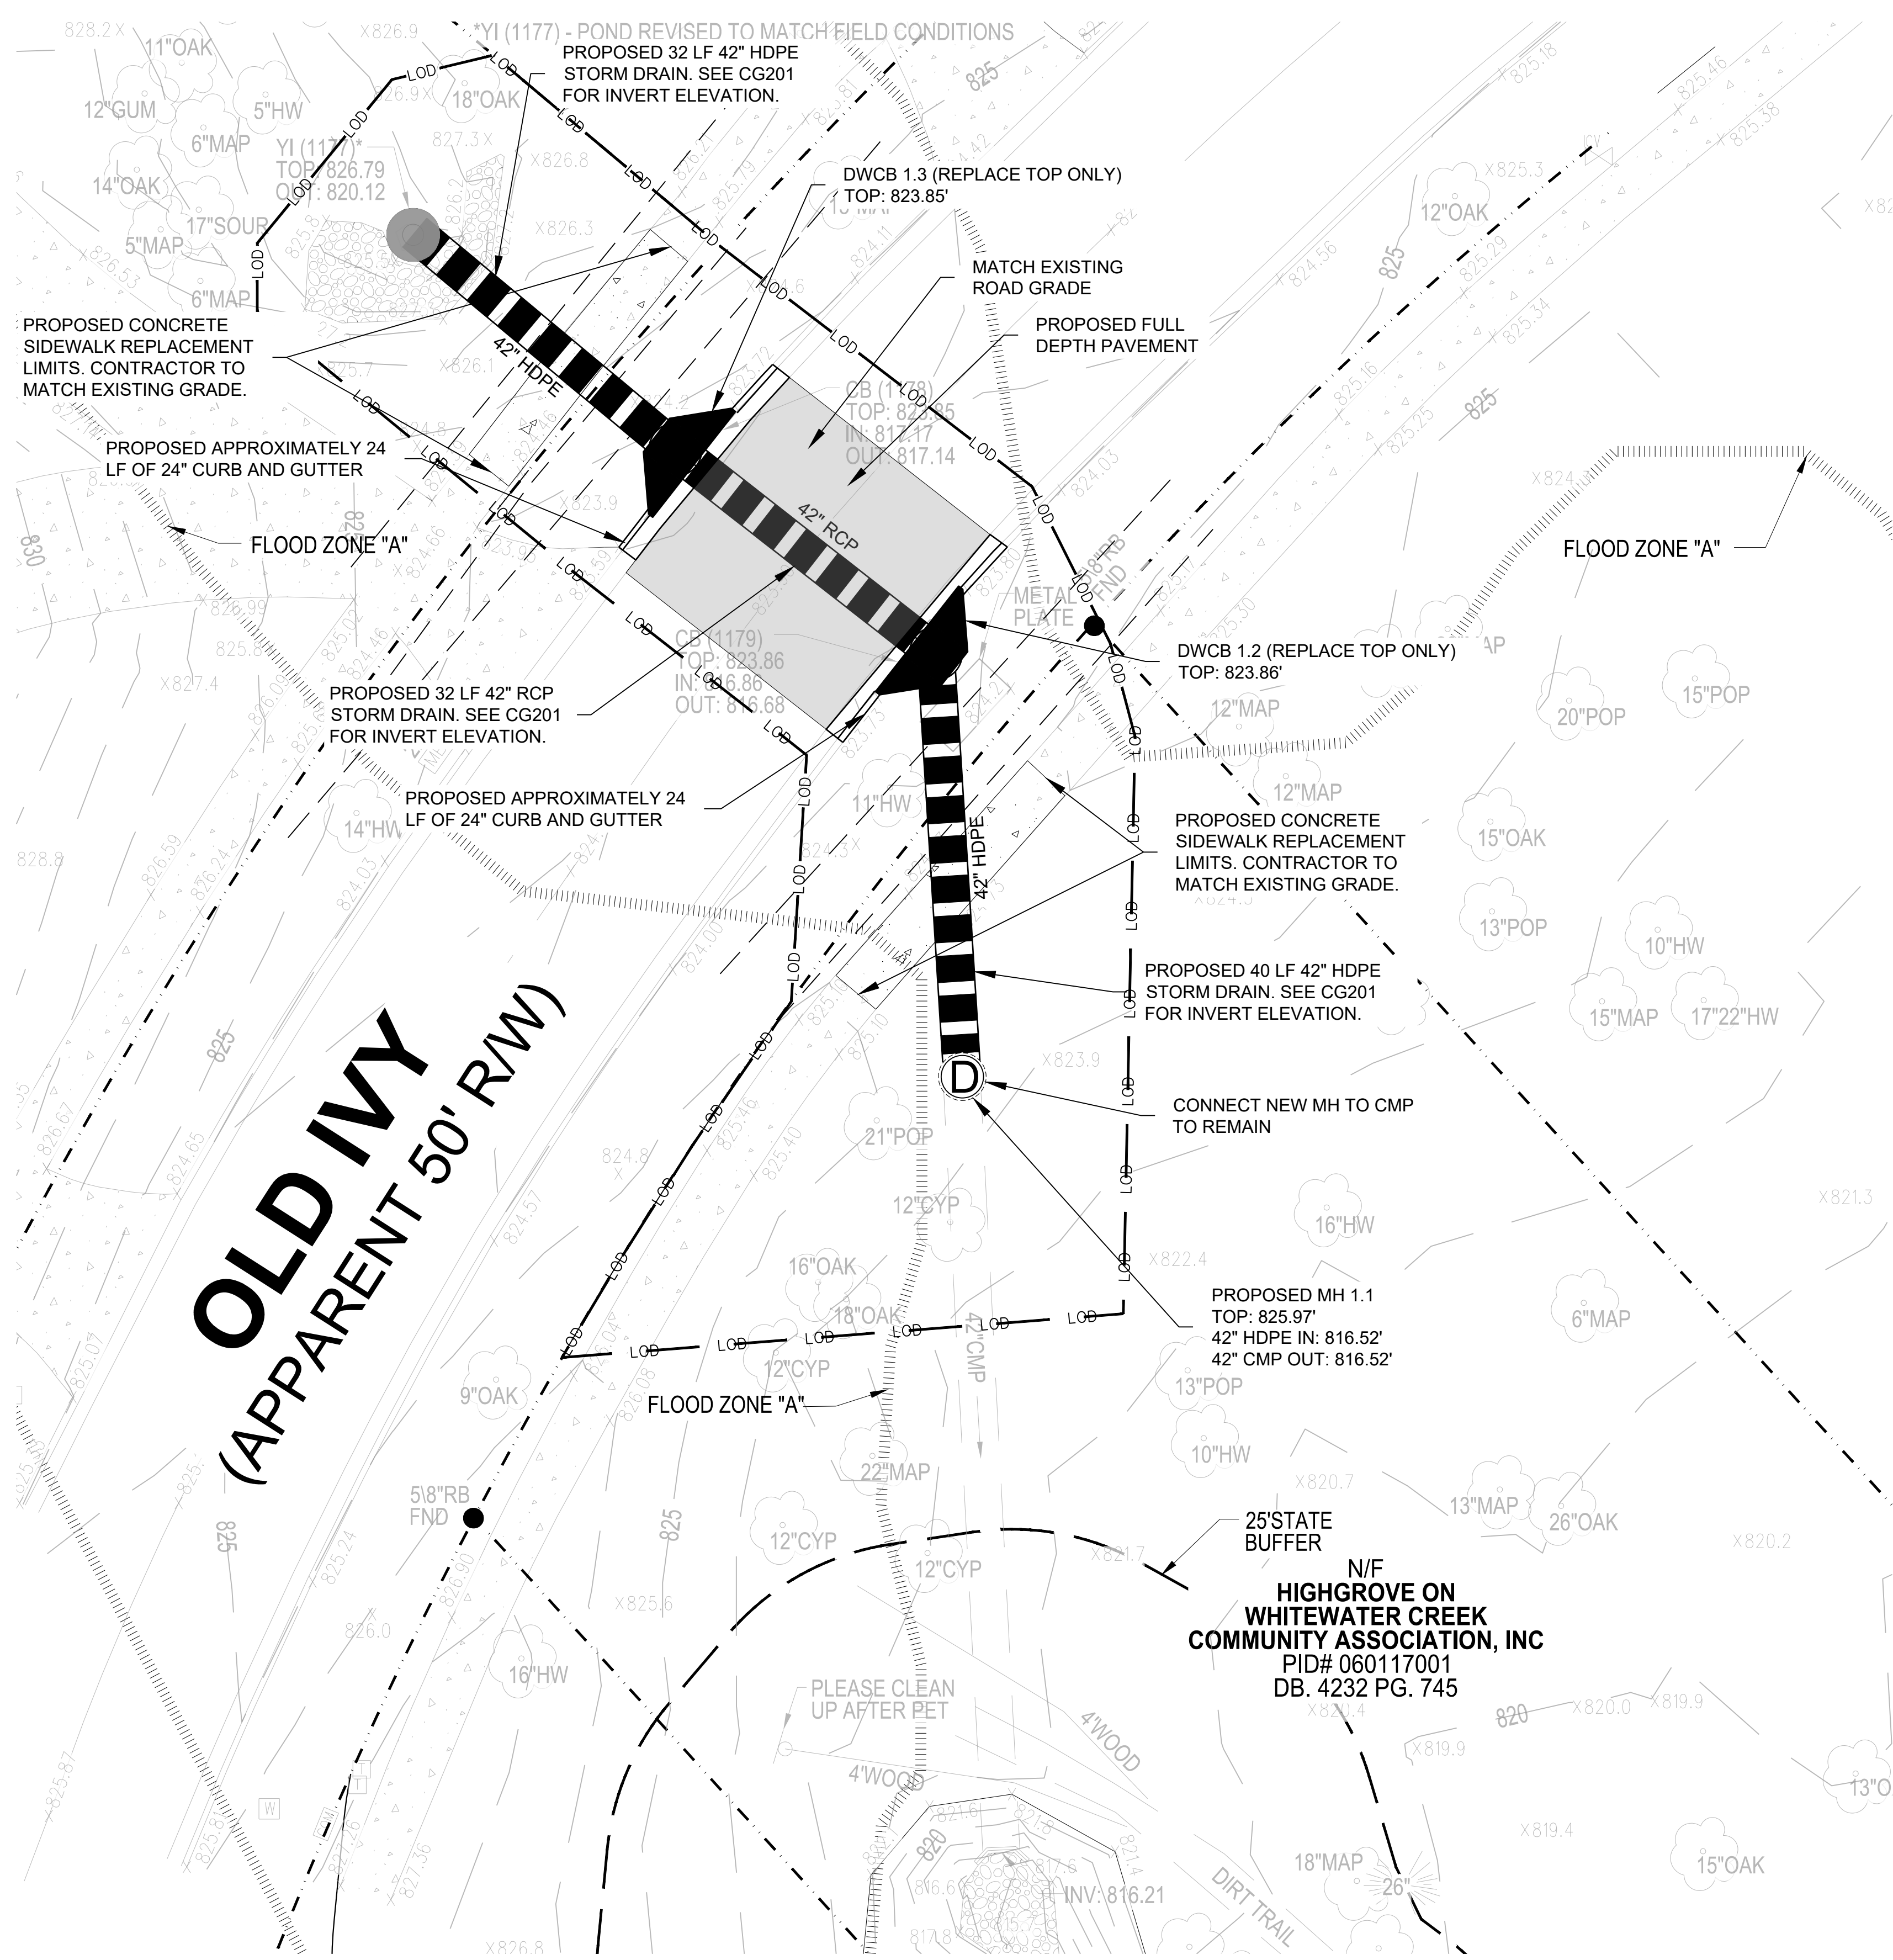
**CD101**

SHEET 5 OF 17

ORIGINAL SHEET SIZE:  
 22" X 34"

**A1 SITE DEMOLITION PLAN**  
 SCALE: 1" = 10'





GENERAL SHEET NOTES

- REFER TO SHEETS C-001 AND C-002 FOR LEGENDS, ABBREVIATIONS, AND CIVIL NOTES.
- THIS SHEET IS PART OF A MULTI-SHEET SET OF CONSTRUCTION PLANS AND SHALL BE READ WITH THE FULL SET TO BEST ENSURE PROPER INTERPRETATION.
- CONTRACTOR TO COORDINATE LANE CLOSURE WITH FAYETTE COUNTY AND ENGINEER. CONFORM TO THE MANUAL ON UNIFORM TRAFFIC CONTROL DEVICE (MUTCD) AND GDOT STANDARDS.
- ALL CONCRETE FORMWORK AND REINFORCING BARS TO BE INSPECTED BY ENGINEER'S OR OWNER'S FIELD REPRESENTATIVE IN CONJUNCTION WITH THE CONTRACTOR'S REPRESENTATIVE BEFORE CONCRETE IS PLACED.
- AS-BUILT DRAWINGS SHALL CONTAIN ALL RELEVANT ELEVATIONS AND INVERTS. (ALL AS-BUILT DRAWINGS SHOULD BE CERTIFIED BY A GEORGIA REGISTERED LAND SURVEYOR).
- CONTRACTOR TO ESTABLISH TEMPORARY SUPPORT FOR EXISTING UTILITIES AND MAINTAIN IT THROUGHOUT CONSTRUCTION.
- CONTRACTOR TO BE RESPONSIBLE FOR THE REPAIR OF ANY DAMAGED CURB OR DRIVEWAYS DURING CONSTRUCTION.
- CONTRACTOR TO BE RESPONSIBLE FOR THE REPAIR OF ANY DAMAGED ROADWAY/ASPHALT DURING PROJECT CONSTRUCTION, AS WELL AS REPLACEMENT AND RELOCATION OF MAILBOXES.
- DOWNSIDE CMP PIPE TO REMAIN MAY BE IN POOR CONDITION. THE PIPE CONDITIONS WILL DETERMINED IF THE NEW MANHOLE CAN BE PRECAST OR CAST-IN-PLACE.

GRADING NOTES:

- ROAD TO BE GRADED FROM CROWN TO EDGE OF ASPHALT AT 1/4" PER 1'
- MAXIMUM SLOPES ALLOWED WITHIN FAYETTE COUNTY RIGHT-OF-WAY SHALL BE 2:1. PROVIDE GENTLER SLOPES WHERE POSSIBLE.

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 CLIENT INFORMATION

**FAYETTE COUNTY**  
 140 STONEWALL AVE W, STE 203  
 FAYETTEVILLE, GA 30214

PROJECT NAME  
**OLD IVY ROAD  
 STORM DRAIN  
 REPLACEMENT**  
 FAYETTE COUNTY, GA


DATE	DESCRIPTION	MARK
JUNE 8, 2023	100% DESIGN PLANS	

DESIGNED BY: MDW  
 DRAWN BY: MDW  
 CHECKED BY: DMM/MDM  
 SUBMITTED BY: DMM  
 DATE: JUNE 8, 2023  
 PROJECT #: 1220341

SITE AND GRADING PLAN

SHEET NUMBER  
**CG101**  
 SHEET ---- OF 17  
 ORIGINAL SHEET SIZE:  
 22" X 34"

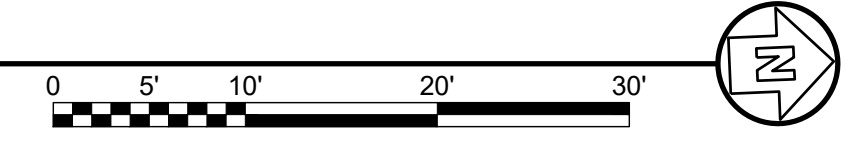
**A1 SITE AND GRADING PLAN**  
 SCALE: 1" = 10'





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CLIENT INFORMATION

**FAYETTE COUNTY**

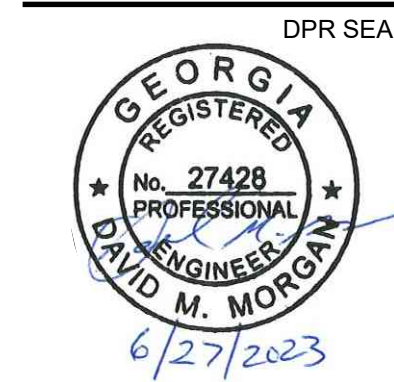140 STONEWALL AVE W, STE 203  
FAYETTEVILLE, GA, 30214

PROJECT NAME

**OLD IVY ROAD  
STORM DRAIN  
REPLACEMENT**

FAYETTE COUNTY, GA

DRAWING ISSUE

JUNE 8, 2023  
DATE

100% DESIGN PLANS  
DESCRIPTION

MARK

DESIGNED BY: MDW  
DRAWN BY: MDW  
CHECKED BY: DMM/MDM  
SUBMITTED BY: DMM  
DATE: JUNE 8, 2023  
PROJECT #: 1220341

SHEET TITLE


**STORM DRAIN  
PROFILE**

SHEET NUMBER

**CG201**

SHEET ---- OF 17

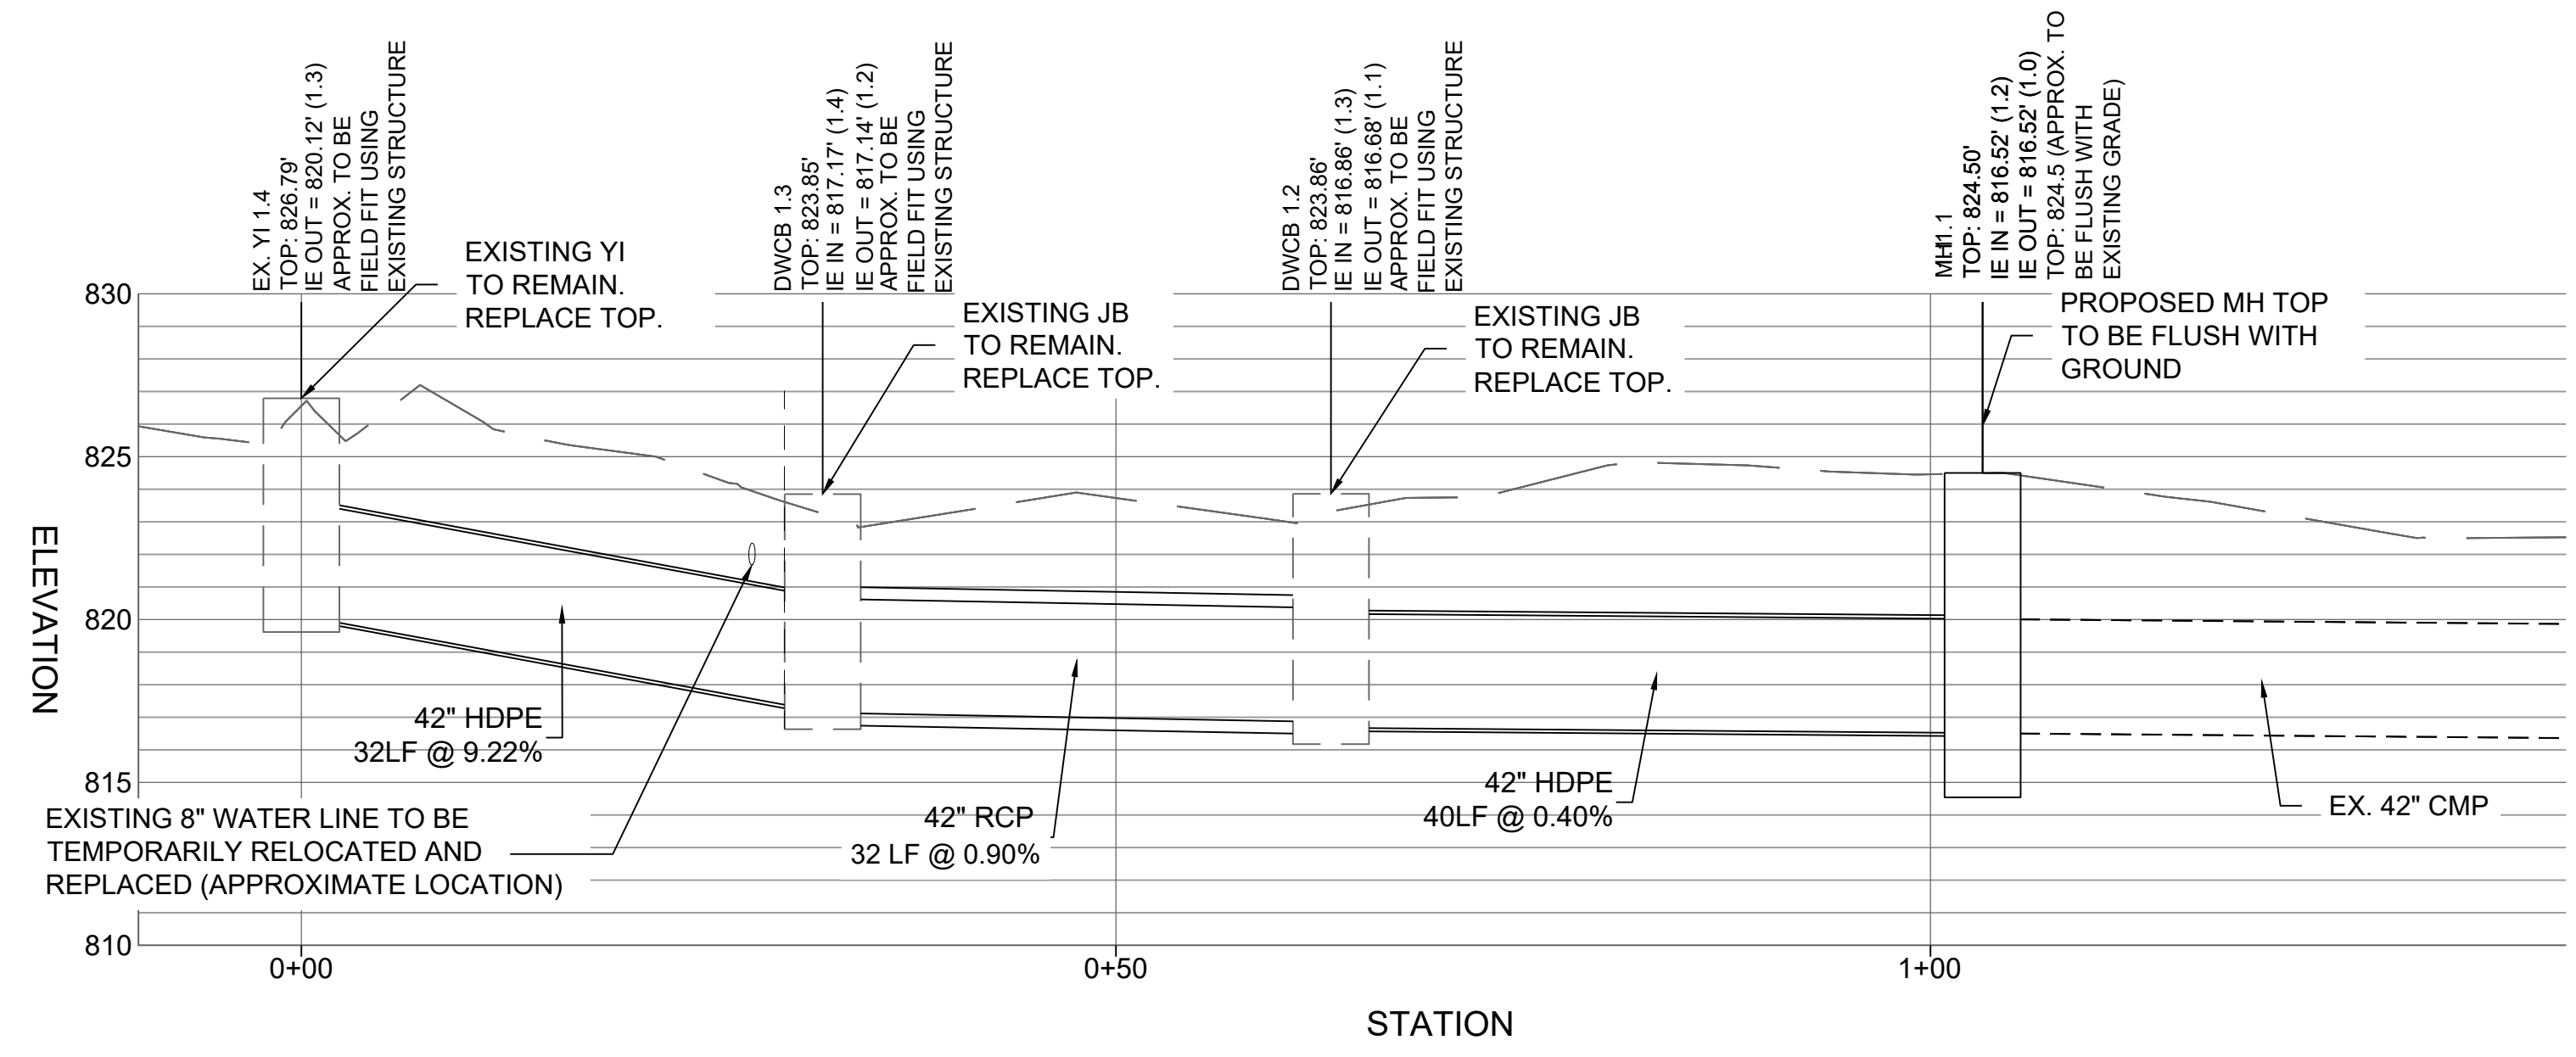ORIGINAL SHEET SIZE:  
22" X 34"



FILE PATH: X:\FY22\1220341\04\_CAD\_BIM\04\_02\_CAD\CG101\_PLOTTED BY: URUETA, JUAN DATE: 6/12/23



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CLIENT INFORMATION

FAYETTE COUNTY

140 STONEWALL AVE W, STE 203  
FAYETTEVILLE, GA. 30214

PROJECT NAME

OLD IVY ROAD  
STORM DRAIN  
REPLACEMENT

FAYETTE COUNTY, GA

DRAWING ISSUE

JANUARY 25, 2024  
DATE

100% DESIGN PLANS

DESCRIPTION

MARK

DESIGNED BY: MDW

DRAWN BY: MDW

CHECKED BY: DMM/MDM

SUBMITTED BY: DMM

DATE: JANUARY 25, 2024

PROJECT # 1220341

SHEET TITLE

EASEMENT  
EXHIBIT

SHEET NUMBER


CG301

SHEET ---- OF 17


ORIGINAL SHEET SIZE:  
22" X 34"

SHEET LEGEND

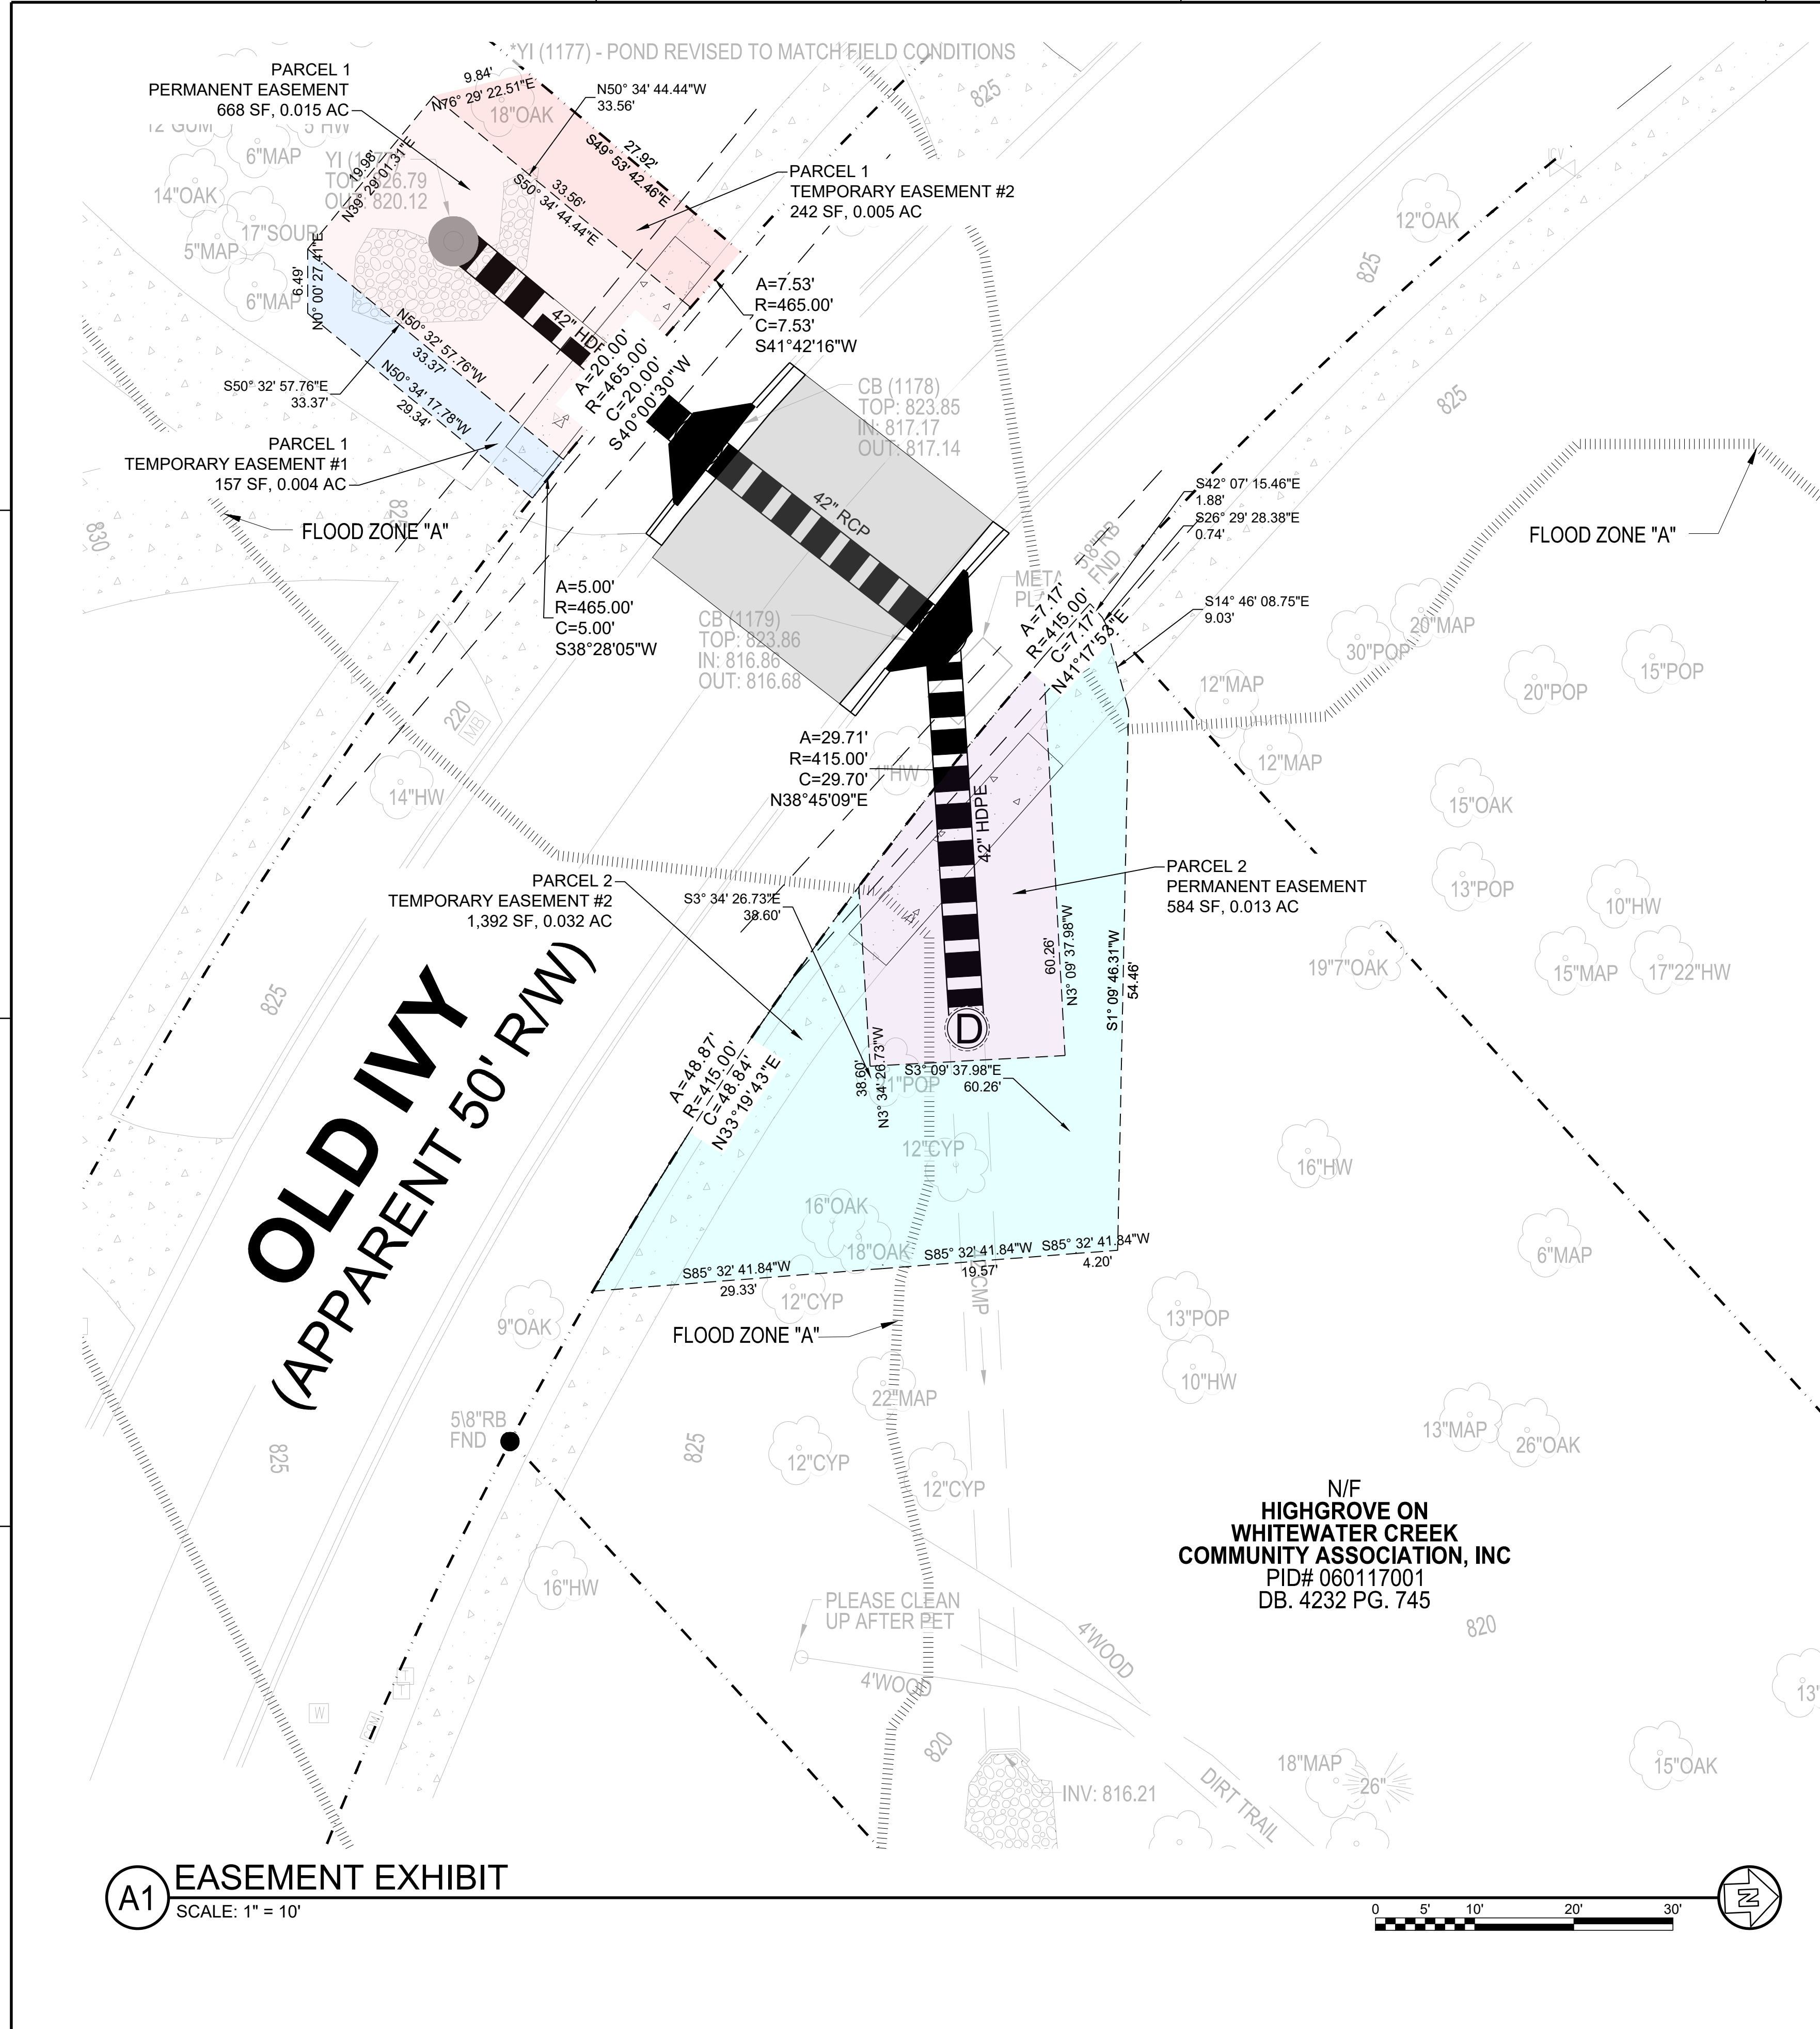- FULL DEPTH ASPHALT PAVING (FOUNDATION TYPE REFER TO FAYETTE COUNTY TYPICAL)
- PROPOSED SIDEWALK REPLACEMENT
- APPROXIMATE RIGHT OF WAY PROPERTY LINE
- PARCEL 1 PERMANENT EASEMENT
- PARCEL 1 TEMPORARY EASEMENT # 1
- PARCEL 1 TEMPORARY EASEMENT # 2
- PARCEL 2 PERMANENT EASEMENT
- PARCEL 2 TEMPORARY EASEMENT



A1 EASEMENT EXHIBIT  
SCALE: 1" = 10'

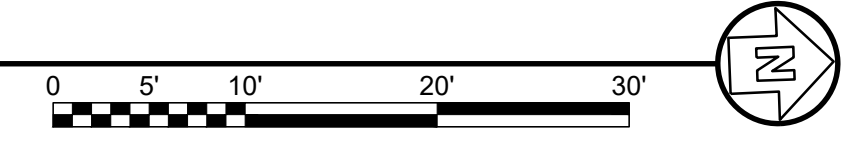

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NON-EXEMPT ACTIVITIES SHALL NOT BE CONDUCTED WITHIN THE 25- OR 50-FOOT UNDISTURBED STREAM BUFFERS AS MEASURED FROM THE POINT OF WRESTED VEGETATION WITHOUT FIRST ACQUIRING THE NECESSARY VARIANCES AND PERMITS..

AMENDMENTS/REVISIONS TO THE ES&PC PLAN WHICH HAVE A SIGNIFICANT EFFECT ON BMPS WITH A HYDRAULIC COMPONENT MUST BE CERTIFIED BY THE DESIGN PROFESSIONAL.

WASTE MATERIALS SHALL NOT BE DISCHARGED TO WATERS OF THE STATE, EXCEPT AS AUTHORIZED BY A SECTION 404 PERMIT.

THE ESCAPE OF SEDIMENT FROM THE SITE SHALL BE PREVENTED BY THE INSTALLATION OF EROSION AND SEDIMENT CONTROL MEASURES AND PRACTICES PRIOR TO, OR CONCURRENT WITH, LAND DISTURBING ACTIVITIES.

EROSION CONTROL MEASURES WILL BE MAINTAINED AT ALL TIMES. IF FULL IMPLEMENTATION OF THE APPROVED PLAN DOES NOT PROVIDE FOR EFFECTIVE EROSION CONTROL, ADDITIONAL EROSION AND SEDIMENT CONTROL MEASURES SHALL BE IMPLEMENTED TO CONTROL OR TREAT THE SEDIMENT SOURCE.

ANY DISTURBED AREA LEFT EXPOSED FOR A PERIOD GREATER THAN 14 DAYS SHALL BE STABILIZED WITH MULCH OR TEMPORARY SEEDING.

ALL BUFFERS AND TREE SAVE AREAS SHALL BE CLEARLY IDENTIFIED WITH FLAGGING AND/OR FENCING PRIOR TO COMMENCEMENT OF ANY LAND DISTURBANCE.

SEDIMENT STORAGE MAINTENANCE INDICATORS MUST BE INSTALLED IN SEDIMENT STORAGE STRUCTURES, INDICATING THE 1/3 FULL VOLUME.

**DESIGN PROFESSIONAL CERTIFICATION:**

I CERTIFY UNDER PENALTY OF LAW THAT THIS PLAN WAS PREPARED AFTER A SITE VISIT TO THE LOCATIONS DESCRIBED HEREIN BY MYSELF OR MY AUTHORIZED AGENT, UNDER MY DIRECT SUPERVISION.

DAVID MORGAN, P.E. \_\_\_\_\_ DATE \_\_\_\_\_  
 GSWCC LEVEL II CERTIFICATION # 0000011643  
 EXPIRES: 06/03/2024

**EROSION, SEDIMENTATION, AND POLLUTION CONTROL PLAN GENERAL NOTES**  
 (IN CONFORMANCE WITH STATE OF GEORGIA GENERAL NPDES PERMIT NO. GAR 100001.)

OWNER/ PRIMARY PERMITEE: FAYETTE COUNTY ENVIRONMENTAL MANAGEMENT  
 PHIL MALLON  
 140 STONEWALL AVE. W., SUITE 203, FAYETTEVILLE, GA. 30214  
 PHONE (770) 305-5410  
 PUBLICWORKS@FAYETTECOUNTYGA.GOV

ENGINEER: POND & COMPANY  
 3500 PARKWAY LANE, SUITE 500  
 PEACHTREE CORNERS, GEORGIA 30092  
 PHONE: (678) 336-7740  
 FAX: (678) 336-7744

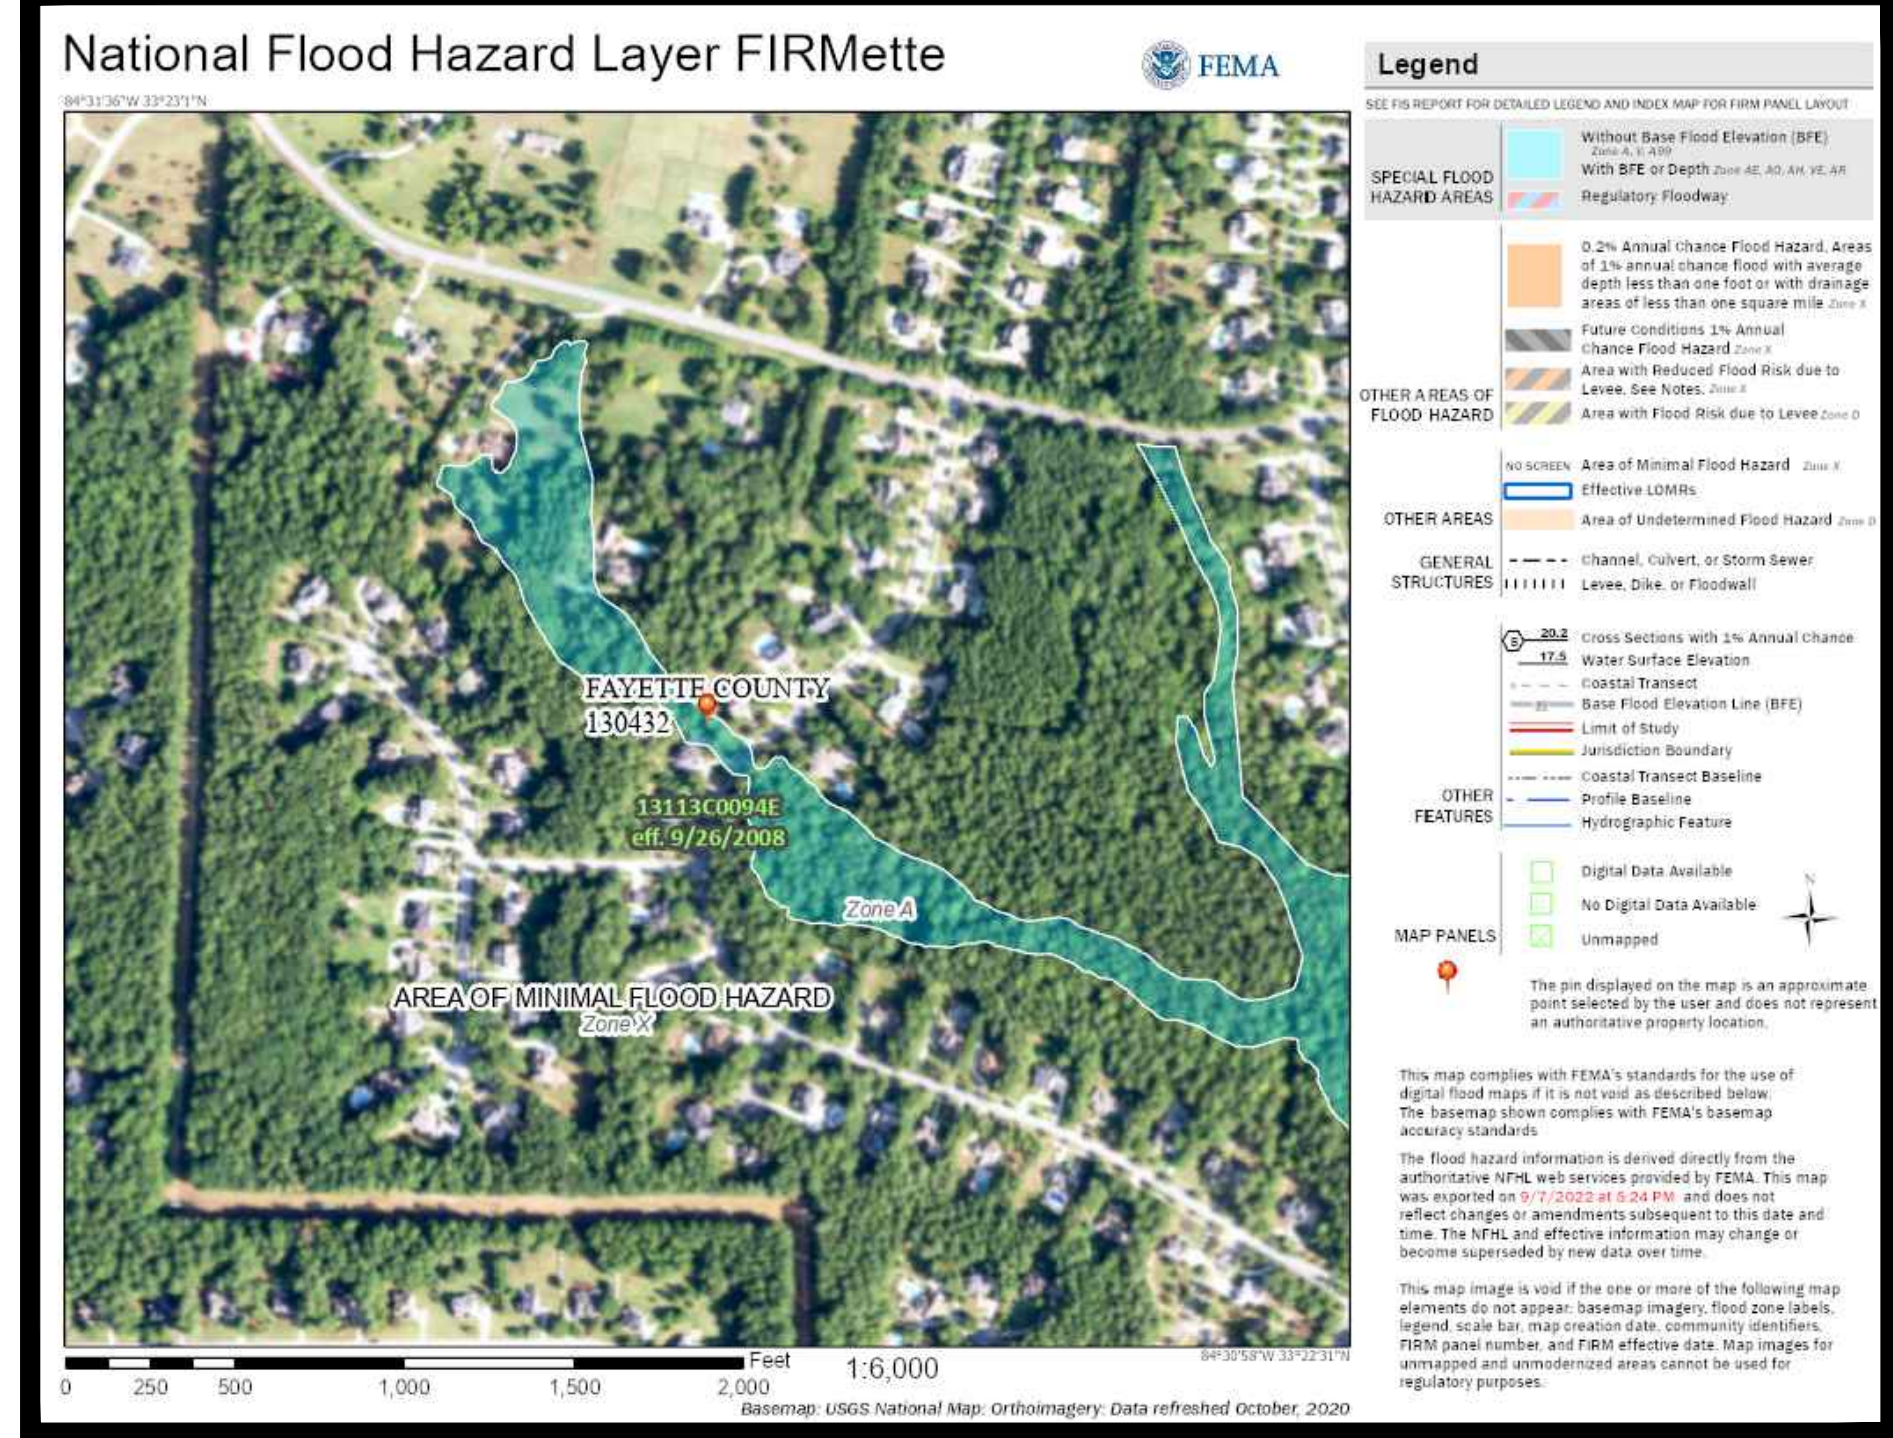
CONTACT: DAVID MORGAN, PE  
 GA. P.E. # 27428 , E&S LEVEL II CERTIFICATION # 0000011643

CONTRACTOR: TO BE DETERMINED  
 24-HOUR EROSION AND SEDIMENT CONTROL CONTACT: PHIL MALLON -770-313-9855

TOTAL SITE AREA: 0.08 ACRES  
 DISTURBED AREA: 0.08 ACRES  
 EXISTING LAND USE: RESIDENTIAL WOODED AREA THAT HAS AN EXISTING 42-INCH DIAMETER CMP STORM DRAIN AND DRAIN INLETS, WHICH ALLOW STORMWATER TO DRAIN UNDER A COUNTY ROAD.

PROPOSED LAND USE: THE PROJECT CONSIST OF REMOVING AN EXISTING DETERIORATED 42-INCH DIAMETER CMP STORM DRAIN AND REPLACING IT WITH A 42-INCH RCP PIPE. IN THE PROCESS, REPLACING TWO STORM DRAINS IN KIND. FINALLY, ESTABLISHING PERMANENT DRAINAGE EASEMENTS FOR THE DRAINAGE SYSTEM.

GPS COORDINATES OF SITE: 33.379153 N, 84.521153 W  
 NAME OF RECEIVING WATERS: UNKNOWN TRIBUTARY TO WHITEWATER CREEK (IMPAIRED)  
 AREA OF ON-SITE WETLANDS: 0 AC




FEMA FLOOD MAP - 13113C0094E  
 SCALE: NTS DATED 09/26/2008

THERE ARE KNOWN WETLANDS LOCATED WITHIN 200 FEET OF PROJECT AREA.  
 STATE WATERS DO EXIST WITHIN 200 FEET OF PROJECT AREA.

**EROSION CONTROL LEGEND**

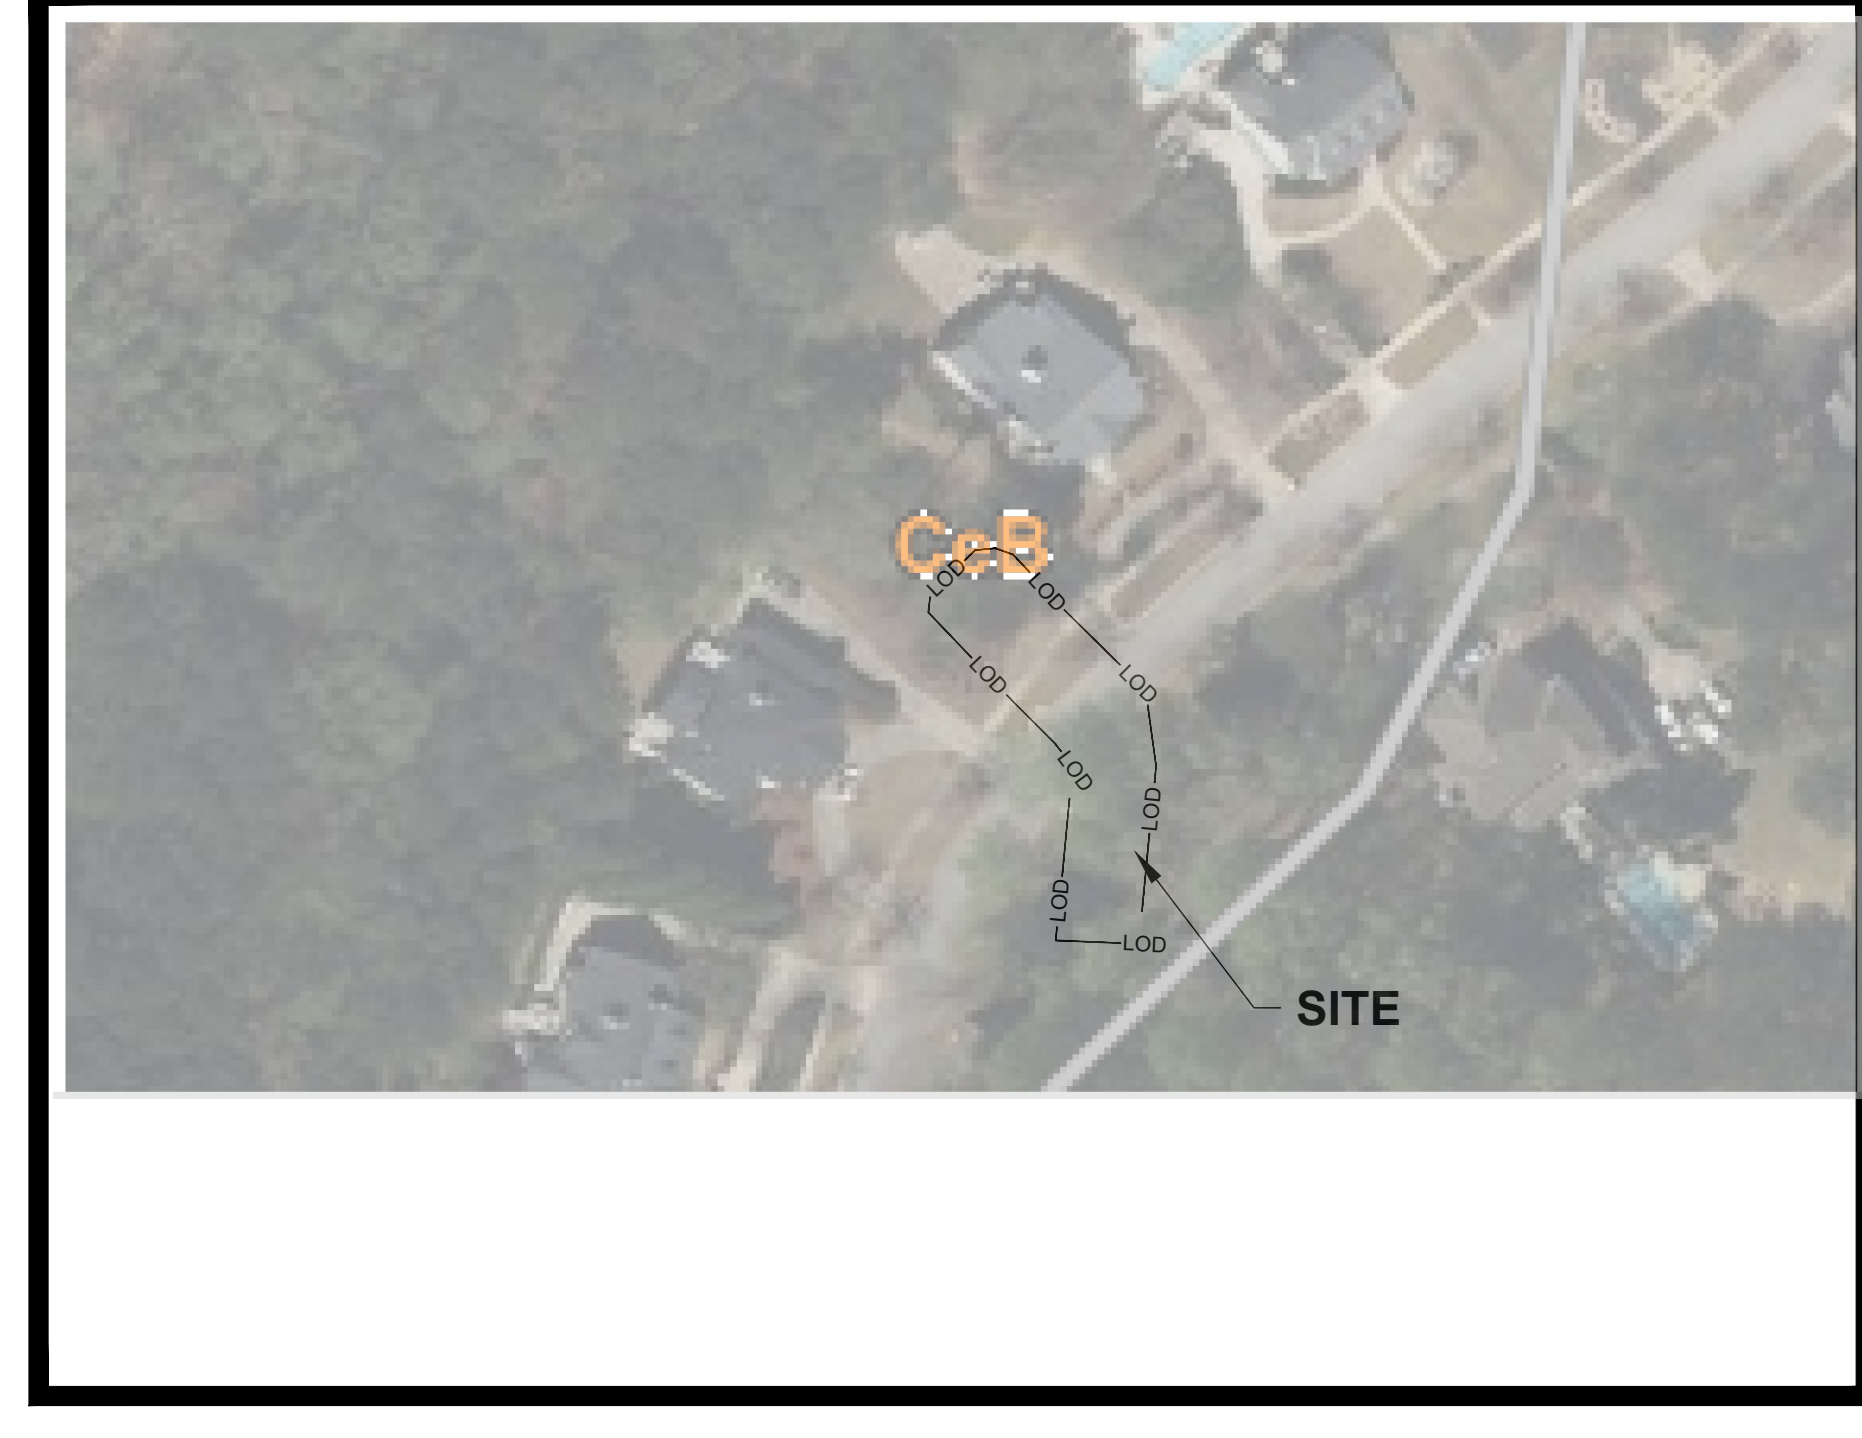- Ds1** TEMPORARY MULCHING - DETAIL A2/CE-501
- Ds2** TEMPORARY SEEDING - DETAIL A1/CE-502
- Ds3** DISTURBED AREA PERMANENT SEEDING- DETAIL B3/CE-502
- Ds4** DISTURBED AREA STABILIZATION W/ SEEDING - DETAIL B3/CE-503
- Sd1-S double** SILT FENCING DETAIL C1/CE-501
- Sd2-P** CURB INLET FILTER - DETAIL B4/CE-503
- Du** DUST CONTROL - DETAIL A1/CE-501
- Tr** TREE PROTECTION DETAIL C1/CE-503



SOIL MAP

SYMBOL	DESCRIPTION
CeB	CECIL SANDY LOAM, 2 TO 6 PERCENT SLOPES

ACTIVITY	TIME / 16 WEEKS															
	1	2	3	4	5	6	7	8	9	10	11	12	13	14	15	16
INSTALL SILT FENCE, CONSTRUCTION EXIT	█															
CLEARING AND GRUBBING	█	█														
INSTALL REMAINDER OF INITIAL PERIMETER CONTROLS INCLUDING SEDIMENT BASINS, CHECK DAMS, ROCK DAMS, DIVERSION BERMS, ROCK FILTER, DOWN DRAINS, INLET SEDIMENT TRAPS, AND FILTER RINGS.			█													
DEMOLITION OF SURFACE PAVEMENT, OR ANY OTHER MISCELLANEOUS REQUIRED BMP, FENCES, EXISTING CULVERTS AND UTILITY POLES			█													
UTILITY RELOCATION				█	█	█	█									
ROUGH GRADING OPERATIONS							█	█	█							
INSTALLATION OF PROPOSED CULVERTS									█	█	█					
FINAL PAVING AND GRADING												█	█	█		
PERMANENT SEEDING															█	█
REMOVAL OF TEMPORARY EROSION AND SEDIMENT CONTROL MEASURES																█
MAINTENANCE OF TEMPORARY EROSION AND SEDIMENT CONTROL MEASURES	█	█	█	█	█	█	█	█	█	█	█	█	█	█	█	█

DESIGN PROFESSIONAL:  
 DAVID MORGAN, P.E.  
 LEVEL II CERTIFICATION  
 No.: 0000011643  
 EXPIRES : 06/03/2024

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 CLIENT INFORMATION

**FAYETTE COUNTY**  
 140 STONEWALL AVE W, STE 203  
 FAYETTEVILLE, GA. 30214

PROJECT NAME  
**OLD IVY ROAD  
 STORM DRAIN  
 REPLACEMENT**

FAYETTE COUNTY, GA

DRAWING ISSUE  
 JUNE 8, 2023  
 DATE

100% DESIGN PLANS  
 DESCRIPTION

MARK

DESIGNED BY: MDW  
 DRAWN BY: MDW  
 CHECKED BY: DMM/MDM  
 SUBMITTED BY: DMM  
 DATE: JUNE 8, 2023  
 PROJECT # 1220341

SHEET TITLE

**EROSION &  
 SEDIMENT  
 CONTROL  
 NOTES**

SHEET NUMBER

**CE001**

SHEET 9 OF 17

ORIGINAL SHEET SIZE:  
 22" X 34"

**STRUCTURAL PRACTICES:**

THE STRUCTURAL PRACTICES SHOWN ON THIS PLAN HAVE BEEN DESIGNED TO REDUCE EROSION & SEDIMENTATION OF DISTURBED AREAS.

SILT FENCE (SD1-TYPE "S"), TEMPORARY SEDIMENT BASINS, AND DIVERSION DITCHES WILL BE INSTALLED PRIOR TO CLEARING AND GRADING OPERATIONS TO KEEP SEDIMENT CONTAINED WITHIN THE SITE AS NECESSARY. DISTURBED AREA STABILIZATION SHALL BE STABILIZED WITH MULCH (Ds1), TEMPORARY SEEDING (Ds2), AND PERMANENT SEEDING (Ds3) AS NECESSARY. INLET SEDIMENT TRAP PROTECTION WILL BE USED TO HELP PREVENT SEDIMENT FROM ENTERING ANY EXISTING INLETS. SEDIMENT STORAGE OF 67 CY PER DISTURBED ACRE IS PROVIDED BY TEMPORARY SEDIMENT BASINS.

**D CRITICAL WORK ZONE:**

ALL SLOPES 3:1 OR STEEPER AND HIGHER THAN 5 FEET, AND ALL SLOPES ADJACENT TO BUFFERS SHALL RECEIVE SURFACE ROUGHENING, AND EROSION CONTROL MATTING. SILT FENCING WILL BE USED TO PREVENT SEDIMENT FROM LEAVING THE DISTURBED AREA. INLET PROTECTION WILL BE USED TO PREVENT SEDIMENT FROM ENTERING THE STORM SEWER.

**CONSTRUCTION PERIOD STORM WATER POLLUTANT CONTROL:**

SEDIMENTATION AND FUEL SPILLS ARE POTENTIAL SOURCES OF STORM WATER POLLUTION DURING THE CONSTRUCTION PROCESS. THESE POLLUTANTS WILL BE REMOVED AND/OR REDUCED VIA THE BMP'S CONTAINED WITHIN THIS PLAN

**STABILIZATION MEASURES:**

THE STABILIZATION MEASURES SHOWN ON THESE PLANS HAVE BEEN DESIGNED TO STABILIZE THE DISTURBED AREAS FOLLOWING THE TEMPORARY OR PERMANENT COMPLETION OF CONSTRUCTION. ALL EXPOSED AREAS SHALL BE STABILIZED WITH TEMPORARY MULCHING (DS1) IMMEDIATELY AFTER TRENCHING IF THEY ARE TO REMAIN INACTIVE FOR 14 DAYS OR MORE. ALL DISTURBED AREAS SHALL BE STABILIZED WITH TEMPORARY (DS2) OR PERMANENT (DS3) VEGETATION AS INDICATED ON THE PLAN. SLOPES GREATER 3:1 ARE TO BE STABILIZED WITH EROSION CONTROL MATTING (MB). DUST CONTROL (DU) SHALL ALSO BE PROVIDED AS NEEDED DURING GRADING ACTIVITIES. SEE EROSION, SEDIMENTATION, AND POLLUTION CONTROL (ESPCP) DETAIL SHEETS FOR MORE DETAILS REGARDING THESE STABILIZATION MEASURES.

**C STABILIZATION MEASURES SHALL BE INITIATED AS SOON AS PRACTICABLE IN PORTIONS OF THE SITE WHERE CONSTRUCTION ACTIVITIES HAVE TEMPORARILY OR PERMANENTLY CEASED, BUT IN NO CASE MORE THAN 14 DAYS AFTER THE CONSTRUCTION ACTIVITY IN THAT PORTION OF THE SITE HAS TEMPORARILY OR PERMANENTLY CEASED, EXCEPT:**

WHERE THE INITIATION OF STABILIZATION MEASURES BY THE 14TH DAY AFTER CONSTRUCTION ACTIVITY TEMPORARILY OR PERMANENTLY CEASED IS PRECLUDED BY SNOW COVER OR OTHER ADVERSE WEATHER CONDITIONS, STABILIZATION MEASURES SHALL BE INITIATED AS SOON AS PRACTICAL.

WHERE CONSTRUCTION ACTIVITY WILL RESUME ON A PORTION OF THE SITE WITHIN 21 DAYS FROM WHEN ACTIVITIES CEASED (E.G. THE TOTAL TIME PERIOD THAT CONSTRUCTION ACTIVITY IS TEMPORARILY CEASED IS LESS THAN 21 DAYS) THEN STABILIZATION MEASURES DO NOT HAVE TO BE INITIATED ON THAT PORTION OF THE SITE BY THE 14TH DAY AFTER CONSTRUCTION ACTIVITY TEMPORARILY CEASED.

**KEEPING PLANS CURRENT:**

THE PRIMARY, SECONDARY OR TERTIARY PERMITTEES, AS APPLICABLE, SHALL AMEND THEIR PLAN WHENEVER THERE IS A CHANGE IN DESIGN, CONSTRUCTION, OPERATION, OR MAINTENANCE, WHICH HAS A SIGNIFICANT EFFECT ON BMPS WITH A HYDRAULIC COMPONENT (I.E., THOSE BMPS WHERE THE DESIGN IS BASED UPON RAINFALL INTENSITY, DURATION AND RETURN FREQUENCY STORMS) OR IF THE PLAN PROVES TO BE INEFFECTIVE IN ELIMINATING OR SIGNIFICANTLY MINIMIZING POLLUTANTS FROM SOURCES IDENTIFIED UNDER PART IV.D.3. OF THIS PERMIT. AMENDMENTS TO THE PLAN MUST BE CERTIFIED BY A DESIGN PROFESSIONAL AS PROVIDED IN THIS PERMIT. SECONDARY PERMITTEES MUST NOTIFY THE PRIMARY PERMITTEE WITHIN 24-HOURS OF BECOMING AWARE OF ANY SUSPECTED BMP DESIGNED DEFICIENCIES WHICH ARE NOT EFFECTIVE IN CONTROLLING THE DISCHARGE OF POLLUTANTS FROM THE SECONDARY PERMITTEE'S SITE. THE PRIMARY PERMITTEE MUST EVALUATE WHETHER THESE DEFICIENCIES EXIST WITHIN 48-HOURS OF SUCH NOTICE, AND IF THESE DEFICIENCIES ARE FOUND TO EXIST MUST AMEND THE PLAN IN ACCORDANCE WITH THIS PARAGRAPH TO ADDRESS THOSE DEFICIENT BMPS WITHIN SEVEN (7) DAYS OF BEING NOTIFIED BY THE SECONDARY PERMITTEE.

**B WHEN THE PLAN IS AMENDED, THE PRIMARY PERMITTEE MUST NOTIFY AND PROVIDE A COPY OF THE AMENDMENT TO ALL AFFECTED SECONDARY PERMITTEES WITHIN THIS SEVEN (7) DAY PERIOD. THE SECONDARY PERMITTEE(S) MUST IMPLEMENT ANY NEW PLAN REQUIREMENTS AFFECTING THEIR SITE(S) WITHIN 48-HOURS OF NOTIFICATION BY THE PRIMARY PERMITTEE. NOTWITHSTANDING THE FOREGOING, THE PRIMARY OR TERTIARY PERMITTEE REMAINS RESPONSIBLE FOR INSURING THAT THE PLAN, AS APPROPRIATE, MEETS THE REQUIREMENTS OF THIS PERMIT.**

**PROPER OPERATION AND MAINTENANCE:**

THE PERMITTEE SHALL AT ALL TIMES PROPERLY OPERATE AND MAINTAIN ALL FACILITIES AND SYSTEMS OF TREATMENT AND CONTROL (AND RELATED APPURTENANCES) WHICH ARE INSTALLED OR USED BY THE PERMITTEE TO ACHIEVE COMPLIANCE WITH THE CONDITIONS OF THIS PERMIT AND WITH THE REQUIRED PLANS. PROPER OPERATION AND MAINTENANCE ALSO INCLUDES ADEQUATE LABORATORY CONTROLS AND APPROPRIATE QUALITY ASSURANCE PROCEDURES. PROPER OPERATION AND MAINTENANCE REQUIRES THE OPERATION OF BACKUP OR AUXILIARY FACILITIES OR SIMILAR SYSTEMS, INSTALLED BY AN PERMITTEE ONLY WHEN NECESSARY TO ACHIEVE COMPLIANCE WITH THE CONDITIONS OF THE PERMIT.

EROSION AND SEDIMENT CONTROL MEASURES WILL BE MAINTAINED AT ALL TIMES. IF FULL IMPLEMENTATION OF THE APPROVED PLAN DOES NOT PROVIDE FOR EFFECTIVE EROSION AND SEDIMENT CONTROL, ADDITIONAL EROSION AND SEDIMENT CONTROL MEASURES SHALL BE IMPLEMENTED TO CONTROL OR TREAT THE SEDIMENT SOURCE.

REFER TO THE DETAILS CONTAINED WITHIN THIS PLAN SET FOR ADDITIONAL MAINTENANCE INSTRUCTION.

**NON-STORM WATER DISCHARGES:**

**A NON-STORM WATER DISCHARGES (DISCHARGES FROM FIRE FIGHTING ACTIVITIES, FIRE HYDRANT FLUSHING, POTABLE WATER SOURCES INCLUDING WATER LINE FLUSHING, IRRIGATION DRAINAGE, AIR CONDITIONING CONDENSATE, SPRINGS, UNCONTAMINATED GROUNDWATER, AND FOUNDATION OR FOOTING DRAINS WHERE FLOWS ARE NOT CONTAMINATED WITH PROCESS MATERIALS OR POLLUTANTS) THAT ARE COMBINED WITH STORM WATER DISCHARGES ASSOCIATED WITH CONSTRUCTION ACTIVITY SHALL BE DISCHARGED TO THE PROPOSED STORM DRAINAGE SYSTEM AND ROUTED THROUGH THE EROSION AND SEDIMENTATION CONTROLS IDENTIFIED WITHIN THIS PLAN. NOTIFY THE LICENSED PROFESSIONAL WHO PREPARED THIS PLAN IF THIS IS NOT POSSIBLE.**

**WASTE MATERIALS AND DISPOSAL:**

ALL WASTE MATERIALS SHALL BE COLLECTED AND STORED IN A SECURELY LIDDED METAL DUMPSTER OR OTHER APPROPRIATE WASTE MANAGEMENT FACILITY PERMISSIBLE UNDER GAR PERMIT NO. 100001. WASTE MANAGEMENT FACILITIES SHALL MEET ALL SOLID WASTE MANAGEMENT REGULATIONS. ALL TRASH AND CONSTRUCTION DEBRIS FROM THE SITE SHALL BE DEPOSITED IN THE WASTE MANAGEMENT FACILITIES. WASTE MANAGEMENT FACILITIES SHALL BE EMPTIED A MINIMUM OF ONCE PER WEEK OR MORE OFTEN IF NECESSARY AND TRASH SHALL BE HAULED AS REQUIRED BY LOCAL REGULATIONS. NO CONSTRUCTION WASTE SHALL BE BURIED ON-SITE.

ALL PERSONNEL SHALL BE INSTRUCTED ON PROPER PROCEDURES FOR WASTE DISPOSAL. A NOTICE STATING THESE PRACTICES SHALL BE POSTED AT THE JOB SITE AND THE CONTRACTOR SHALL BE RESPONSIBLE FOR SEEING THAT THESE PROCEDURES ARE FOLLOWED.

LOCATE WASTE COLLECTION AREAS AWAY FROM STREETS, GUTTERS, WATERCOURSES AND STORM DRAINS. WASTE COLLECTION AREAS, SUCH AS DUMPSTERS, ARE OFTEN BEST LOCATED NEAR CONSTRUCTION SITE ENTRANCES TO MINIMIZE TRAFFIC ON DISTURBED SOILS.

**HAZARDOUS WASTES:**

ALL HAZARDOUS WASTE MATERIALS SHALL BE DISPOSED OF IN THE MANNER AS REQUIRED BY LOCAL, STATE, AND/OR FEDERAL REGULATIONS AND BY THE MANUFACTURER OF SUCH PRODUCTS. THE JOB SITE SUPERINTENDENT, WHO WILL ALSO BE RESPONSIBLE FOR SEEING THAT THESE PRACTICES ARE FOLLOWED, SHALL INSTRUCT SITE PERSONNEL IN THESE PRACTICES. MATERIAL SAFETY DATA SHEETS (MSDS'S) FOR EACH SUBSTANCE WITH HAZARDOUS PROPERTIES THAT IS USED ON THE JOB SITE SHALL BE OBTAINED AND USED FOR THE PROPER MANAGEMENT OF POTENTIAL WASTES THAT MAY RESULT FROM THESE PRODUCTS. AN MSDS SHALL BE POSTED IN THE IMMEDIATE AREA WHERE SUCH PRODUCT IS STORED AND/OR USED AND ANOTHER COPY OF EACH MSDS SHALL BE MAINTAINED IN THE EROSION SEDIMENTATION AND POLLUTION CONTROL PLAN (ESPCP) FILE AT THE JOB SITE CONSTRUCTION TRAILER OFFICE. EACH EMPLOYEE WHO HANDLES A SUBSTANCE WITH HAZARDOUS PROPERTIES WILL BE INSTRUCTED ON THE USE OF MSDS SHEETS AND THE SPECIFIC INFORMATION IN THE APPLICABLE MSDS FOR THE PRODUCT HE/SHE IS USING, PARTICULARLY REGARDING SPILL CONTROL TECHNIQUES.

THE CONTRACTOR WILL IMPLEMENT THE SPILL PREVENTION CONTROL AND COUNTERMEASURES (SPCC) PLAN FOUND WITHIN THIS ESPCP AND WILL TRAIN ALL PERSONNEL IN THE PROPER CLEANUP AND HANDLING OF SPILLED MATERIALS. NO SPILLED HAZARDOUS MATERIALS OR HAZARDOUS WASTES SHALL BE ALLOWED TO COME IN CONTACT WITH STORM WATER DISCHARGES. IF SUCH CONTACT OCCURS, THE STORM WATER DISCHARGE SHALL BE CONTAINED ON SITE UNTIL APPROPRIATE MEASURES IN COMPLIANCE WITH STATE AND FEDERAL REGULATIONS ARE TAKEN TO DISPOSE OF SUCH CONTAMINATED STORM WATER. IT SHALL BE THE RESPONSIBILITY OF THE JOB SITE SUPERINTENDENT TO PROPERLY TRAIN ALL PERSONNEL IN THE USE OF THE SPCC PLAN.

NOTHING IN THIS PERMIT SHALL BE CONSTRUED TO PRECLUDE THE INSTITUTION OF ANY LEGAL ACTION OR RELIEVE THE PERMITTEE FROM ANY RESPONSIBILITIES, LIABILITIES, OR PENALTIES TO WHICH THE PERMITTEE IS OR MAY BE SUBJECT UNDER THE GEORGIA HAZARDOUS WASTE MANAGEMENT ACT, O.C.G.A. § 12-8-60, ET SEQ. OR UNDER CHAPTER 14 OF TITLE 12 OF THE OFFICIAL CODE OF GEORGIA ANNOTATED; NOR IS THE OPERATOR RELIEVED FROM ANY RESPONSIBILITIES, LIABILITIES OR PENALTIES TO WHICH THE PERMITTEE IS OR MAY BE SUBJECT UNDER SECTION 311 OF THE CLEAN WATER ACT OR SECTION 106 OF COMPREHENSIVE ENVIRONMENTAL RESPONSE COMPENSATION AND LIABILITY ACT.

**SANITARY WASTES:**

ALL PERMITTEES SHALL ENSURE THAT THIS PLAN IS IN COMPLIANCE WITH APPLICABLE STATE AND/OR LOCAL WASTE DISPOSAL, SANITARY SEWER, OR SEPTIC SYSTEM REGULATIONS.

A MINIMUM OF ONE PORTABLE SANITARY UNIT SHALL BE PROVIDED FOR EVERY TEN (10) WORKERS ON THE SITE. ALL SANITARY WASTE SHALL BE COLLECTED FROM THE PORTABLE UNITS A MINIMUM OF ONE TIME PER WEEK BY A LICENSED PORTABLE FACILITY PROVIDER IN COMPLETE COMPLIANCE WITH THE LOCAL STATE REGULATIONS.

ALL SANITARY WASTE UNITS SHALL BE LOCATED IN AN AREA WHERE THE LIKELIHOOD OF THE UNIT CONTRIBUTING TO STORM WATER DISCHARGE IS NEGLIGIBLE. ADDITIONAL CONTAINMENT OF BMP'S SHALL BE IMPLEMENTED AS NECESSARY, SUCH AS GRAVEL BAGS OR SPECIFICALLY DESIGNED PLASTIC SKID CONTAINERS AROUND THE BASE, TO PREVENT WASTE FROM CONTRIBUTING TO STORM WATER DISCHARGES. THE LOCATION OF SANITARY WASTE UNITS MUST BE IDENTIFIED ON THE EROSION CONTROL PLAN GRADING PHASE BY THE CONTRACTOR ONCE THE LOCATIONS HAVE BEEN DETERMINED.

**OFFSITE VEHICLE TRACKING / DUST CONTROL:**

OFF-SITE VEHICLE TRACKING OF DIRT, SOILS, AND SEDIMENTS AND THE GENERATION OF DUST SHALL BE MINIMIZED OR ELIMINATED TO THE MAXIMUM EXTENT PRACTICAL. A STABILIZED CONSTRUCTION EXIT (CO) SHALL BE PROVIDED TO REDUCE VEHICLE TRACKING OF SEDIMENT. SEE ESPCP PLAN AND DETAIL SHEETS FOR THE CONSTRUCTION EXIT LOCATIONS AND DETAIL. THE PAVED STREET ADJACENT TO THE CONSTRUCTION EXIT SHALL BE INSPECTED DAILY BY A REPRESENTATIVE OF THE SITE CONTRACTOR FOR TRACKING OF MUD, DIRT, OR ROCK. DUMP TRUCKS HAULING MATERIAL FROM THE CONSTRUCTION SITE SHALL BE COVERED WITH A TARPAULIN. DUST CONTROL (DU) SHALL BE APPLIED AS NECESSARY TO PREVENT SURFACE AND AIR MOVEMENT OF DUST.

**INVENTORY FOR POLLUTION PREVENTION PLAN**

THE FOLLOWING MATERIALS ARE EXPECTED TO BE ONSITE DURING CONSTRUCTION: CONCRETE PRODUCTS, ASPHALT, PETROLEUM BASED FUELS AND LUBRICANTS FOR EQUIPMENT, TAR, METAL BUILDING MATERIALS, LUMBER, SHEET ROCK, FLOOR COVERINGS, ELECTRICAL WIRE AND FIXTURES, PAINTS/STAINS/FINISHING TREATMENTS, PAINT SOLVENTS, ADDITIVES FOR SOIL STABILIZATION, CLEANING SOLVENTS, PESTICIDES, FERTILIZERS, HERBICIDES, CRUSHED STONE, PLASTIC AND METAL PIPES.

**SPILL PREVENTION**

PRACTICES SUCH AS GOOD HOUSEKEEPING, PROPER HANDLING OF HAZARDOUS PRODUCTS AND PROPER SPILL CONTROL PRACTICES WILL BE FOLLOWED TO REDUCE THE RISK OF SPILLS AND SPILLS FROM DISCHARGING INTO STORM WATER RUNOFF.

**GOOD HOUSEKEEPING**

QUANTITIES OF PRODUCTS STORED ONSITE WILL BE LIMITED TO THE AMOUNT NEEDED FOR THE JOB.

- A. PRODUCTS AND MATERIALS WILL BE STORED IN A NEAT, ORDERLY MANNER IN APPROPRIATE CONTAINERS PROTECTED FROM RAINFALL, WHERE POSSIBLE.
- B. PRODUCTS WILL BE KEPT IN THEIR ORIGINAL CONTAINERS WITH MANUFACTURER LABELS LEGIBLE AND VISIBLE.
- C. PRODUCT MIXING, PRODUCT DISPOSAL, AND DISPOSAL OF PRODUCT CONTAINERS WILL BE ACCORDING TO THE MANUFACTURER'S RECOMMENDATIONS.
- D. THE CONTRACTOR WILL INSPECT SUCH MATERIALS TO ENSURE PROPER USE, STORAGE AND DISPOSAL.

**EROSION, SEDIMENTATION, AND POLLUTION CONTROL PLAN GENERAL NOTES**

(IN CONFORMANCE WITH STATE OF GEORGIA GENERAL NPDES PERMIT NO. GAR 1000001)

**PRODUCT SPECIFIC PRACTICES**

PETROLEUM BASED PRODUCTS - CONTAINERS FOR PRODUCTS SUCH AS FUELS, LUBRICANTS AND TARS WILL BE INSPECTED DAILY FOR LEAKS AND SPILLS. THIS INCLUDES ON-SITE VEHICLE AND MACHINERY DAILY INSPECTIONS AND REGULAR PREVENTATIVE MAINTENANCE OF SUCH EQUIPMENT. EQUIPMENT MAINTENANCE AREAS WILL BE LOCATED AWAY FROM STATE WATER, NATURAL DRAINS AND STORM WATER DRAINAGE INLETS. IN ADDITION, TEMPORARY FUELING TANKS SHALL HAVE A SECONDARY CONTAINMENT LINER TO PREVENT/MINIMIZE SITE CONTAINMENT. DISCHARGE OF OILS, FUELS AND LUBRICANTS IS PROHIBITED. PROPER DISPOSAL METHODS WILL INCLUDE COLLECTION IN A SUITABLE CONTAINER AND DISPOSAL AS REQUIRED BY LOCAL AND STATE REGULATIONS.

PAINTS/FINISHES/SOLVENTS - ALL PRODUCTS WILL BE STORED IN TIGHTLY SEALED ORIGINAL CONTAINERS WHEN NOT IN USE. EXCESS PRODUCT WILL NOT BE DISCHARGED INTO THE STORM WATER COLLECTION SYSTEM. EXCESS PRODUCT, MATERIALS USED WITH THESE PRODUCTS, AND PRODUCT CONTAINERS WILL BE DISPOSED ACCORDING TO MANUFACTURER'S SPECIFICATIONS AND RECOMMENDATIONS.

CONCRETE/MASONRY - NO CONCRETE TRUCKS WILL BE ALLOWED TO WASH OUT OR DISCHARGE SURPLUS CONCRETE OR DRUM WASH WATER ON SITE. THE CONCRETE PROVIDER HAS RESPONSIBILITY TO ENSURE APPROPRIATE TRAINING HAS BEEN PROVIDED TO THEIR TRUCK DRIVERS, AND MUST PROVIDE APPROPRIATE DETAILS AND RESOURCES TO ENABLE THEM TO COMPLETE A DELIVERY WITHOUT CAUSING POLLUTION. CHUTES, BARRELS, WHEELBARROWS AND OTHER EQUIPMENT MUST BE RINSED IN THE SITE WASH-DOWN AREA. SWEEP OR SHOVEL ANY SPILLS THAT OCCUR AND ALLOW RESIDUE TO SET BEFORE REMOVING. THE HARDENED RESIDUE MAY THEN BE PLACED IN A DESIGNATED CONCRETE/MASONRY RECYCLING BIN ON SITE. DO NOT WASH CONCRETE/MASONRY INTO STORM DRAINS, OPEN DITCHES, STREETS, OR STREAMS. TRUCKS SHOULD NOT TRACK ANY CONCRETE OR MUD AND SEDIMENT OFF SITE.

FERTILIZER/HERBICIDES - THESE PRODUCTS WILL BE APPLIED AT RATES THAT DO NOT EXCEED THE MANUFACTURER'S SPECIFICATIONS, THE CROP ESTABLISHMENT GUIDELINES, OR THE SPECIFICATIONS CONTAINED WITHIN THE GSWCC MANUAL FOR EROSION AND SEDIMENT CONTROL IN GEORGIA.

**SPILL PREVENTION CONTROL AND COUNTERMEASURES (SPCC) PLAN:**

- A. LOCAL, STATE, AND MANUFACTURER'S RECOMMENDED METHODS FOR SPILL CLEANUP SHALL BE CLEARLY POSTED AND PROCEDURES SHALL BE MADE AVAILABLE TO SITE PERSONNEL.
- B. MATERIAL AND EQUIPMENT NECESSARY FOR SPILL CLEANUP SHALL BE KEPT IN THE MATERIAL STORAGE AREAS. TYPICAL MATERIALS AND EQUIPMENT INCLUDES, BUT IS NOT LIMITED TO, BROOMS, DUSTPANS, MOPS, RAGS, GLOVES, GOGGLES, CAT LITTER, SAND, SAWDUST, AND PROPERLY LABELED PLASTIC AND METAL WASTE CONTAINERS.
- C. SPILL PREVENTION PRACTICES AND PROCEDURES SHALL BE REVIEWED AFTER A SPILL AND ADJUSTED AS NECESSARY TO PREVENT FUTURE SPILLS.
- D. ALL SPILLS WILL BE CLEANED IMMEDIATELY UPON DISCOVERY. ALL SPILLS SHALL BE REPORTED AS REQUIRED BY LOCAL, STATE AND FEDERAL REGULATIONS.
- E. THE DISCHARGE OF HAZARDOUS SUBSTANCES OR OIL IN THE STORM WATER DISCHARGE(S) FROM A SITE SHALL BE PREVENTED.
- F. WHERE A RELEASE CONTAINING A HAZARDOUS SUBSTANCE IN AN AMOUNT EQUAL TO OR IN EXCESS OF A REPORTING QUANTITY ESTABLISHED UNDER EITHER GEORGIA'S OIL OR HAZARDOUS MATERIAL SPILLS OR RELEASES ACT (O.C.G.A. SEC. 12-14-2, ET SEQ.), 40 CFR 117, OR 40 CFR 302 OCCURS DURING A 24-HOUR PERIOD, THE PERMITTEE IS REQUIRED TO NOTIFY EPD AT (404) 656-4863 OR (800) 241-4113 AND THE NATIONAL RESPONSE CENTER (NRC) AT (800) 424-8802 IN ACCORDANCE WITH THE REQUIREMENTS OF GEORGIA'S OIL OR HAZARDOUS MATERIAL SPILLS OR RELEASES ACT (O.C.G.A. SEC. 12-14-2, ET SEQ.), 40 CFR 117, AND 40 CFR 302 AS SOON AS HE HAS KNOWLEDGE OF THE DISCHARGE.
- G. FOR SPILLS THAT IMPACT SURFACE WATER (LEAVE A SHEEN ON SURFACE WATER) OR SPILLS OF AN UNKNOWN AMOUNT, THE NATIONAL RESPONSE CENTER (NRC) SHALL BE CONTACTED WITHIN 24 HOURS AT (800) 424-8802.
- H. FOR SPILLS GREATER THAN 25 GALLONS AND NO SURFACE WATER IMPACTS, THE GEORGIA EPD SHALL BE CONTACTED WITHIN 24 HOURS AT (404) 656-4863 OR (800) 241-4113.
- I. FOR SPILLS LESS THAN 25 GALLONS AND NO SURFACE WATER IMPACTS, THE SPILL SHALL BE CLEANED AND LOCAL AGENCIES SHALL BE CONTACTED AS REQUIRED.
- J. GENERAL NPDES PERMIT NO. GAR 100002 DOES NOT AUTHORIZE THE DISCHARGE OF HAZARDOUS SUBSTANCES OR OIL RESULTING FROM AN ON-SITE SPILL.

THE CONTRACTOR SHALL NOTIFY THE LICENSED PROFESSIONAL WHO PREPARED THIS PLAN IF MORE THAN 1,320 GALLONS OF PETROLEUM IS STORED ONSITE (THIS INCLUDES CAPACITIES OF EQUIPMENT) OR IF ANY ONE PIECE OF EQUIPMENT HAS A CAPACITY GREATER THAN 660 GALLONS. THE CONTRACTOR WILL NEED A SPILL PREVENTION CONTAINMENT AND COUNTERMEASURES PLAN PREPARED BY A LICENSED PROFESSIONAL.

DESIGN PROFESSIONAL:  
DAVID MORGAN, P.E.  
LEVEL II CERTIFICATION  
No.: 0000011643  
EXPIRES : 06/03/2024



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3500 Parkway Lane  
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DPR SEAL



CLIENT INFORMATION

**FAYETTE COUNTY**

140 STONEWALL AVE W, STE 203  
FAYETTEVILLE, GA, 30214

PROJECT NAME

**OLD IVY ROAD  
STORM DRAIN  
REPLACEMENT**

FAYETTE COUNTY, GA

DRAWING ISSUE

JUNE 8, 2023

DATE

100% DESIGN PLANS

DESCRIPTION

MARK

DESIGNED BY: MDW

DRAWN BY: MDW

CHECKED BY: DMM/MDM

SUBMITTED BY: DMM

DATE: JUNE 8, 2023

PROJECT # 1220341

SHEET TITLE

**EROSION &  
SEDIMENT  
CONTROL  
NOTES**

SHEET NUMBER


**CE002**

SHEET 10 OF 17

ORIGINAL SHEET SIZE:  
22" X 34"



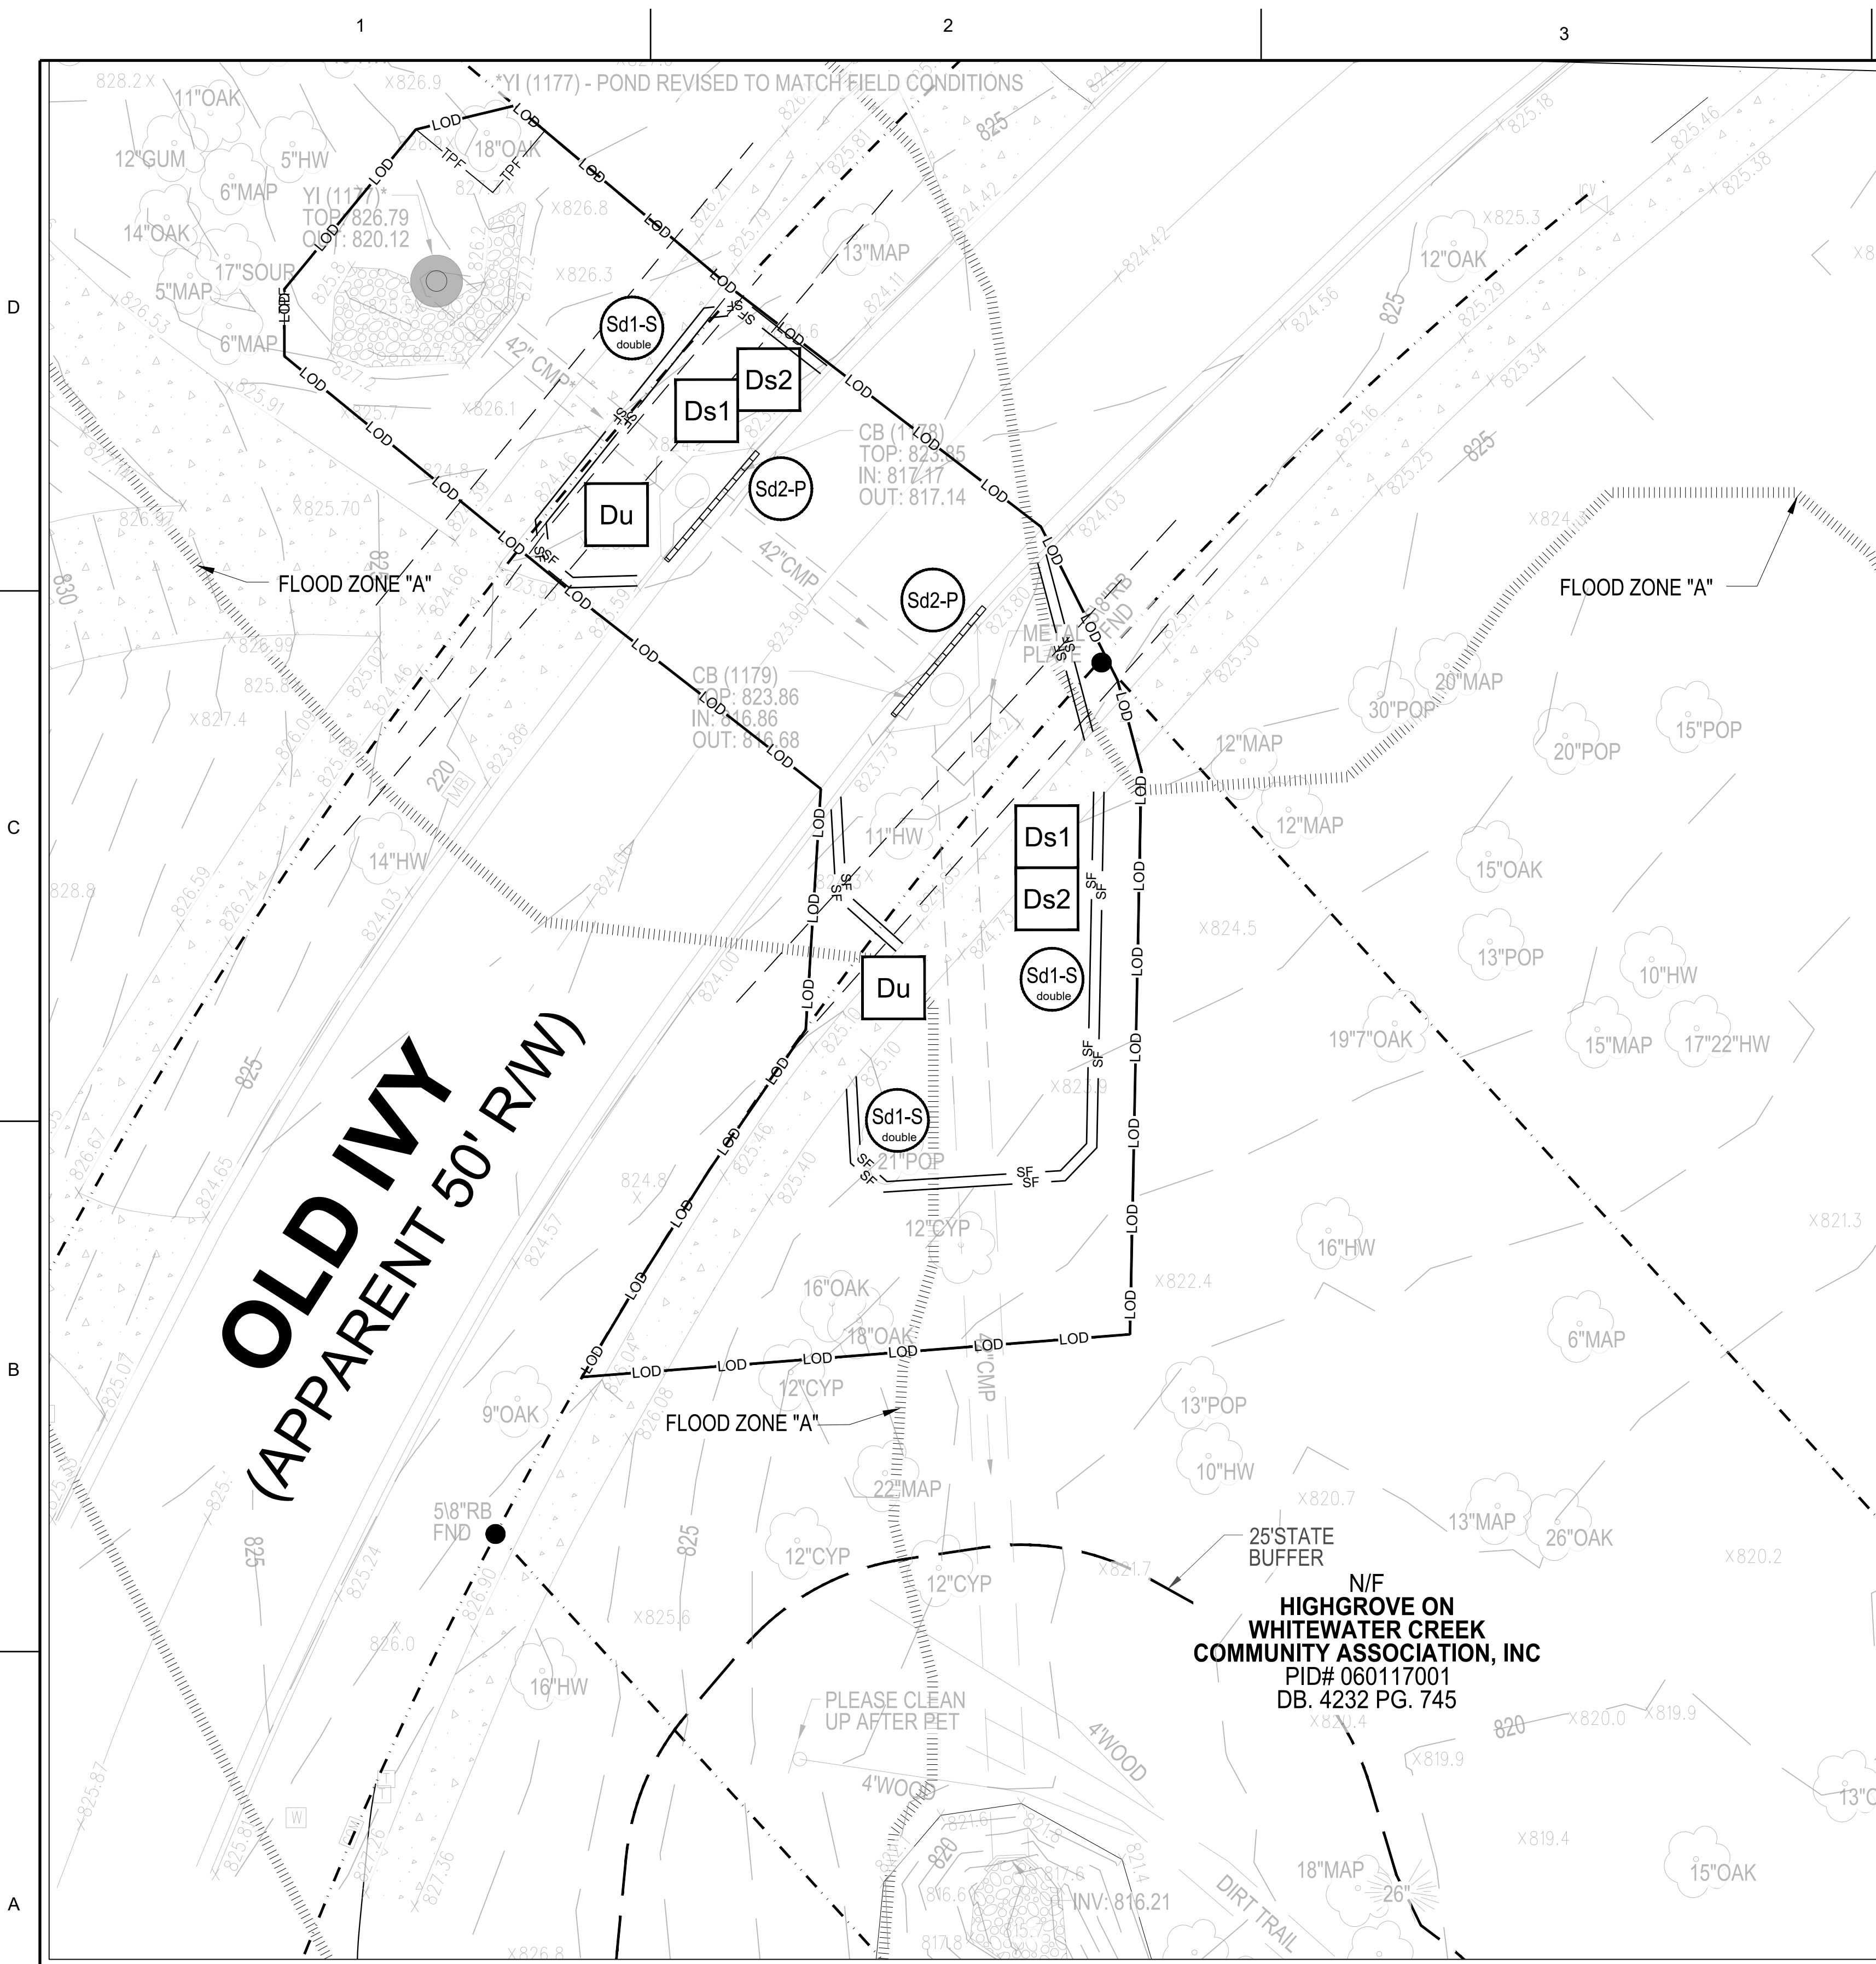FILE PATH: X:\FY22\122034104\_CAD\_BIM\04.02.CAD\CE101.PLOTTED BY: SANTMIER, ANNA DATE: 6/12/23



**GENERAL SHEET NOTES**

1. REFER TO SHEET CE001 FOR GENERAL CIVIL NOTES, LEGENDS, AND ABBREVIATIONS.
2. THIS SHEET IS PART OF A MULTI-SHEET SET OF EROSION CONTROL PLANS AND SHALL BE READ WITH THE FULL SET TO BEST ENSURE PROPER INTERPRETATION.
3. THE ESCAPE OF SEDIMENT FROM THE SITE SHALL BE PREVENTED BY THE INSTALLATION OF EROSION AND SEDIMENT CONTROL MEASURES AND PRACTICES PRIOR TO, OR CONCURRENT WITH, LAND DISTURBING ACTIVITIES.
4. EROSION CONTROL MEASURES WILL BE MAINTAINED AT ALL TIMES. IF FULL IMPLEMENTATION OF THE APPROVED PLAN DOES NOT PROVIDE FOR EFFECTIVE EROSION CONTROL, ADDITIONAL EROSION AND SEDIMENT CONTROL MEASURES SHALL BE IMPLEMENTED TO CONTROL OR TREAT THE SEDIMENT SOURCE.
5. ANY DISTURBED AREA LEFT EXPOSED FOR A PERIOD GREATER THAN 14 DAYS SHALL BE STABILIZED WITH MULCH OR TEMPORARY SEEDING.
6. ANY DISTURBED AREA LEFT IDLE FOR MORE THAN 30 DAYS SHALL BE STABILIZED WITH PERMANENT SEEDING.
7. CONSTRUCTION ENTRANCE TO BE DETERMINED BY COUNTY AND CONTRACTOR PRIOR TO CONSTRUCTION.

**SHEET LEGEND**

- LOD — LIMITS OF DISTURBANCE AND TEMPORARY CONSTRUCTION EASEMENT
- - - - - APPROXIMATE RIGHT OF WAY PROPERTY LINE
- — — — — SILT FENCE
- TPF — TREE PROTECTION FENCING

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 6/27/2023  
 CLIENT INFORMATION

**FAYETTE COUNTY**  
 140 STONEWALL AVE W, STE 203  
 FAYETTEVILLE, GA. 30214

PROJECT NAME  
**OLD IVY ROAD  
 STORM DRAIN  
 REPLACEMENT**  
 FAYETTE COUNTY, GA

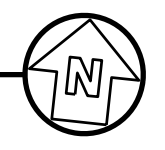
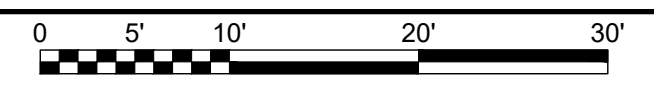
DRAWING ISSUE	
DATE	DESCRIPTION
JUNE 8, 2023	100% DESIGN PLANS

DESIGNED BY: MDW  
 DRAWN BY: MDW  
 CHECKED BY: DMM/MDM  
 SUBMITTED BY: DMM  
 DATE: JUNE 8, 2023  
 PROJECT # 1220341

SHEET TITLE  
**EROSION &  
 SEDIMENT  
 CONTROL PLAN  
 - INITIAL PHASE**

SHEET NUMBER  
**CE101**  
 SHEET 12 OF 17  
 ORIGINAL SHEET SIZE:  
 22" X 34"


**A1** EROSION & SEDIMENT CONTROL PLAN - INITIAL PHASE  
 SCALE: 1" = 10'





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CLIENT INFORMATION

**FAYETTE COUNTY**

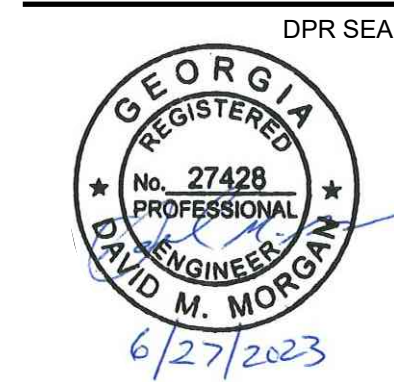140 STONEWALL AVE W, STE 203  
FAYETTEVILLE, GA, 30214

PROJECT NAME

**OLD IVY ROAD  
STORM DRAIN  
REPLACEMENT**

FAYETTE COUNTY, GA

DRAWING ISSUE

DATE	DESCRIPTION	MARK
JUNE 8, 2023	100% DESIGN PLANS	

DESIGNED BY:	MDW
DRAWN BY:	MDW
CHECKED BY:	DMM/MDM
SUBMITTED BY:	DMM
DATE:	JUNE 8, 2023
PROJECT #	1220341

SHEET TITLE

**EROSION &  
SEDIMENT  
CONTROL PLAN  
- FINAL PHASE**

SHEET NUMBER

**CE201**

SHEET 13 OF 17

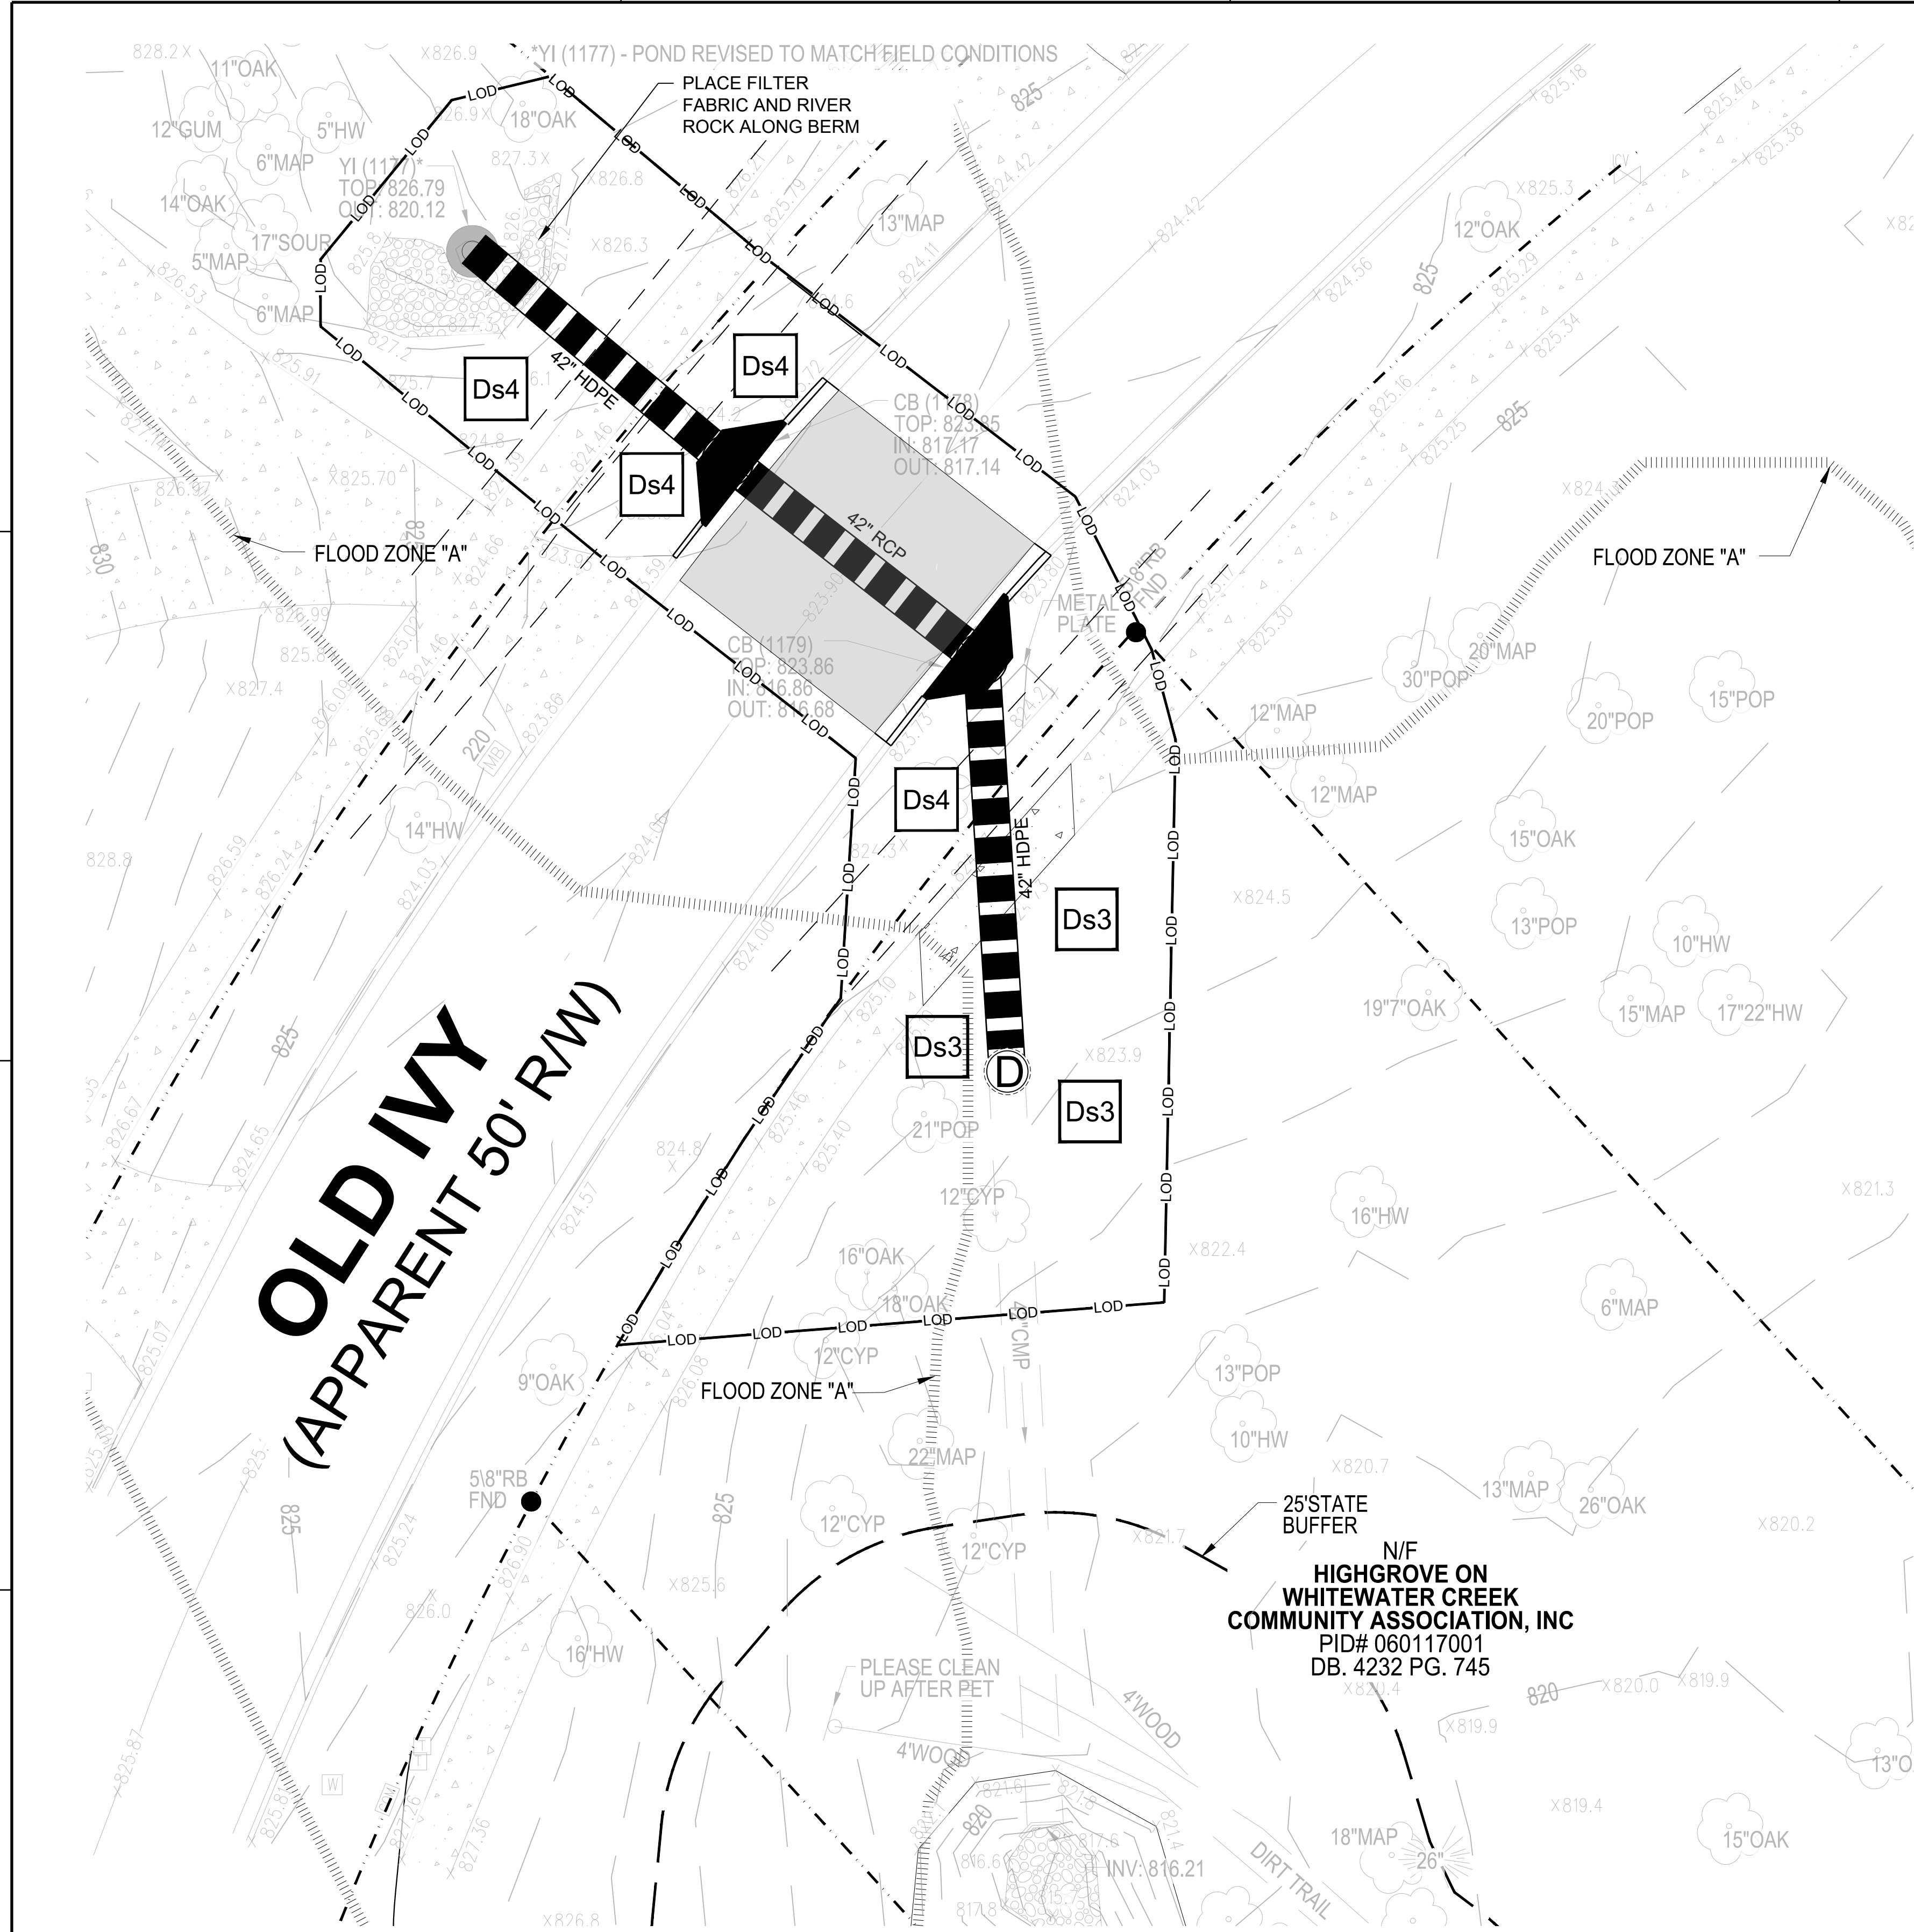
ORIGINAL SHEET SIZE:  
22" X 34"

**GENERAL SHEET NOTES**

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- EROSION CONTROL MEASURES WILL BE MAINTAINED AT ALL TIMES. IF FULL IMPLEMENTATION OF THE APPROVED PLAN DOES NOT PROVIDE FOR EFFECTIVE EROSION CONTROL, ADDITIONAL EROSION AND SEDIMENT CONTROL MEASURES SHALL BE IMPLEMENTED TO CONTROL OR TREAT THE SEDIMENT SOURCE.
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- CONSTRUCTION ENTRANCE TO BE DETERMINED BY COUNTY AND CONTRACTOR PRIOR TO CONSTRUCTION.



**SHEET LEGEND**

- LOD — LOD — LIMITS OF DISTURBANCE
- - - - - APPROXIMATE RIGHT OF WAY PROPERTY LINE
- SF — SILT FENCE
- TPF — TPF — TREE PROTECTION FENCING




**A1 EROSION & SEDIMENT CONTROL PLAN - FINAL PHASE**

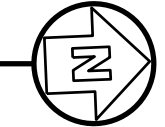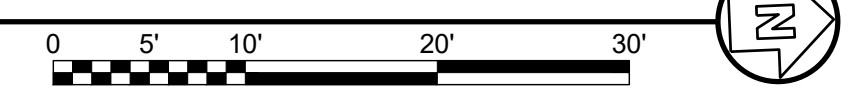SCALE: 1" = 10'



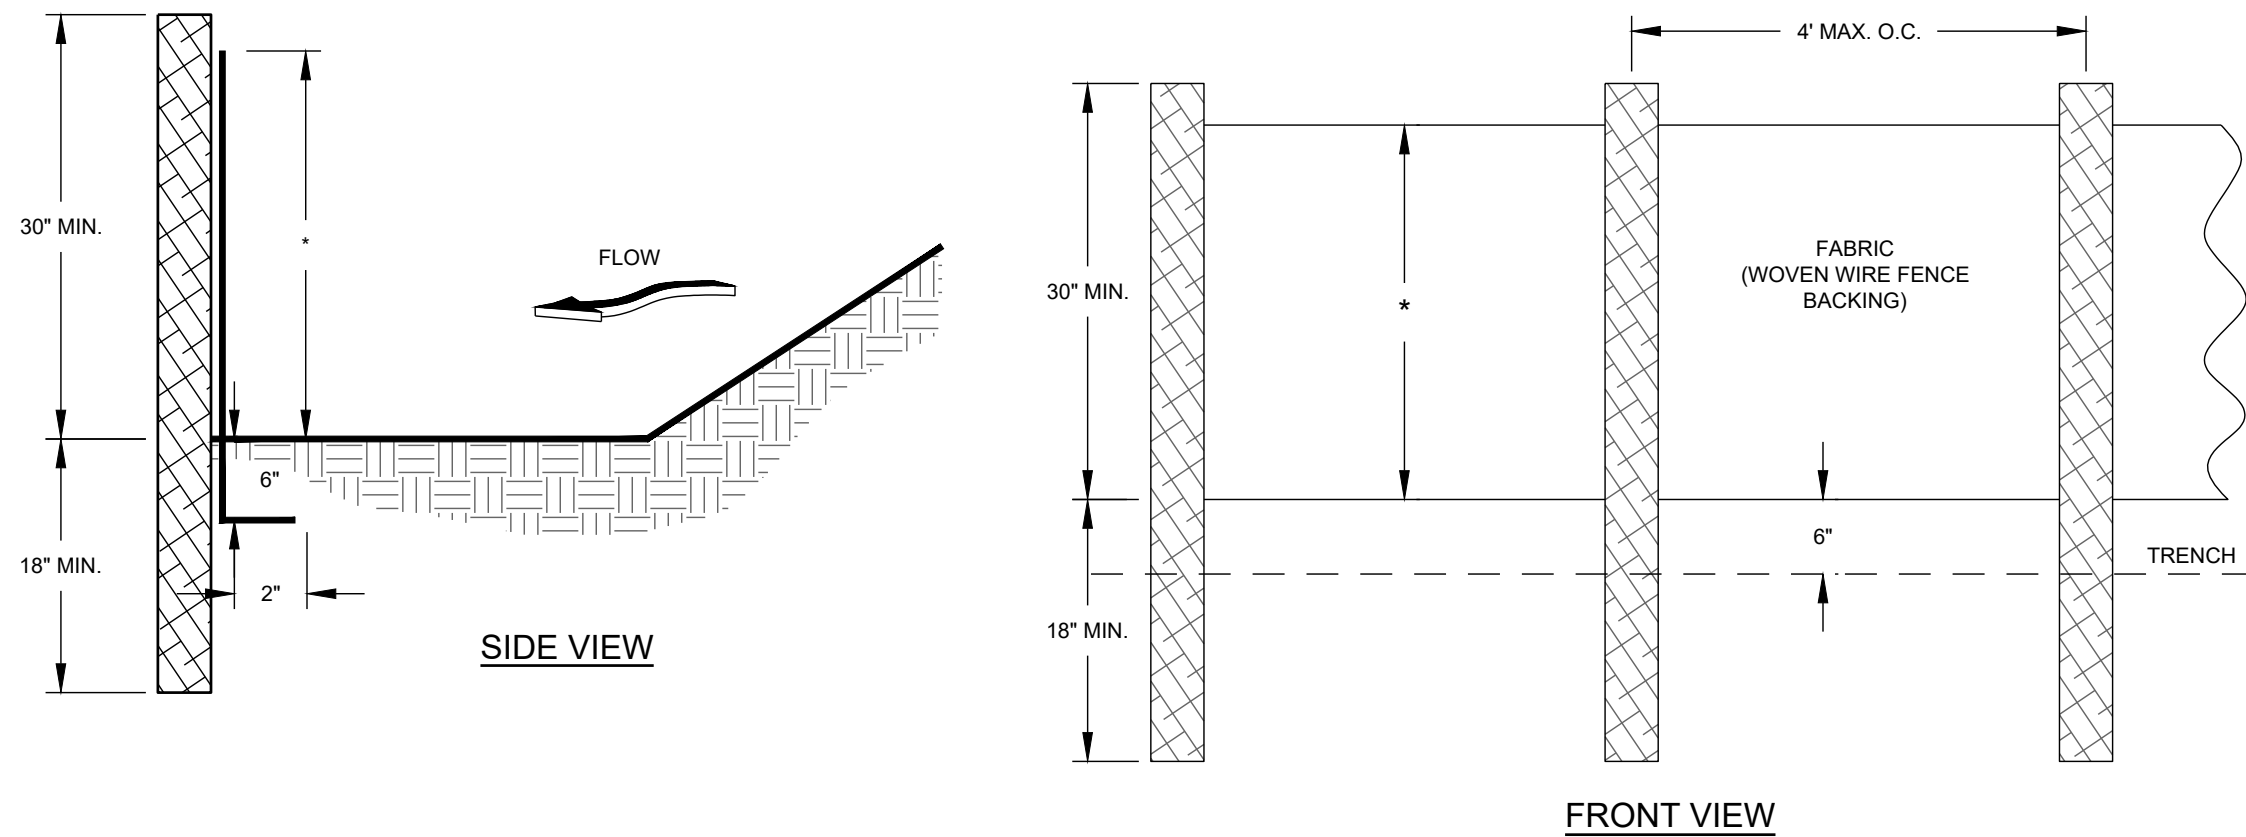FILE PATH: X:\FY23\1220341\04\_CAD\_BIM\04\_02\_CAD\ICE201\_PLOTTED BY: SANTMIER, ANNA DATE: 6/12/23



**MAINTENANCE**

SEDIMENT SHALL BE REMOVED ONCE IT HAS ACCUMULATED TO ONE-HALF THE ORIGINAL HEIGHT OF THE BARRIER. FILTER FABRIC SHALL BE REPLACED WHENEVER IT HAS DETERIORATED TO SUCH AN EXTENT THAT THE EFFECTIVENESS OF THE FABRIC IS REDUCED (APPROXIMATELY SIX MONTHS). TEMPORARY SEDIMENT BARRIERS SHALL REMAIN IN PLACE UNTIL DISTURBED AREAS HAVE BEEN PERMANENTLY STABILIZED. ALL SEDIMENT ACCUMULATED AT THE BARRIER SHALL BE REMOVED AND PROPERLY DISPOSED OF BEFORE THE BARRIER IS REMOVED.

**NOTES**

1. USE STEEL OR WOOD POSTS OR AS SPECIFIED BY THE EROSION, SEDIMENTATION, AND POLLUTION CONTROL PLAN.
2. HEIGHT (\*) IS TO BE SHOWN ON THE EROSION, SEDIMENTATION, AND POLLUTION CONTROL PLAN.

**C1 TYPE 'S' SILT FENCE**  
NO SCALE

Sd1-S  
double

**MULCHING MATERIAL**

1. DRY STRAW OR HAY SHALL BE APPLIED AT A DEPTH OF 2 TO 4 INCHES PROVIDING COMPLETE SOIL COVERAGE.
  2. WOOD WASTE (CHIPS, SAWDUST, OR BARK) SHALL BE APPLIED AT A DEPTH OF 2 TO 3 INCHES. ORGANIC MATERIAL FROM THE CLEARING STAGE OF DEVELOPMENT SHOULD REMAIN ON SITE, BE CHIPPED, AND APPLIED AS MULCH.
  3. CUTBACK ASPHALT (SLOW CURING) SHALL BE APPLIED AT 1200 GALLONS PER ACRE (OR 1/4 GALLON PER SQ. YD.)
  4. POLYETHYLENE FILM SHALL BE SECURED OVER BANKS OR STOCKPILED SOIL MATERIAL FOR TEMPORARY PROTECTION.
- APPLYING MULCH**
1. DRY STRAW OR HAY MULCH AND WOOD CHIPS SHALL BE APPLIED UNIFORMLY BY HAND OR BY MECHANICAL EQUIPMENT.
  2. IF THE AREA WILL EVENTUALLY BE COVERED WITH PERENNIAL VEGETATION, 20-30 POUNDS OF NITROGEN PER ACRE IN ADDITION TO THE NORMAL AMOUNT SHALL BE APPLIED TO OFFSET THE UPTAKE OF NITROGEN CAUSED BY DECOMPOSITION OF THE ORGANIC MULCHES.
  3. CUTBACK ASPHALT SHALL BE APPLIED UNIFORMLY. CARE SHOULD BE TAKEN IN AREAS OF PEDESTRIAN TRAFFIC DUE TO PROBLEMS OF "TRACKING IN" OR DAMAGE TO SHOES, CLOTHING, ETC.
  4. APPLY POLYETHYLENE FILM ON EXPOSED AREAS.

**ANCHORING MULCH**

1. STRAW OR HAY MULCH CAN BE PRESSED INTO THE SOIL WITH A DISK HARROW WITH THE DISK SET STRAIGHT OR WITH A SPECIAL "PACKER DISK." DISKS MAY BE USED SMOOTH OR SERRATED AND SHOULD BE 20 INCHES APART. THE EDGES OF THE DISK SHOULD BE DULL ENOUGH NOT TO CUT THE MULCH BUT TO PRESS IT INTO THE SOIL LEAVING MUCH OF IT IN AN UPRIGHT POSITION. STRAW OR HAY MULCH SHALL BE ANCHORED IMMEDIATELY AFTER APPLICATION.

STRAW OR HAY MULCH SPREAD WITH SPECIAL BLOWER-TYPE EQUIPMENT MAY BE ANCHORED WITH EMULSIFIED ASPHALT (GRADE AE-5 OR SS-1). THE ASPHALT EMULSION SHALL BE SPRAYED ONTO THE MULCH AS IT IS EJECTED FROM THE MACHINE. USE 100 GALLONS OF EMULSIFIED ASPHALT AND 100 GALLONS OF WATER PER TON OF MULCH. TACKIFIERS AND BINDERS CAN BE SUBSTITUTED FOR EMULSIFIED ASPHALT. PLEASE REFER TO SPECIFICATION Td-TACKIFIERS AND BINDERS. PLASTIC MESH OR NETTING WITH MESH AND LARGER THAN ONE INCH BY ONE INCH SHALL BE INSTALLED ACCORDING TO MANUFACTURER'S SPECIFICATIONS.

2. NETTING OF THE APPROPRIATE SIZE SHALL BE USED TO ANCHOR WOOD WASTE. OPENING OF THE NETTING SHALL NOT BE LARGER THAN THE AVERAGE SIZE OF THE WOOD WASTE CHIPS.
3. POLYETHYLENE FILM SHALL BE ANCHOR TRENCHED AT THE TOP AS WELL AS INCREMENTALLY AS NECESSARY.

TABLE 1. Mulching Application Requirements

MATERIAL	RATE	DEPTH
Straw or hay	-	2" to 4"
Wood waste, chips, sawdust, bark	-	2" to 3"
Cutback asphalt	1200 gal./acre, 1/4 gal./sq. yd / or see manufacturer's recommendations	-
Polyethylene film	Secure with soil, anchors, weights	-
Geotextiles, jute matting, netting, etc.	See manufacturer's recommendations	-

**INSTALLATION NOTES:**

1. INSTALL ALL OTHER REQUIRED BMPs FIRST.
2. GRADE SITE, IF POSSIBLE, TO PERMIT THE USE OF EQUIPMENT FOR APPLYING AND ANCHORING MULCH.
3. LOOSEN COMPACTED SOIL, IF POSSIBLE, TO A DEPTH OF 3 INCHES.
4. APPLY STRAW OR HAY UNIFORMLY, AS SHOWN IN TABLE 1, BY HAND OR MECHANICAL EQUIPMENT, AND ANCHOR BY PRESSING INTO SOIL OR USING NETTING.
5. MULCH ON SLOPES GREATER THAN 3% SHOULD BE ANCHORED WITH EMULSIFIED ASPHALT (GRADE AE-5 OR SS-1) OR OTHER SUITABLE TACKIFIER.
6. WOOD WASTE ON SLOPES FLATTER THAN 3:1 DO NOT NEED ANCHORING.
7. MULCH SHALL BE APPLIED TO ALL DISTURBED AREAS LEFT INACTIVE FOR FOURTEEN DAYS.

**MAINTENANCE NOTES:**

1. ADD MULCH AS NEEDED TO MAINTAIN THE SUGGESTED DEPTH.
2. IF ORGANIC MULCH IS TO BE LEFT AND INCORPORATED INTO THE SOIL, APPLY 20-30 POUNDS OF NITROGEN IN ADDITION TO THE FERTILIZER REQUIRED FOR VEGETATION.

**METHODS AND MATERIALS**

**A. TEMPORARY METHODS**

**MULCHES**  
SEE MULCHING. SYNTHETIC RESINS MAY BE USED INSTEAD OF ASPHALT TO BIND MULCH MATERIAL.

**VEGETATIVE COVER**  
SEE TEMPORARY SEEDING.

**SPRAY-ON ADHESIVES**  
THESE ARE USED ON MINERALS SOILS. KEEP TRAFFIC OFF THESE AREAS.

**SPRINKLING**  
THE SITE IS SPRINKLED WITH WATER UNTIL THE SURFACE IS WET. REPEAT AS NEEDED. THIS METHOD IS ESPECIALLY EFFECTIVE ON HAUL ROADS AND OTHER TRAFFIC ROUTES.

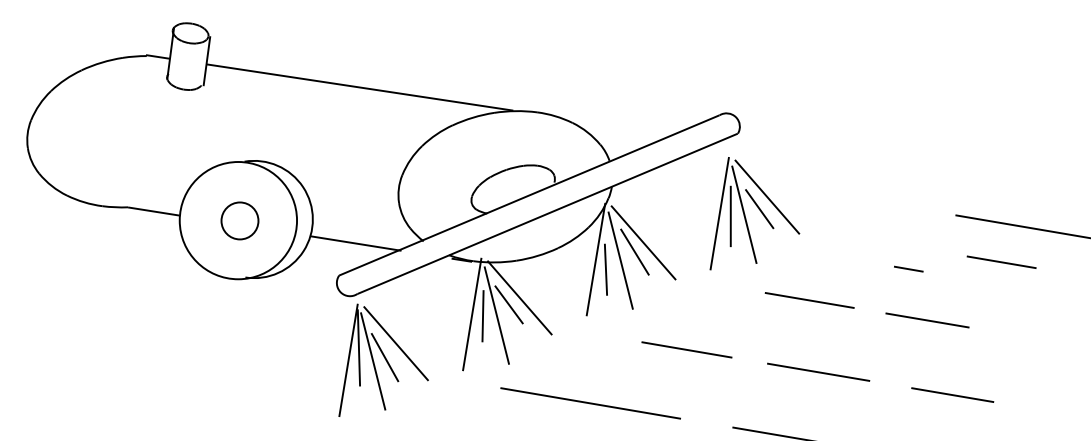
**BARRIERS**  
SOLID BOARD FENCES, BURLAP FENCES, CRATE WALLS, BALES OF HAY AND SIMILAR MATERIAL CAN BE USED TO CONTROL AIR CURRENTS AND SOIL BLOWING. BARRIERS PLACED AT RIGHT ANGLES TO PREVAILING CURRENTS AT INTERVALS OF ABOUT 15 TIMES THEIR HEIGHT ARE EFFECTIVE IN CONTROLLING WIND EROSION.

**B. PERMANENT METHODS**

**PERMANENT VEGETATION**  
SEE STANDARD FOR PERMANENT SEEDING, AND PERMANENT STABILIZATION WITH SOD. EXISTING TREES AND LARGE SHRUBS MAY AFFORD VALUABLE PROTECTION IF LEFT IN PLACE.

**TOPSOILING**  
THIS ENTAILS COVERING THE SURFACE WITH LESS EROSION SOIL MATERIAL. SEE TOPSOILING.

**STONE**  
COVER SURFACE WITH CRUSHED STONE OR COARSE GRAVEL.



**A1 DUST CONTROL**  
NO SCALE

Du


**A2 DISTURBED AREA STABILIZATION (WITH MULCHING ONLY)**  
NO SCALE

Ds1



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CLIENT INFORMATION

**FAYETTE COUNTY**

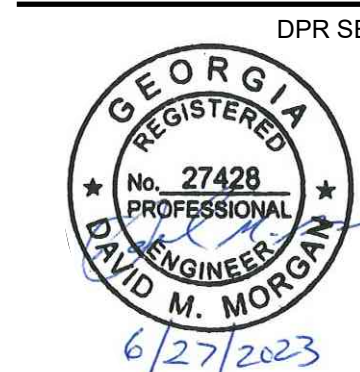140 STONEWALL AVE W, STE 203  
FAYETTEVILLE, GA. 30214

PROJECT NAME

**OLD IVY ROAD  
STORM DRAIN  
REPLACEMENT**

FAYETTE COUNTY, GA

DRAWING ISSUE

JUNE 8, 2023  
DATE

100% DESIGN PLANS  
DESCRIPTION

MARK

DESIGNED BY: MDW  
DRAWN BY: MDW  
CHECKED BY: DMM/MDM  
SUBMITTED BY: DMM  
DATE: JUNE 8, 2023  
PROJECT # 1220341

SHEET TITLE

**EROSION &  
SEDIMENT  
CONTROL  
DETAILS**

SHEET NUMBER

**CE501**

SHEET 14 OF 17

ORIGINAL SHEET SIZE:  
22" X 34"



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100% DESIGN SUBMITTAL



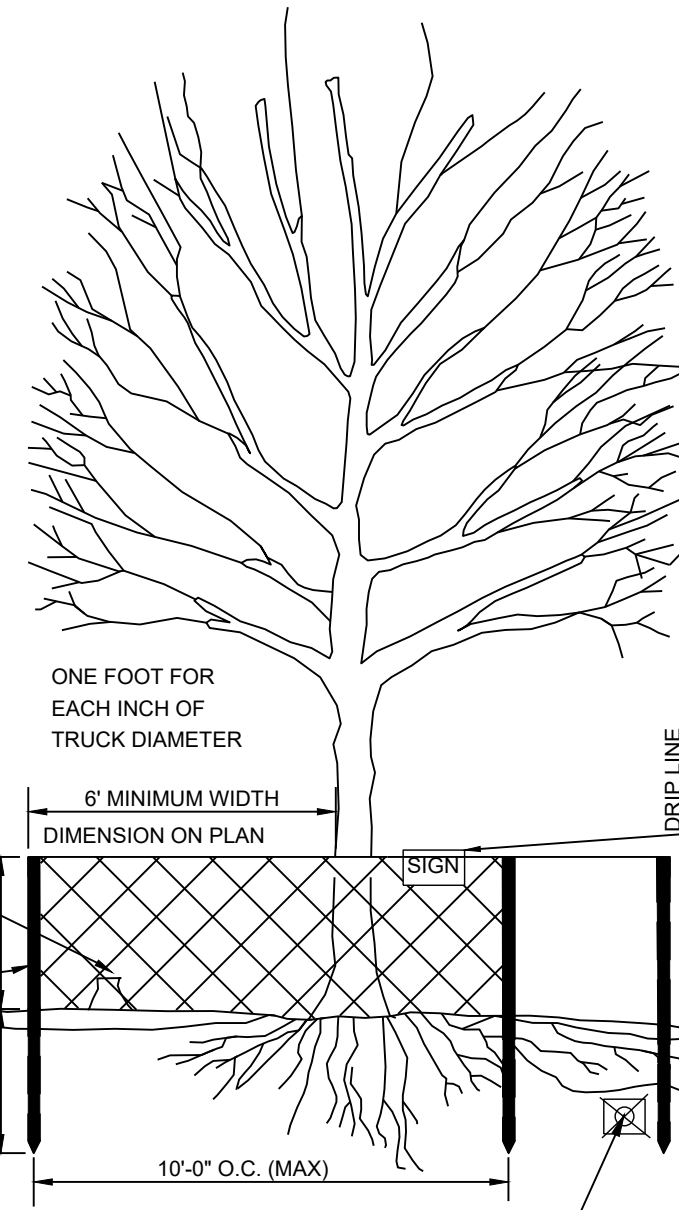
ANY ROOT OR BRANCH PRUNING SHALL BE DONE ONLY BY A LICENSED ARBORIST AT CONTRACTORS EXPENSE. NO GRADE CHANGE IS TO OCCUR IN TREE SAVE AREA. NO TREE WELLS OR AERATION SYSTEM. DO NOT DISTURB ORIGINAL GRADE.

DEAD TREES AND SHRUB GROWTH SHALL BE CUT FLUSH WITH ADJACENT GRADE. NO GRUBBING ALLOWED UNDER DRIP LINE.

ORANGE SAFETY NET ON METAL POSTS, 2"x4"x4" STANDARDS

REMOVE ALL BARRIERS UPON COMPLETION OF PROJECT.

DESTRUCTION/DEATH OF TREE DUE TO CONTRACTOR OPERATIONS WILL REQUIRE "RECOMPENSE" PLANTING, AT CONTRACTOR'S EXPENSE.




- NOTES:**
- SPACE STAKES AT INTERVALS SUFFICIENT TO MAINTAIN ALL FENCING OUT OF DRIP LINE OR AS SHOWN BY ENGINEER (SET STAKES NO GREATER THAN 6 FEET ON CENTER. REBAR IS NOT TO BE USED FOR STAKES).
  - MAINTAIN FENCE BY REPAIRING AND/OR REPLACING DAMAGED FENCE. DO NOT REMOVE FENCING PRIOR TO LANDSCAPING OPERATIONS.
  - DO NOT STORE OR STACK MATERIALS, EQUIPMENT, OR VEHICLES WITHIN FENCED AREA. FENCE SHALL BE ORANGE VINYL "SNOW FENCE" 4' HIGH MINIMUM.

TREE SAVE AREA: STAY OUT, NO GRADING, NO TRECHING, NO MATERIALS STORAGE, NO VEHICLES

NO TRENCHING OR TUNNELING FOR UTILITIES IN TREE SAVE AREA

SPECIES	BROADCAST RATES 2/ - PLS 3/		RESOURCE AREA	PLANTING RATES BY RESOURCE AREA PLANTING DATES												REMARKS
	PER ACRE	PER 1000 SQ. FT.		OPTIMUM - PERMISSIBLE BUT MARGINAL												
				J	F	M	A	M	J	J	A	S	O	N	D	
BERMUDA, COMMON (CYNODON DACTYLON) HULLED SEED ALONE WITH OTHER PERENNIALS	10 LBS 6 LBS	0.2 LB 0.1 LB	P C													1,787,000 SEED PER POUND. QUICK COVER. LOW GROWING AND SOD FORMING. FULL SUN. GOOD FOR ATHLETIC FIELDS.
BERMUDA, COMMON (CYNODON DACTYLON) UNHULLED SEED WITH TEMPORARY COVER WITH OTHER PERENNIALS	10 LBS 6 LBS	0.2 LB 0.1 LB	P C													PLANT WITH WINTER ANNUALS. PLANT WITH TALL FESCUE.
CENTIPEDE (EREMOCHLOA OPHUROIDES)	BLOCK SOD ONLY		P C													DROUGHT TOLERANT. FULL SUN OR PARTIAL SHADE. EFFECTIVE ADJACENT TO CONCRETE AND IN CONCENTRATED FLOW AREAS. IRRIGATION AS NEEDED UNTIL FULLY ESTABLISHED. DO NOT PLANT NEAR PASTURES. WINTERHARDY AS FAR NORTH AS ATHENS AND ATLANTA.
FESCUE, TALL (FESTUCA ARUNDINACEA) ALONE WITH OTHER PERENNIALS	50 LBS 30 LBS	1.1 LB 0.7 LB	M-L P													227,000 SEED PER POUND. USE ALONE ONLY ON BETTER SITES. NOT FOR DROUGHTY SOILS. MIX WITH PERENNIAL LESPEDEZAS OR CROWN VETCH. APPLY TOPDRESSING IN SPRING FOLLOWING FALL PLANTINGS. NOT FOR HEAVY USE AREAS OR ATHLETIC FIELDS.
LOVEGRASS, WEEPING (ERAGROSTIS CURVULA) ALONE WITH OTHER PERENNIALS	4 LBS 2 LBS	0.1 LB 0.05 LB	M-L P C													1,500,000 SEED PER POUND. QUICK COVER. DROUGHT TOLERANT. GROWS WELL WITH SERICEA LESPEDEZA ON ROADBANKS.


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**FAYETTE COUNTY**  
140 STONEWALL AVE W, STE 203  
FAYETTEVILLE, GA 30214

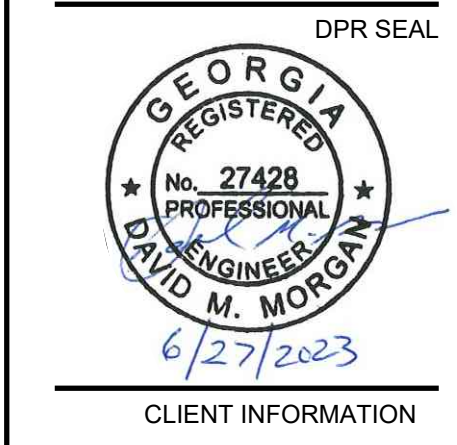PROJECT NAME  
**OLD IVY ROAD  
STORM DRAIN  
REPLACEMENT**  
FAYETTE COUNTY, GA

**C1 TREE PROTECTION FENCE**



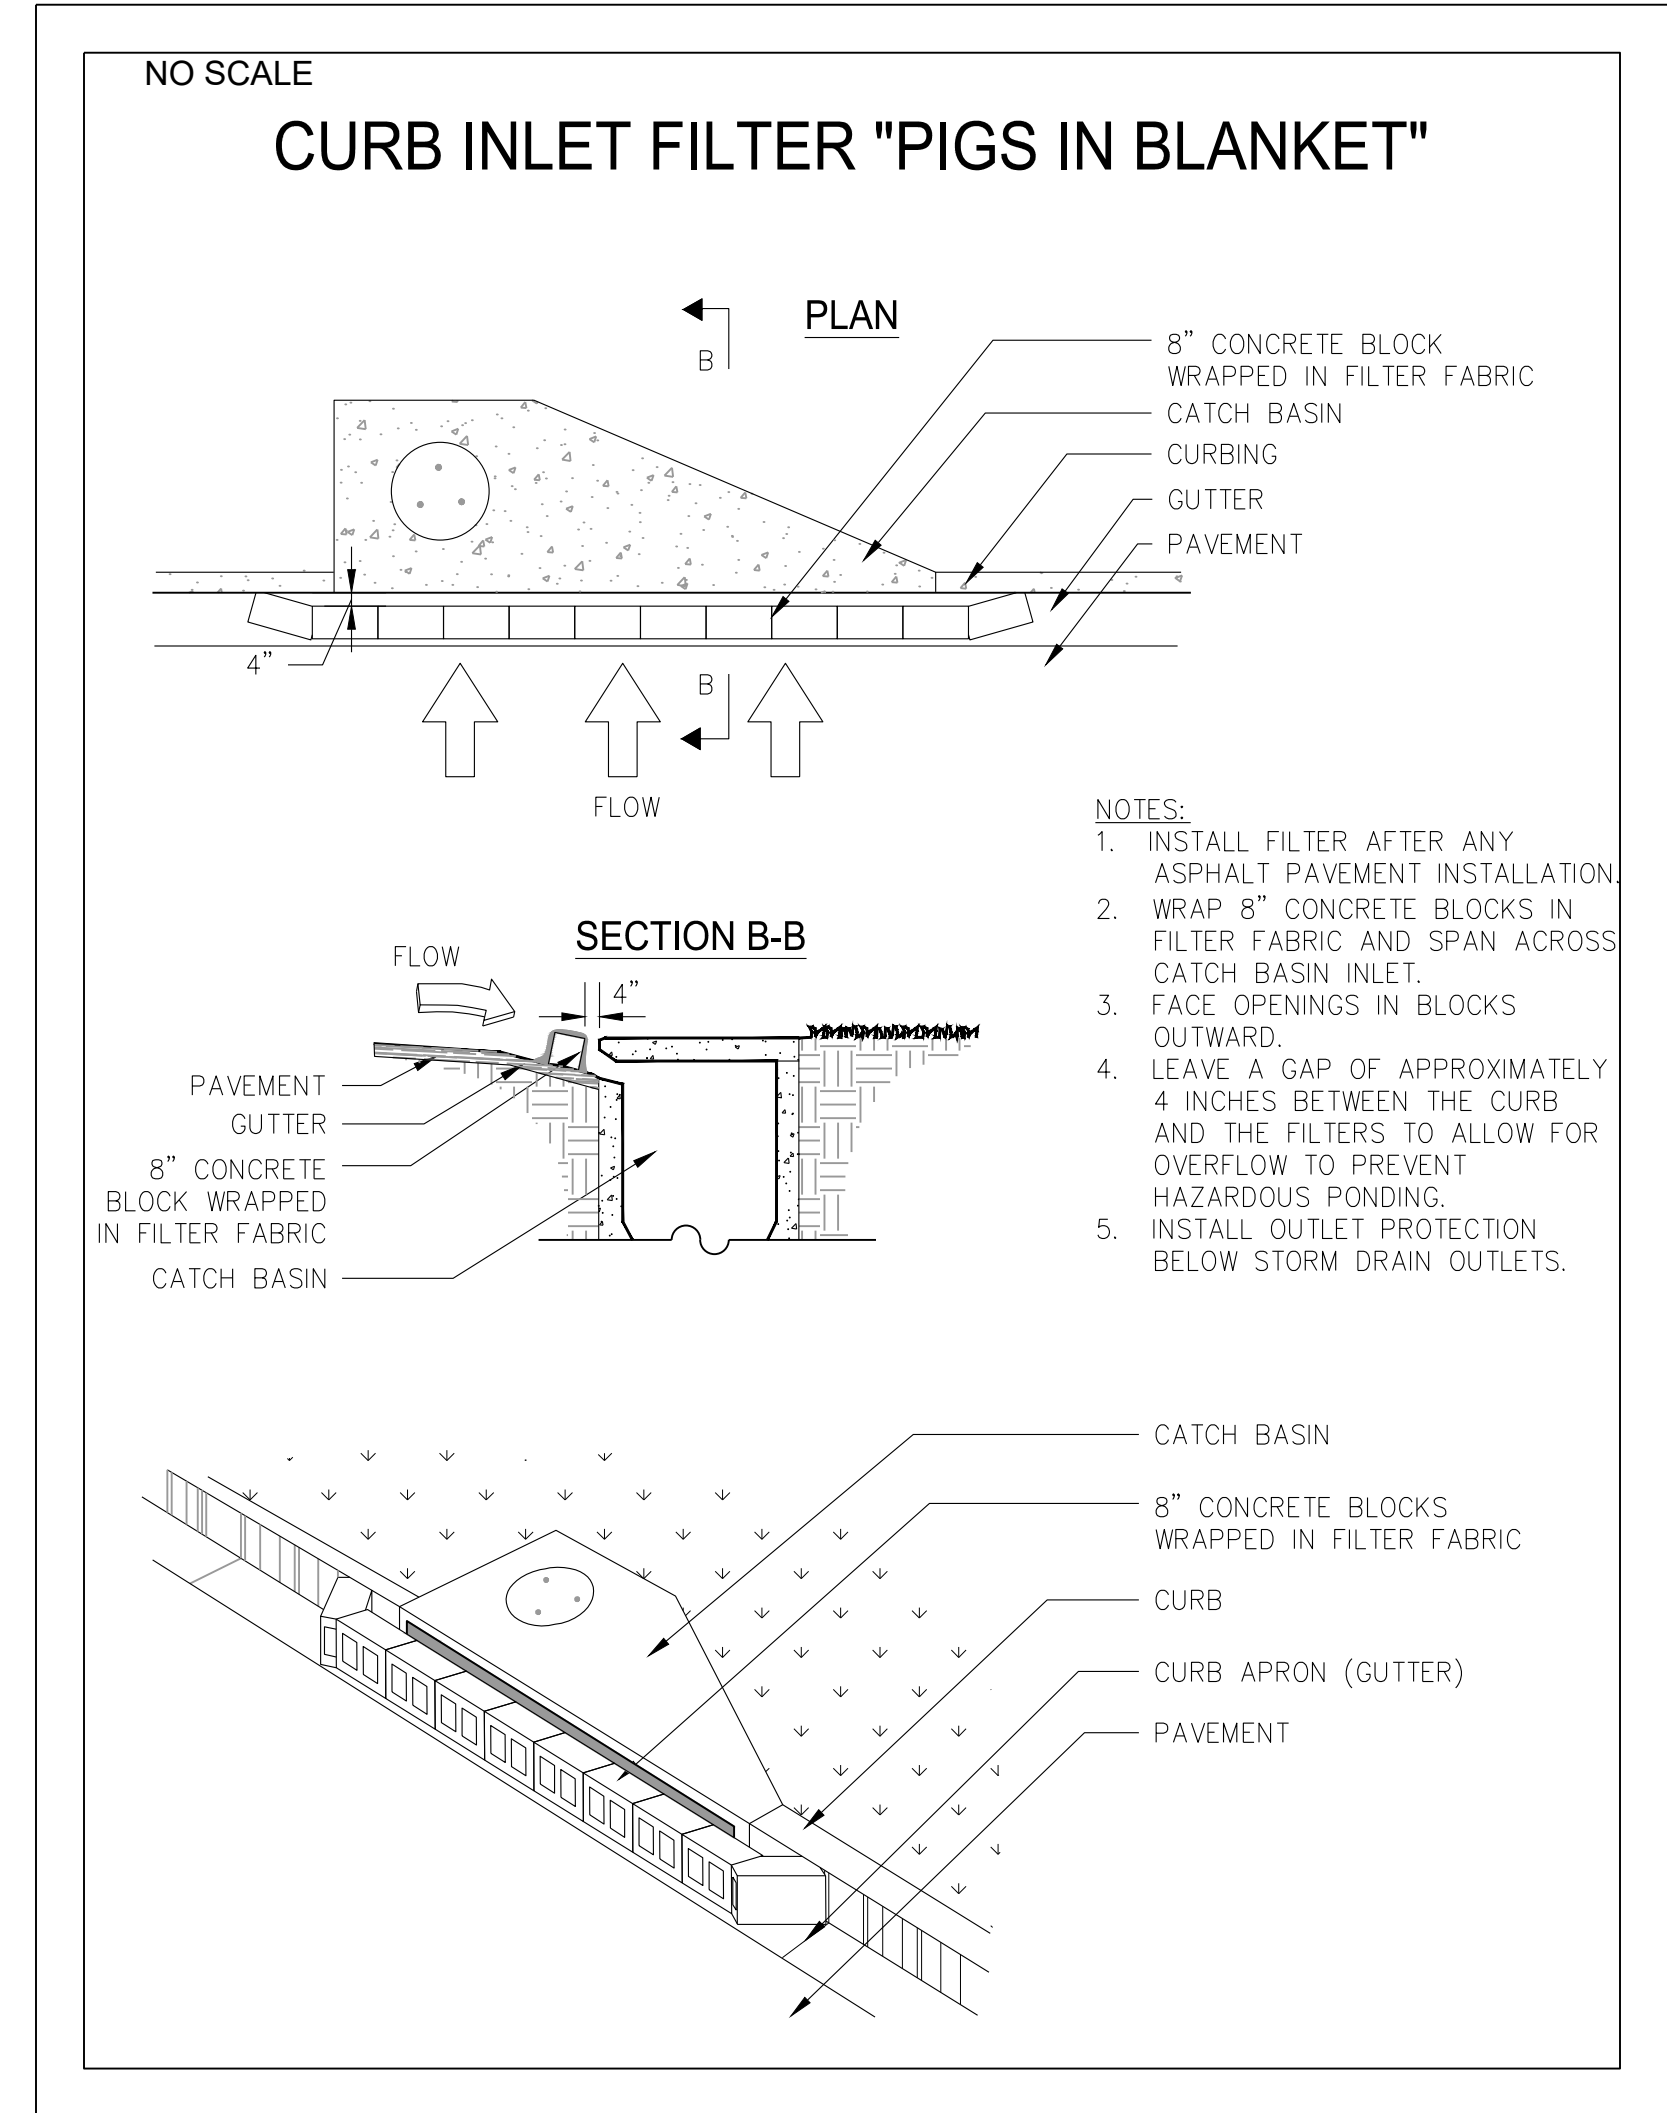**A1 CURB INLET FILTER " PIG IN BLANKET"**  
NO SCALE

**CONSTRUCTION SPECIFICATIONS**

- GRADING & SHAPING**
- GRADING AND SHAPING MAY NOT BE REQUIRED WHERE HYDRAULIC SEEDING AND FERTILIZING EQUIPMENT IS TO BE USED. VERTICAL BANKS SHALL BE SLOPED TO ENABLE PLANT ESTABLISHMENT.
  - WHEN CONVENTIONAL SEEDING AND FERTILIZING ARE TO BE DONE, GRADE AND SHAPE WHERE FEASIBLE AND PRACTICAL. SO THAT EQUIPMENT CAN BE USED SAFELY AND EFFICIENTLY DURING SEEDBED PREPARATION, SEEDING, MULCHING AND MAINTENANCE OF THE VEGETATION.
  - CONCENTRATIONS OF WATER THAT WILL CAUSE EXCESSIVE SOIL EROSION SHALL BE DIVERTED TO A SAFE OUTLET. DIVERSIONS AND OTHER TREATMENT PRACTICES SHALL CONFORM WITH THE APPROPRIATE STANDARDS AND SPECIFICATIONS.
- LIME AND FERTILIZER RATES AND ANALYSIS**
- AGRICULTURAL LIME IS REQUIRED AT THE RATE OF ONE TO TWO TONS PER ACRE UNLESS SOIL TESTS INDICATE OTHERWISE. GRADED AREAS REQUIRE LIME APPLICATION. IF LIME IS APPLIED WITHIN SIX MONTHS OF PLANTING PERMANENT PERENNIAL VEGETATION, ADDITIONAL LIME IS NOT REQUIRED. AGRICULTURAL LIME SHALL BE WITHIN THE SPECIFICATIONS OF THE GEORGIA DEPARTMENT OF AGRICULTURE.
  - LIME SPREAD BY CONVENTIONAL EQUIPMENT SHALL BE "GROUND LIMESTONE." GROUND LIMESTONE IS CALCITIC OR DOLOMITIC LIMESTONE GROUND SO THAT 90% OF THE MATERIAL WILL PASS THROUGH A 10-MESH SIEVE, NOT LESS THAN 50% WILL PASS THROUGH A 50-MESH SIEVE AND NOT LESS THAN 25% WILL PASS THROUGH A 100-MESH SIEVE.
  - FAST ACTING LIME SPREAD BY HYDRAULIC SEEDING EQUIPMENT SHOULD BE "FINELY GROUND LIMESTONE" SPANNING FROM THE 180 MICRON SIZE TO THE 5 MICRON SIZE. FINELY GROUND LIMESTONE IS CALCITIC OR DOLOMITIC LIMESTONE GROUND SO THAT 95% OF THE MATERIAL WILL PASS THROUGH A 100-MESH SIEVE.
  - IT IS DESIRABLE TO USE DOLOMITIC LIMESTONE IN THE SAND HILLS, SOUTHERN COASTAL PLAIN AND ATLANTIC COAST FLATWOODS MLRAs (SEE FIGURE 6-4.1).
  - AGRICULTURAL LIME IS GENERALLY NOT REQUIRED WHERE ONLY TREES ARE PLANTED.
  - INITIAL FERTILIZATION, NITROGEN, TOPDRESSING, AND MAINTENANCE FERTILIZER REQUIREMENTS FOR EACH SPECIES OR COMBINATION OF SPECIES ARE LISTED IN TABLE 6-5.1
- LIME AND FERTILIZER APPLICATION**
- WHEN HYDRAULIC SEEDING EQUIPMENT IS USED, THE INITIAL FERTILIZER SHALL BE MIXED WITH SEED, INNOCULANT (IF NEEDED), AND WOOD CELLULOSE OR WOOD PULP FIBER MULCH AND APPLIED IN A SLURRY. THE INNOCULANT, IF NEEDED, SHALL BE MIXED WITH THE SEED PRIOR TO BEING PLACED INTO THE HYDRAULIC SEEDER. THE SLURRY MIXTURE WILL BE AGITATED DURING APPLICATION TO KEEP THE INGREDIENTS THOROUGHLY MIXED. THE MIXTURE WILL BE SPREAD UNIFORMLY OVER THE AREA WITHIN ONE HOUR AFTER BEING PLACED IN THE HYDROSEEDER.
  - FINELY GROUND LIMESTONE CAN BE APPLIED IN THE MULCH SLURRY OR IN COMBINATION WITH THE TOP DRESSING.
  - WHEN CONVENTIONAL PLANTING IS TO BE DONE, LIME AND FERTILIZER SHALL BE APPLIED UNIFORMLY IN ONE OF THE FOLLOWING WAYS:
    - APPLY BEFORE LAND PREPARATION SO THAT IT WILL BE MIXED WITH THE SOIL DURING SEEDBED PREPARATION.
    - MIX WITH THE SOIL USED TO FILL THE HOLES, DISTRIBUTE IN FURROWS.
    - BROADCAST AFTER STEEP SURFACES ARE SCARIFIED, PITTED OR TRENCHED.
    - A FERTILIZER PELLET SHALL BE PLACED AT ROOT DEPTH IN THE CLOSING HOLE BESIDE EACH PINE TREE SEEDLING.

- \* REVISED PER LATEST EDITION OF MANUAL FOR EROSION & SEDIMENT CONTROL IN GEORGIA.

**SEEDING SCHEDULE  
PERMANENT COVER**

**FERTILIZER REQUIREMENTS**

TYPE OF SPECIES	YEAR	ANALYSIS OR EQUIVALENT N-P-K	RATE	N TOP DRESSING RATE
1. COOL SEASON GRASSES	FIRST	6-12-12	1500 LBS./AC.	50-100 LBS./AC. 1/ 2/
	SECOND MAINTENANCE	6-12-12 10-10-10	1000 LBS./AC. 400 LBS./AC.	- 30
2. COOL SEASON GRASSES AND LEGUMES	FIRST	6-12-12	1500 LBS./AC.	0-50 LBS./AC. 1/
	SECOND MAINTENANCE	0-10-10 0-10-10	1000 LBS./AC. 400 LBS./AC.	- -
3. GROUND COVERS	FIRST	10-10-10	1300 LBS./AC. 3/	-
	SECOND MAINTENANCE	10-10-10 10-10-10	1300 LBS./AC. 3/ 1100 LBS./AC.	- -
4. PINE SEEDLINGS	FIRST	20-10-5	ONE 21-GRAM PELLET PER SEEDLING PLACED IN THE CLOSING HOLE	-
5. TEMPORARY COVER CROPS SEEDED ALONE	FIRST	10-10-10	500 LBS./AC.	30 LBS./AC. 5/
6. WARM SEASON GRASSES	FIRST	6-12-12	1500 LBS./AC.	50-100 LBS./AC. 2/ 6/
	SECOND MAINTENANCE	6-12-12 10-10-10	800 LBS./AC. 400 LBS./AC.	50-100 LBS./AC. 2/ 30 LBS./AC.
7. WARM SEASON GRASSES AND LEGUMES	FIRST	6-12-12	1500 LBS./AC.	50 LBS./AC. 6/
	SECOND MAINTENANCE	0-10-10 0-10-10	1000 LBS./AC. 400 LBS./AC.	- -

- 1/ APPLY IN SPRING FOLLOWING SEEDING.
- 2/ APPLY IN SPLIT APPLICATIONS WHEN HIGH RATES ARE USED.
- 3/ APPLY IN 3 SPLIT APPLICATIONS.
- 4/ APPLY WHEN PLANTS ARE PRUNED.
- 5/ APPLY WHEN PLANTS GROW TO A HEIGHT OF 2 TO 4 INCHES.

DRAWING ISSUE  
DATE: JUNE 8, 2023  
DESCRIPTION: 100% DESIGN PLANS  
MARK

DESIGNED BY: MDW  
DRAWN BY: MDW  
CHECKED BY: DMM/MDM  
SUBMITTED BY: DMM  
DATE: JUNE 8, 2023  
PROJECT #: 1220341

**EROSION & SEDIMENT CONTROL DETAILS**

SHEET NUMBER  
**CE503**  
SHEET 16 OF 17  
ORIGINAL SHEET SIZE: 22" X 34"

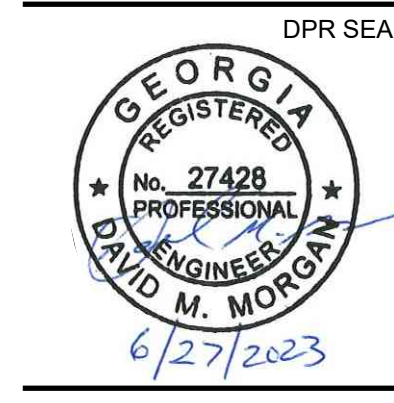






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STORM DRAIN  
REPLACEMENT**

FAYETTE COUNTY, GA

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DETAILS


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C-502

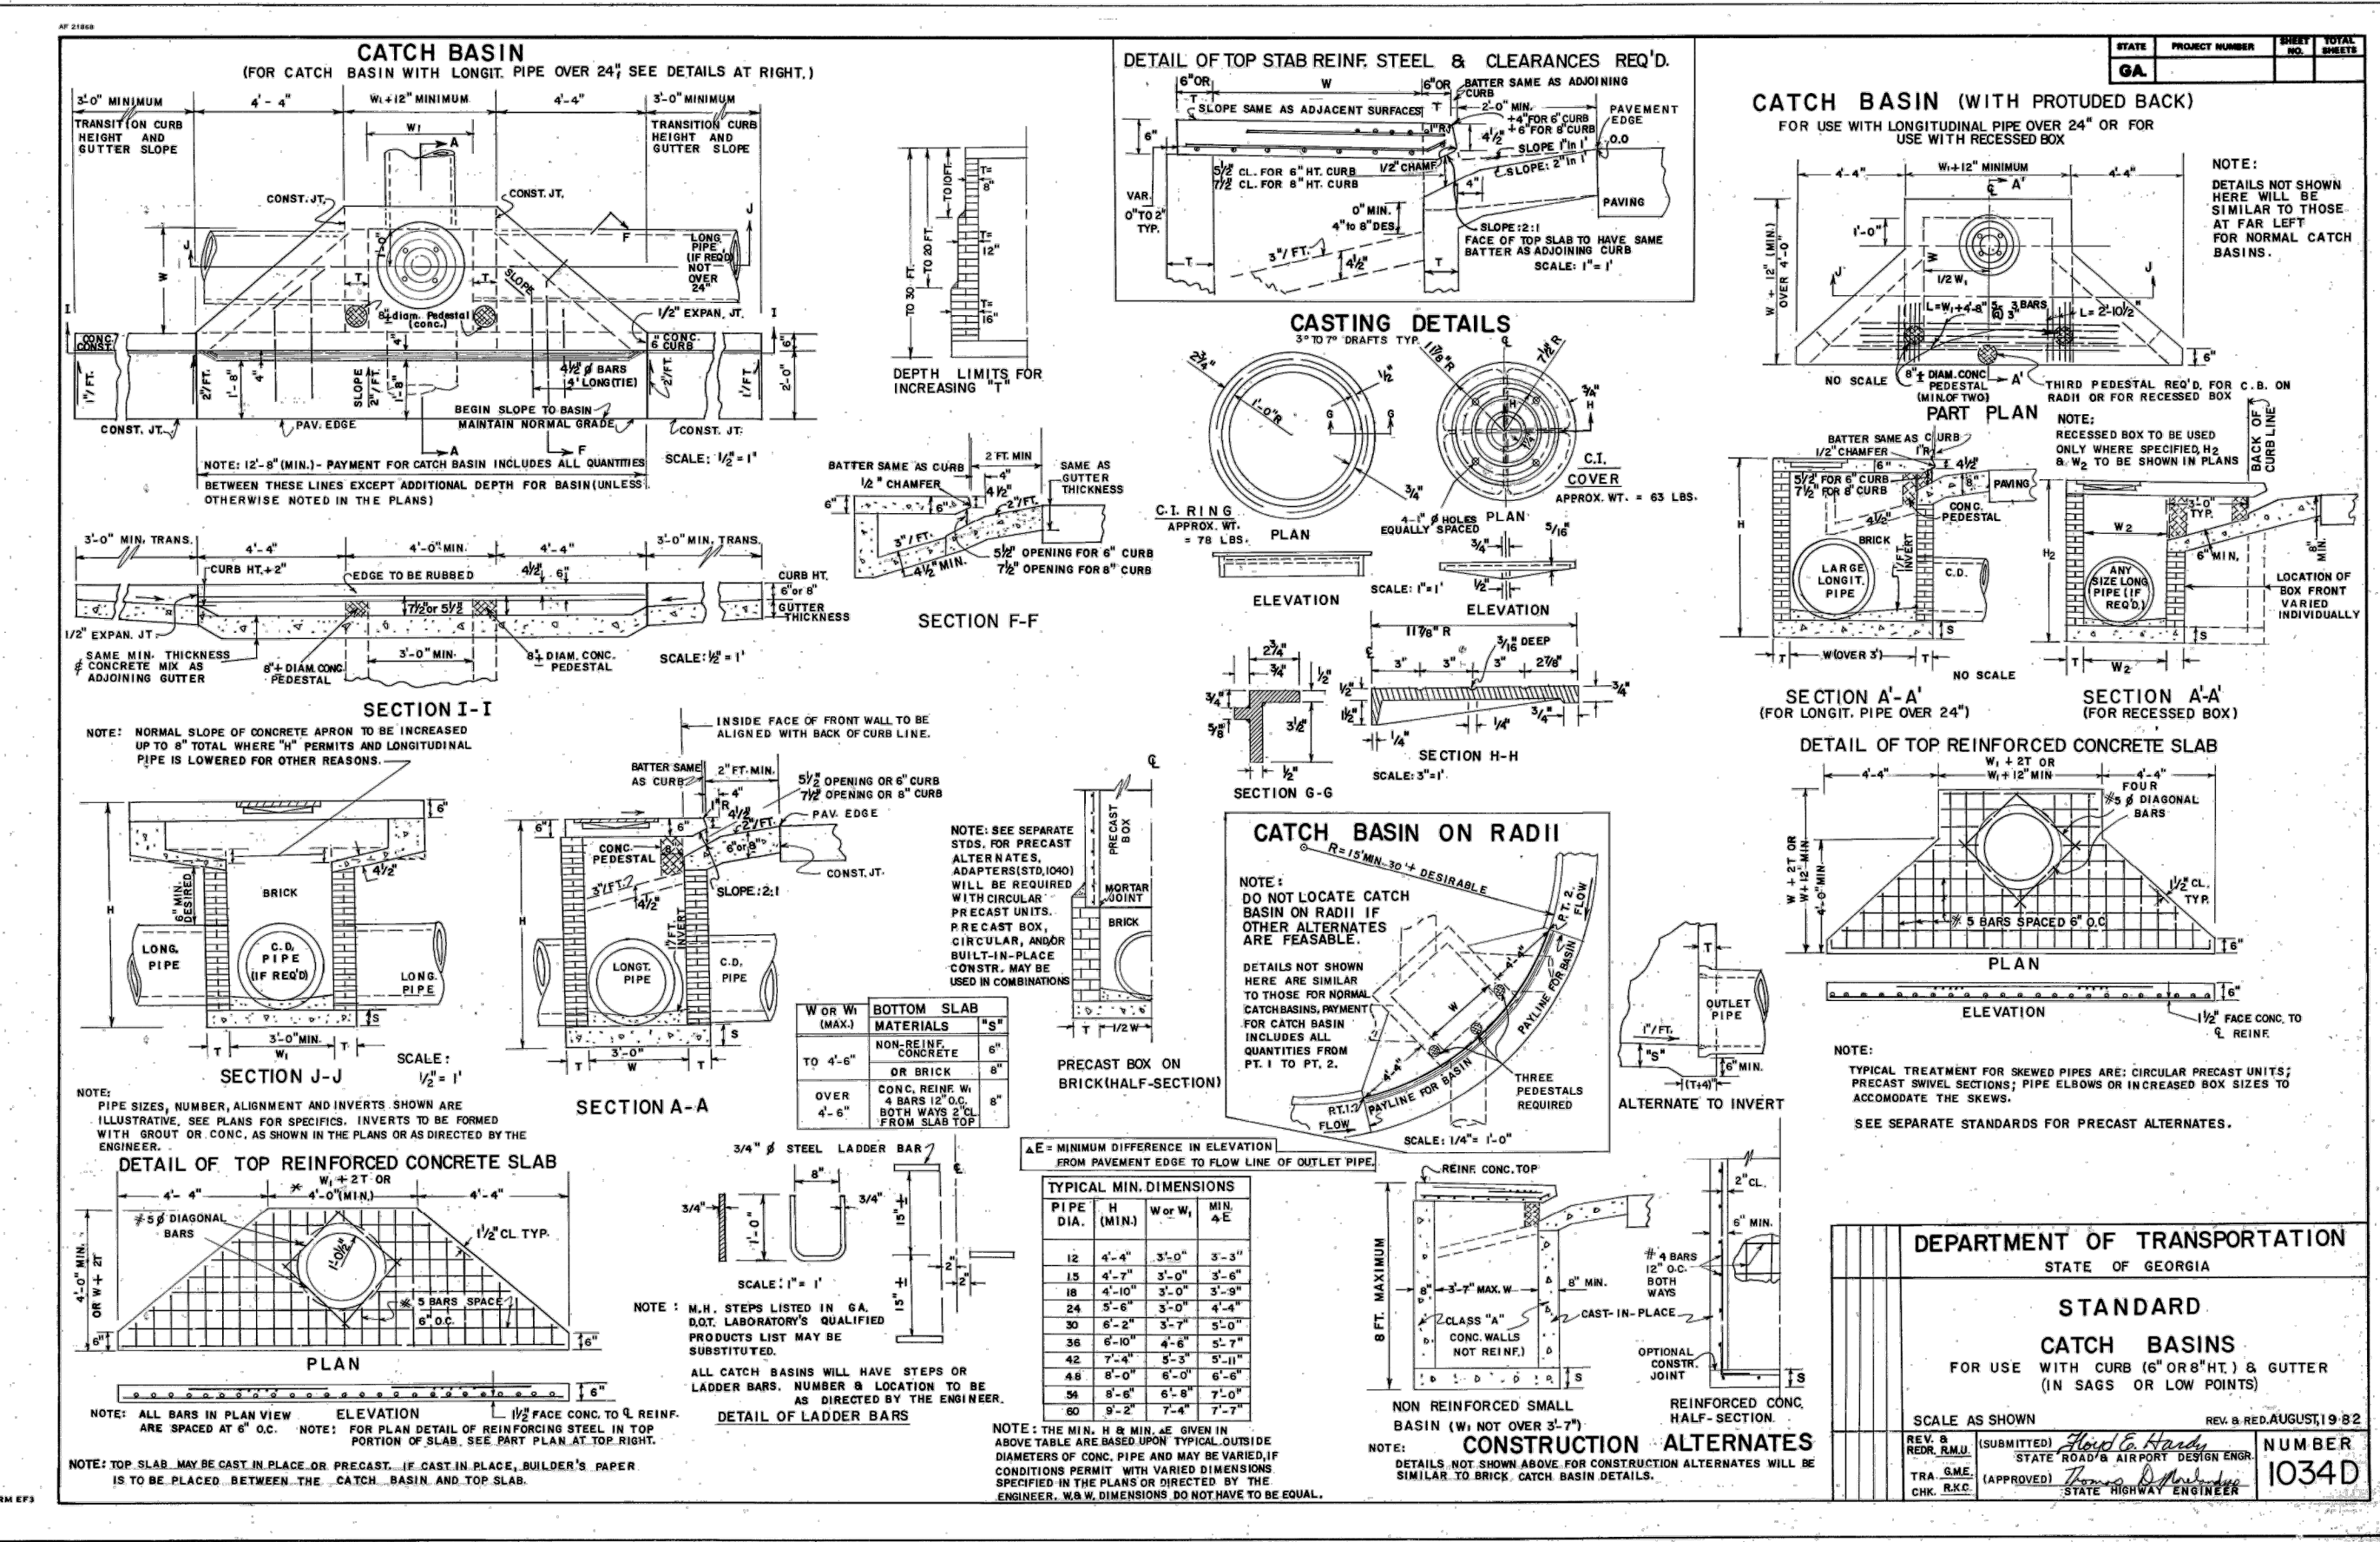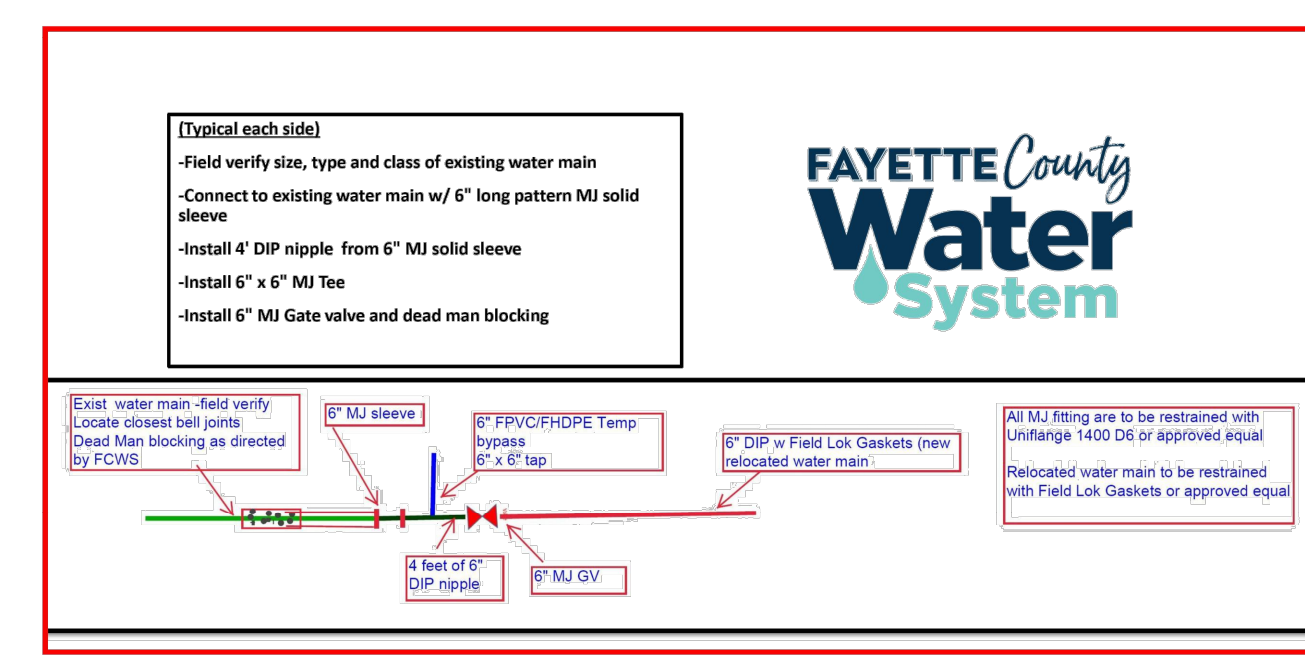
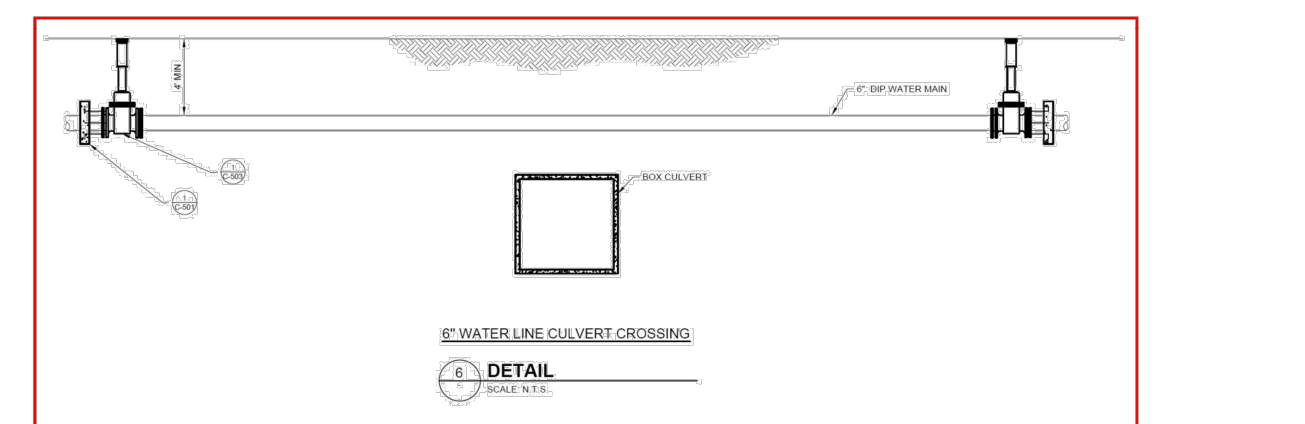
SHEET --- OF 17  
ORIGINAL SHEET SIZE:  
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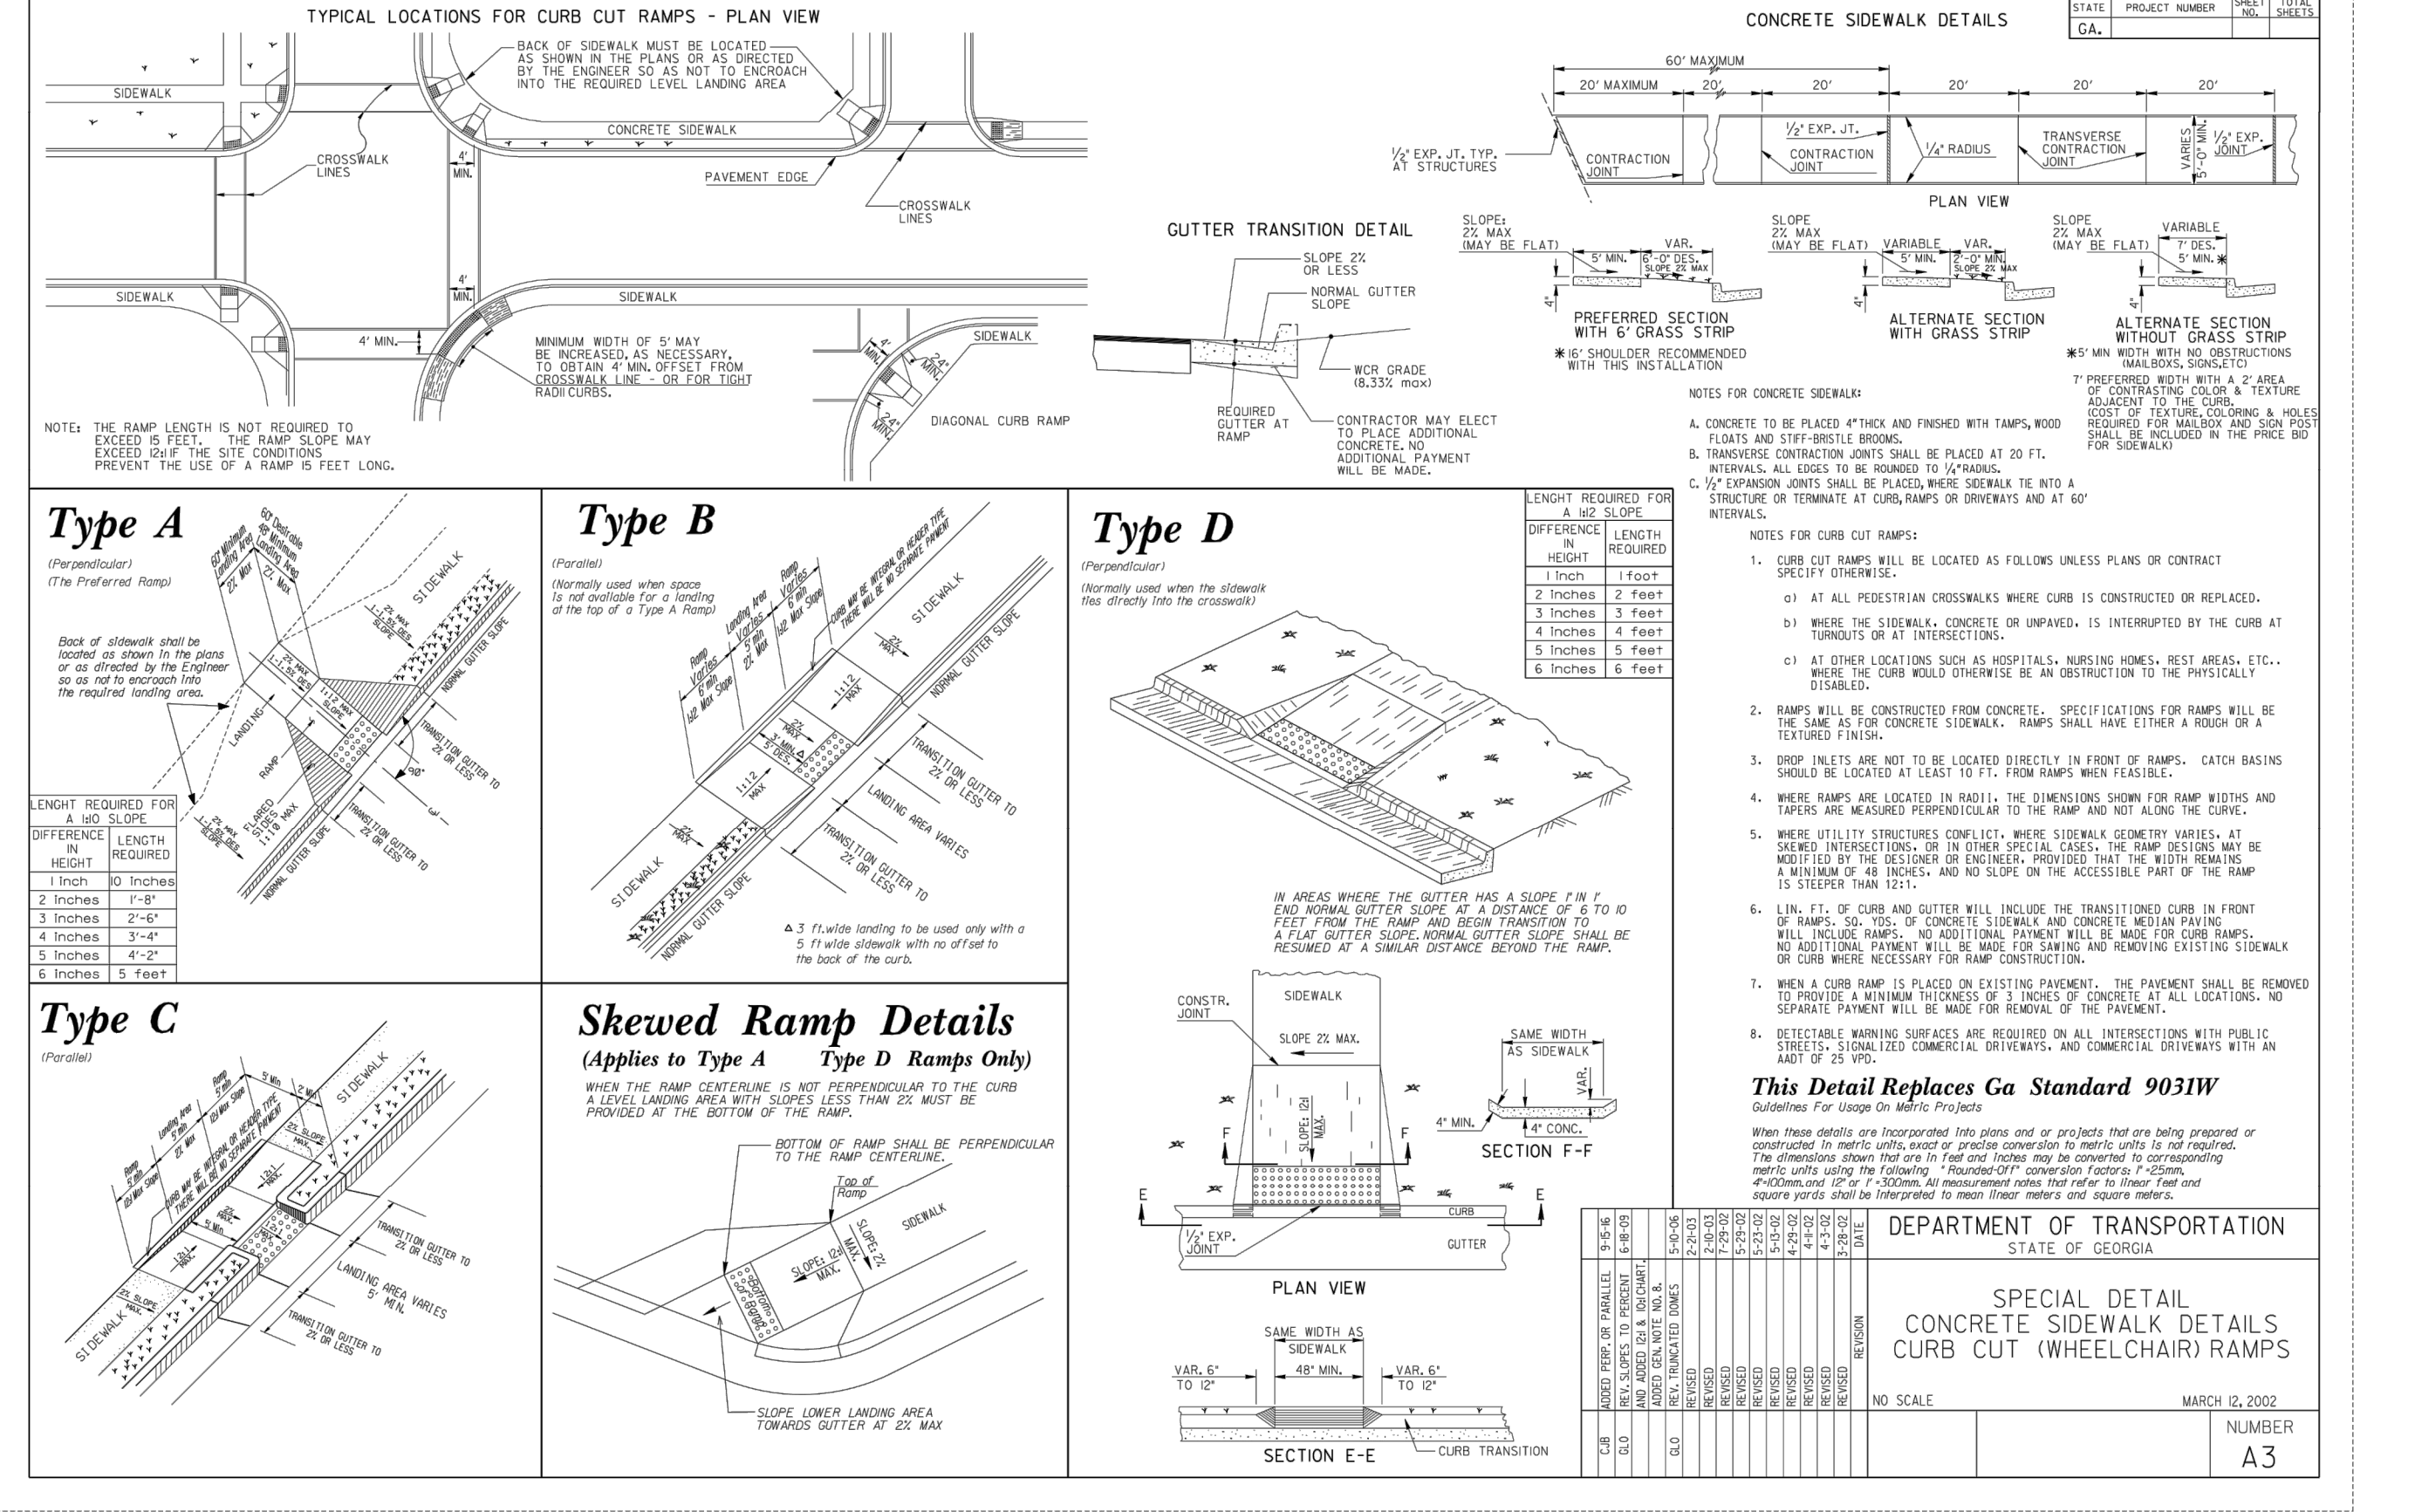
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C1 STANDARD CATCH BASIN DETAIL  
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A2 FAYETTE COUNTY WATER DETAILS  
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B1 CONCRETE SIDEWALK DETAILS  
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