

### **Purchasing Department**

140 Stonewall Avenue West, Ste 204 Fayetteville, GA 30214 Phone: 770-305-5420 www.fayettecountyga.gov

December 12, 2024

Subject: RFQ #2512-A Crabapple Booster Pump #2 Motor VFD Addendum #1

Gentlemen/Ladies:

Below, please find responses to questions, clarification, or additional information for the above referenced **RFQ**. You will need to consider this information when preparing your quote.

1. How many soft starters are there?

This is a project for installation of a single VFD for Crabapple Booster Pump #2. Both the booster pumps at Crabapple booster station have a soft start but Booster #2 is out of commission and is why we are choosing to have it upgraded to VFD.

- Can the County provide the original wiring diagrams for pump 2?See attached.
- 3. Is there an active harmonic filter required for this project? No.
- Can you please provide contact details for FCWS integrator J.K. Duren for Crabapple Booster Pump #2 Motor VFD BID#5617555?
   Jim Ham, J.K. Duren Technician, (770) 328-1058
- 5. On the Contractor affidavit under O.C.G.A page are you just looking for our FEIN# and the date it was authorized or are you looking for a different Federal#?

This is the E-Verify number. The E-Verify number is different from your FEIN number. It is a 5–7-digit number with no dashes. Yes, this should be the date that the E-Verify number was authorized.

Received by (Name): Company	
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Note: If this addendum is not returned to the Fayette County Purchasing Department or if it is returned not signed, responding individuals, companies or other organizations will still be responsible for the requirements of this addendum and the specifications or changes herein.

The opening date for this RFQ has not changed. The opening time and date are 3:00p.m., Wednesday, December 18, 2024. Quotes must be received by the Purchasing Department at the address above, Suite 204, at or before the opening date and time. Please advise that quotes can also be emailed to <a href="mailto:ccobb@fayettcountyga.gov">ccobb@fayettcountyga.gov</a> or faxed to (770) 719-5544.

The deadline for inquiries has passed, so the Purchasing Department will not be able to accept any additional questions after this time.

If you have questions, please contact Colette Cobb, Contract Administrator at (770) 305-5115, fax (770) 719-5544 or email at <a href="mailto:ccobb@fayettecountyga.gov">ccobb@fayettecountyga.gov</a>.

Sincerely,

Ted L. Burgess

Chief Procurement Officer

TLB/cc

Attachment

# CRABAPPLE BOOSTER PUMP STATION FOR FAYETTE COUNTY WATER SYSTEM

TONY V. PARROTT, MANAGER

AUTHORIZED BY:

FAYETTE COUNTY BOARD OF COMMISSIONERS

ROBERT SPRAYBERRY, CHAIRMAN SCOTT BURRELL, VICE-CHAIRMAN HAROLD BOST HERB FRADY GLEN GOSA

115-B BRADFORD PHO	Associa SQUARE FAYETTEVI NE 770-719-3333 X 770-719-3377	
	BOOSTER PUMP FOR DUNTY WATER SY	
СО	VER SHEET	
	DESIGN	SCALE
LAND LOT -	DRAWN DWJ	DATE 7-1-97
DISTRICT -	CHECK	ETI E NO

# INDEX TO DRAWINGS


SHEET NO.	DESCRIPTION	SHEET NO.	DESCRIPTION	SHEET NO.	DESCRIPTION
1	COVER SHEET	12	BOOSTER PUMP STATION LEGENDS & SITE PLAN (E-1)	20	S.R. 54 W.L. RELOCATION PLAN AND SECTIONS
2	INDEX TO DRAWINGS, LOCATION MAP & NOTES	13	BOOSTER PUMP STATION SINGLE LINE DIAGRAM (E-2)	21	S.R. 54 W.L. RELOCATION PLAN AND SECTIONS
3	BOOSTER PUMP STATION SITE PLAN	14	BOOSTER PUMP STATION SCHEMATIC DIAGRAMS (E-3)		
4	HIGHWAY CROSSING & PIPING MODIFICATIONS	15	BOOSTER PUMP STATION POWER & LIGHTING PLAN (E-4)	22	BIRKDALE DRIVE AERIAL CREEK CROSSING
5	BOOSTER PUMP STATION PLAN & SECTIONS (P-1)				
6	BOOSTER PUMP STATION FLOOR & ROOF PLAN (A-1)	16	CRABAPPLE LANE W.L. RELOCATION PLAN AND PROFILES	23	DETAIL SHEET
7	BOOSTER PUMP STATION EXTERIOR ELEVATIONS (A-2)	17	CRABAPPLE LANE W.L. RELOCATION PLAN AND PROFILES	24	DETAIL SHEET
8	BOOSTER PUMP STATION BUILDING SECTIONS (A-3)	.18	CRABAPPLE LANE W.L. RELOCATION PLAN AND PROFILES		
9	BOOSTER PUMP STATION DETAILS (A-4)				
10	BOOSTER PUMP STATION FOUNDATION PLAN (S-1)	19	PRV PIT @ S.R. 54		
11	BOOSTER PUMP STATION CRANE SUPPORT PLAN (S-2)				

# GENERAL NOTE

- ALL CONSTRUCTION TO BE IN ACCORDANCE WITH GEORGIA DEPARTMENT
   OF TRANSPORTATION, PEACHTREE CITY, AND FAYETTE COUNTY
   STANDARDS AND SPECIFICATIONS.
- 2. ANY EXISTING UTILITIES SHOWN ARE APPROXIMATE AND DO NOT NECESSARILY REPRESENT ALL EXISTING UTILITIES. CONTRACTOR TO VERIFY LOCATION OF ALL EXISTING UTILITIES PRIOR TO BEGINNING CONSTRUCTION. ANY DAMAGED UTILITIES SHALL BE REPAIRED AT NO ADDITIONAL COST TO FAYETTE COUNTY WATER SYSTEM. NO COMPENSATION WILL BE MADE FOR DELAYS DUE TO EXISTING UTILITIES.
- 3. ALL TIE-INS TO BE COORDINATED WITH FAYETTE COUNTY WATER SYSTEM. SCHEDULING FOR TIE-INS TO BE DETERMINED BY FAYETTE COUNTY WATER SYSTEM. CONTACT MR. TONY PARROTT AT 461-1146
- 4. ALL EXISTING VALVES TO BE OPENED AND CLOSED BY FAYETTE COUNTY WATER SYSTEM EMPLOYEES ONLY.
- 5. ALL WATER LINE TO BE MINIMUM PRESSURE CLASS 300 CEMENT MORTAR LINED, PUSH-ON JOINT, DUCTILE IRON PIPE PER ANSI C151/A21.51.
  ALL BURIED FITTINGS TO BE MECHANICAL JOINT, DUCTILE IRON.
  RESTRAINED JOINT PIPE SHALL BE USED WHERE SPECIFICALLY CALLED FOR ON THE DRAWINGS. INTERIOR PIPING, FITTINGS AND FLANGES SHALL BE FLANGED, DUCTILE IRION, IN ACCORDANCE WITH ANSI
- PORTIONS OF THIS PROJECT ARE UNDER THE JURISDICTION OF THE GEORGIA DEPARTMENT OF TRANSPORTATION. CONTRACTOR TO CONFORM TO ALL REGULATIONS OF THE GEORGIA DEPARTMENT OF TRANSPORTATION.
- CONTRACTOR IS ADVISED TO VISIT THE PROPOSED WATER ROUTE IN ORDER TO FAMILIARIZE HIMSELF WITH FIELD CONDITIONS, UTILITY LOCATIONS, AND AREAS OF POSSIBLE ROCK EXCAVATION.
- 8. THE CONTRACTOR SHALL CONFORM TO ALL APPLICABLE GEORGIA DEPARTMENT OF TRANSPORTATION, FAYETTE COUNTY, PEACHTREE CITY, DEPT. OF NATURAL RESOURCES AND U.S. ARMY CORPS OF ENGINEERS SEDIMENT AND EROSION CONTROL MEASURES IN THE PERFORMANCE OF THE INDICATED WORK.
- DRIVEWAYS DESIGNATED AS "GRAVEL" WHICH HAVE BEEN PAVED PRIOR TO WATER LINE INSTALLATION SHALL BE FREE-BORED (NO CASING) AT NO ADDITIONAL COST.

- 10. CONTRACTOR SHALL PRESERVE, REPAIR AND/OR REPLACE ALL PROPERTY PINS, SIGNS, DRIVEWAYS, MAILBOXES, CULVERTS, GRASSING, FENCES, LANDSCAPING, SOD, AND MISC. PLANTINGS OR STRUCTURES SUCH THAT THE DISTURBED AREAS ARE RETURNED TO THEIR ORIGINAL CONDITION OR BETTER. THIS SHALL BE DONE AT NO ADDITIONAL COST.
- 11. PORTIONS OF THIS PROJECT MAY REQUIRE CLEARING AND GRUBBING. NO ADDITIONAL CONTRACT TIME OR ADDITIONAL PAYMENT WILL BE MADE TO MEET THIS REQUIREMENT. ALL TIMBER, BRUSH AND DEBRIS RESULTING FROM CLEARING SHALL BE REMOVED FROM THE SITE AT NO ADDITIONAL COST TO THE CONTRACT.
- NO ADDITIONAL COMPENSATION WILL BE PAID FOR EQUIPMENT, MATERIALS AND LABOR REQUIRED FOR PRESSURE TESTING.
- CONTRACTOR SHALL MAINTAIN ACCESS TO ALL RESIDENTIAL AND COMMERCIAL PROPERTIES THROUGHOUT THE WORK.
- 14. CONTRACTOR SHALL COORDINATE WITH GEORGIA POWER COMPANY AND/OR COWETA-FAYETTE EMC FOR TEMPORARY POWER POLE SUPPORT IN AREAS WHERE GUY WIRES CONFLICT WITH WATER LINE INSTALLATION. THIS WILL BE DONE AT NO ADDITIONAL COST.
- 15. CONTRACTOR SHALL COORDINATE WITH GEORGIA POWER COMPANY AND/OR COWETA-FAYETTE EMC FOR SHIELDING OF POWER LINES AND/OR TEMPORARY REMOVAL AND REPLACEMENT OF OVERHEAD LINES OR POLES WHICH MAY CONFLICT WITH PIPE INSTALLATION. THIS SHALL BE DONE AT NO ADDITIONAL COST.
- 16. EROSION CONTROL WILL BE STRICTLY ENFORCED THROUGHOUT THE WORK.
  CONTRACTOR SHALL SUPPLY AND INSTALL SILTING FENCING, HAY
  BALES, MULCH MATS, SLOPE STABILIZATION FABRIC, RIP-RAP,
  TEMPORARY AND PERMANENT GRASSING AS REQUIRED TO PREVENT
  EROSION UNTIL PERMANENT GRASSING HAS BEEN FULLY ESTABLISHED.
  ALL EROSION CONTROL MEASURES SHALL BE MAINTAINED, REINSTALLED
  OR RESEEDED AS DIRECTLY BY THE ENGINEER. COST FOR EROSION
  CONTROL REQUIREMENTS SHALL BE INCLUDED IN THE UNIT PRICE BID
  FOR SIZE AND CLASS OF PIPE.
- 17. FINAL GRADING SHALL BE DONE BY LANDSCAPE TRACTOR OR BY SIMILAR EQUIPMENT TO PROVIDE A SMOOTH, UNIFORM SURFACE FREE OF ROCKS, DIRT CLODS, AND OTHER DEBRIS. NO ADDITIONAL PAYMENT WILL BE MADE TO MEET THIS REQUIREMENT.

# LOCATION MAP

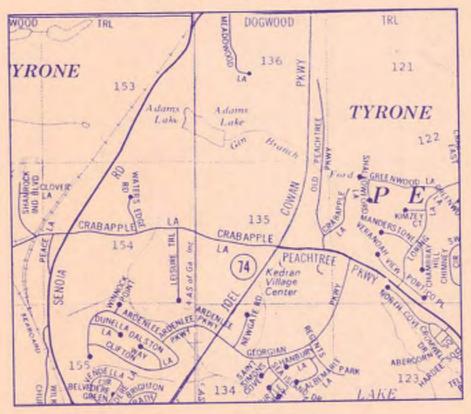

1" = 2000'

Mallett & Associates, Inc.


115-B BRADFORD SQUARE FAYETTEVILLE, GEORGIA 30215


PHONE: 770-719-3333
FAX: 770-719-3377


CRABAPPLE BOOSTER PUMP STATION
FOR
FAYETTE COUNTY WATER SYSTEM


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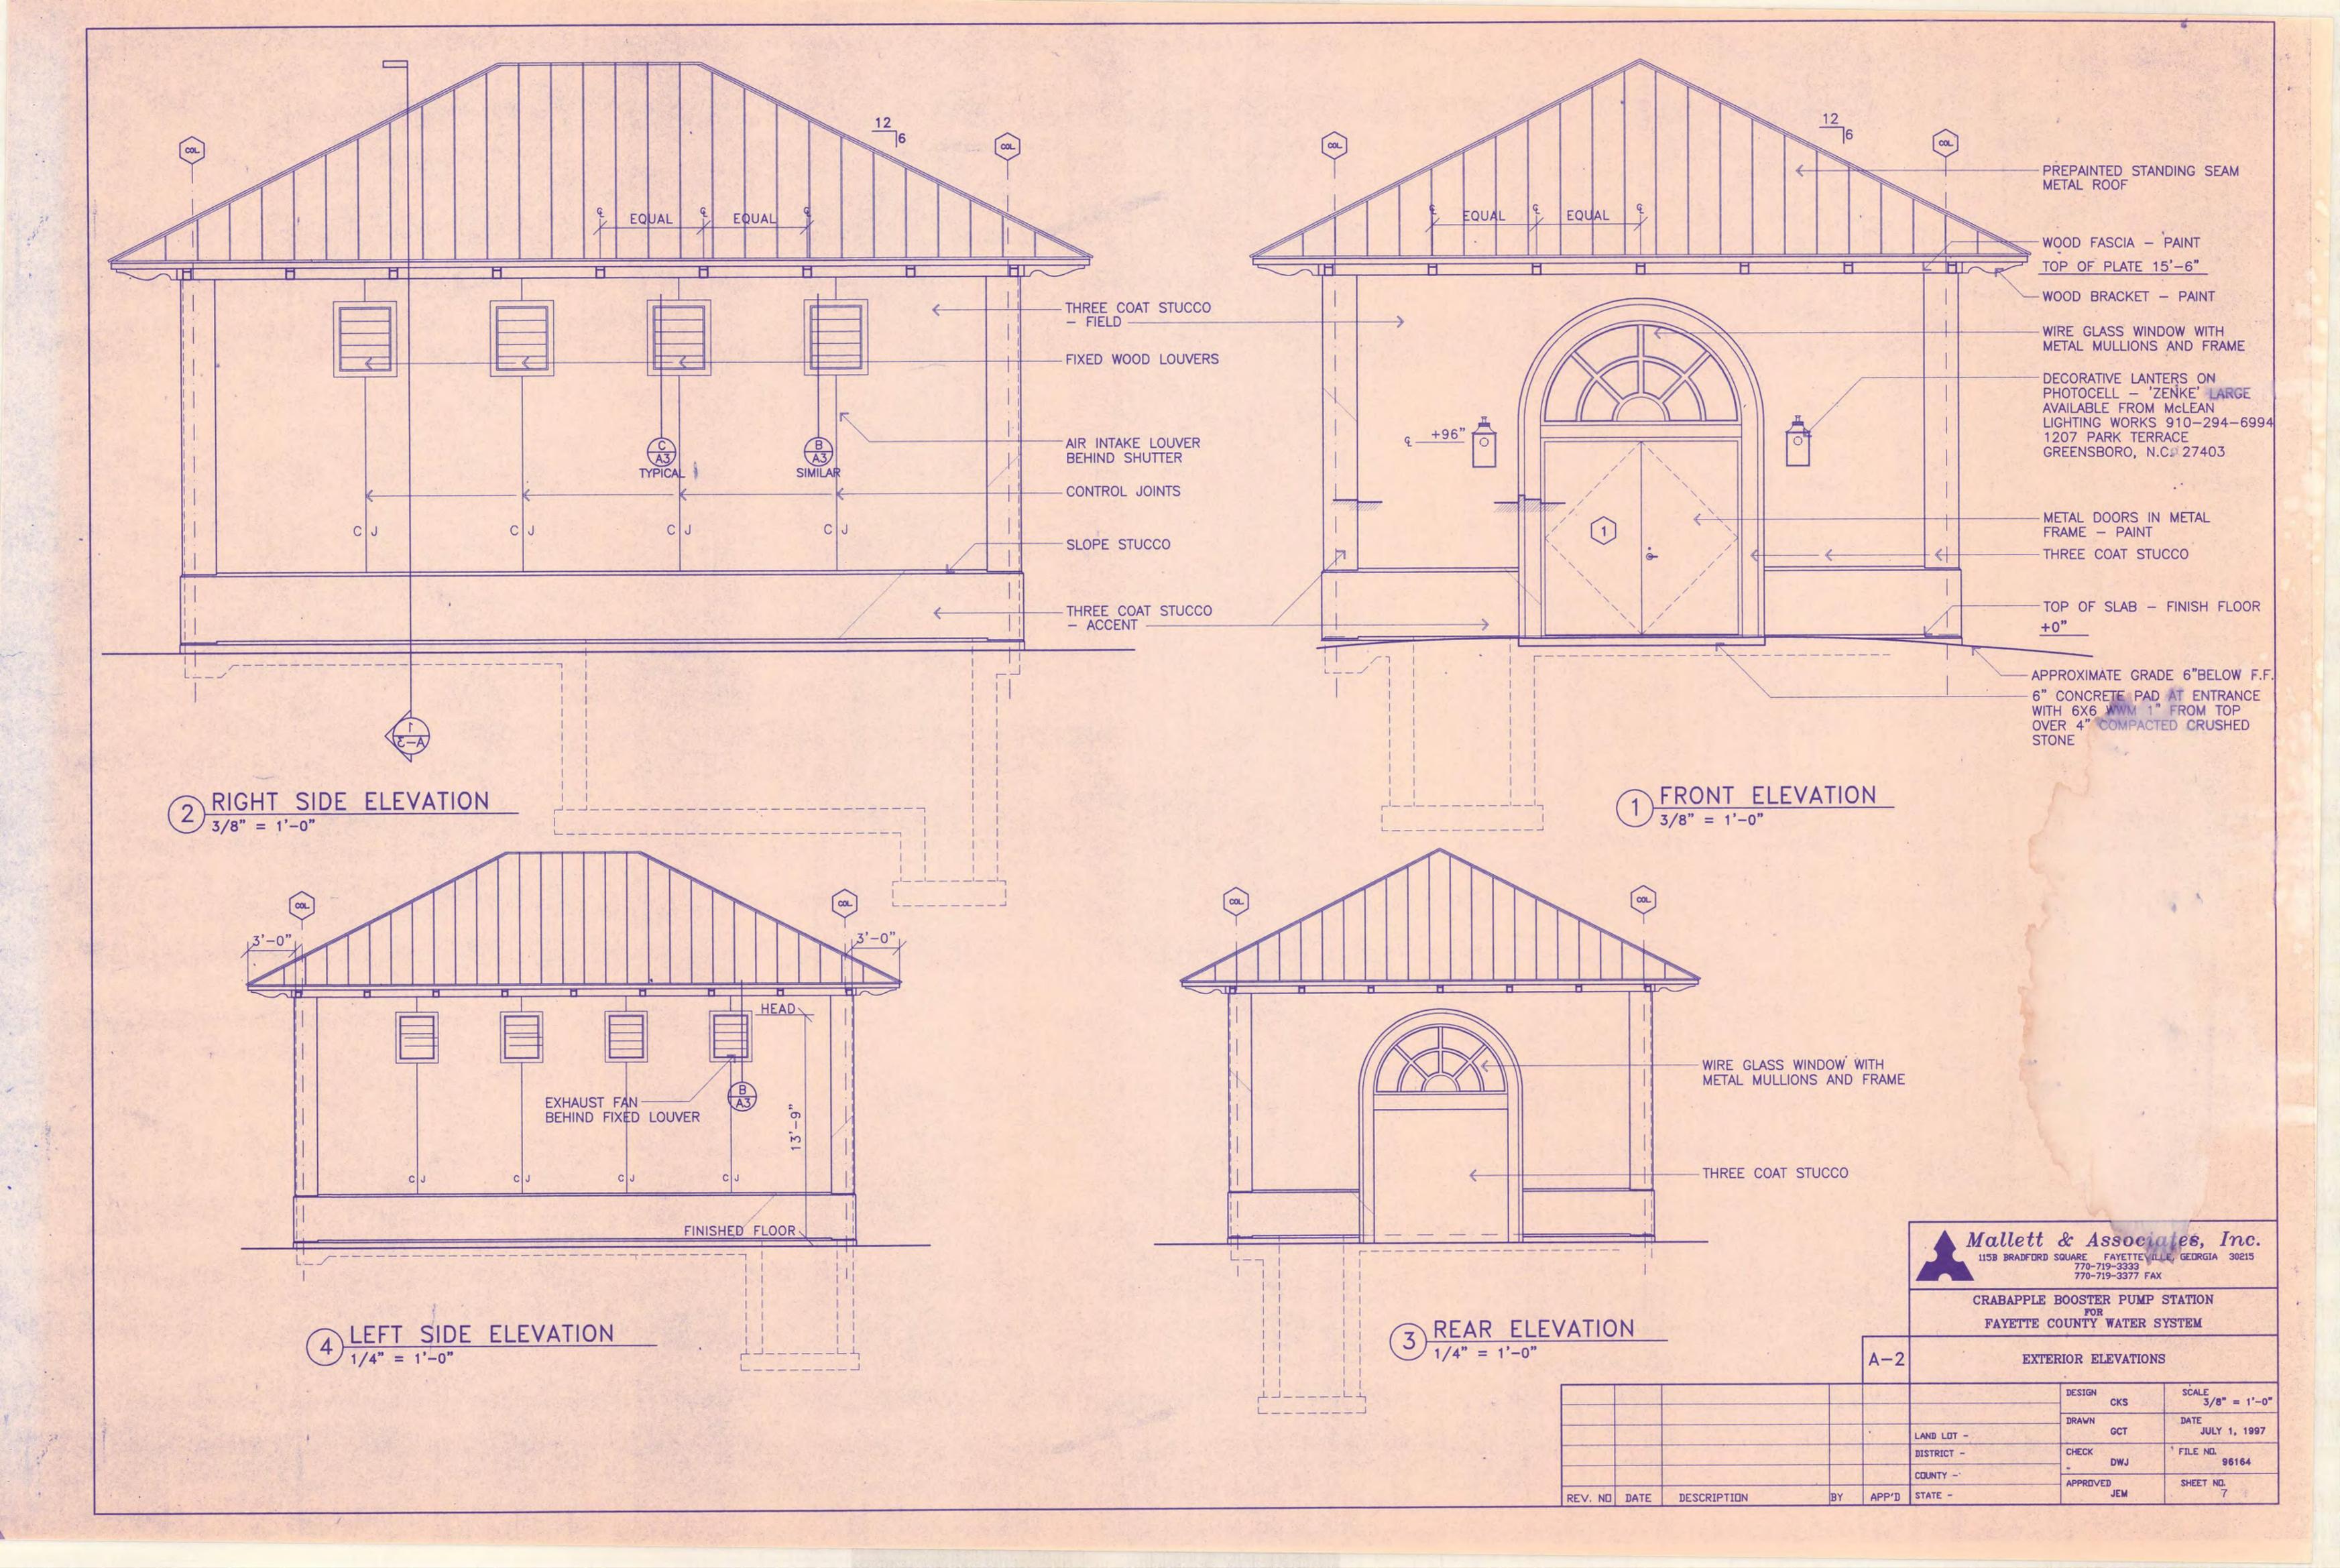
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					COUNTY -	APPROVED		SHEET NO. 2
REV. No.	DATE	DESCRIPTION	BY	APP'D	STATE -		JEM	2




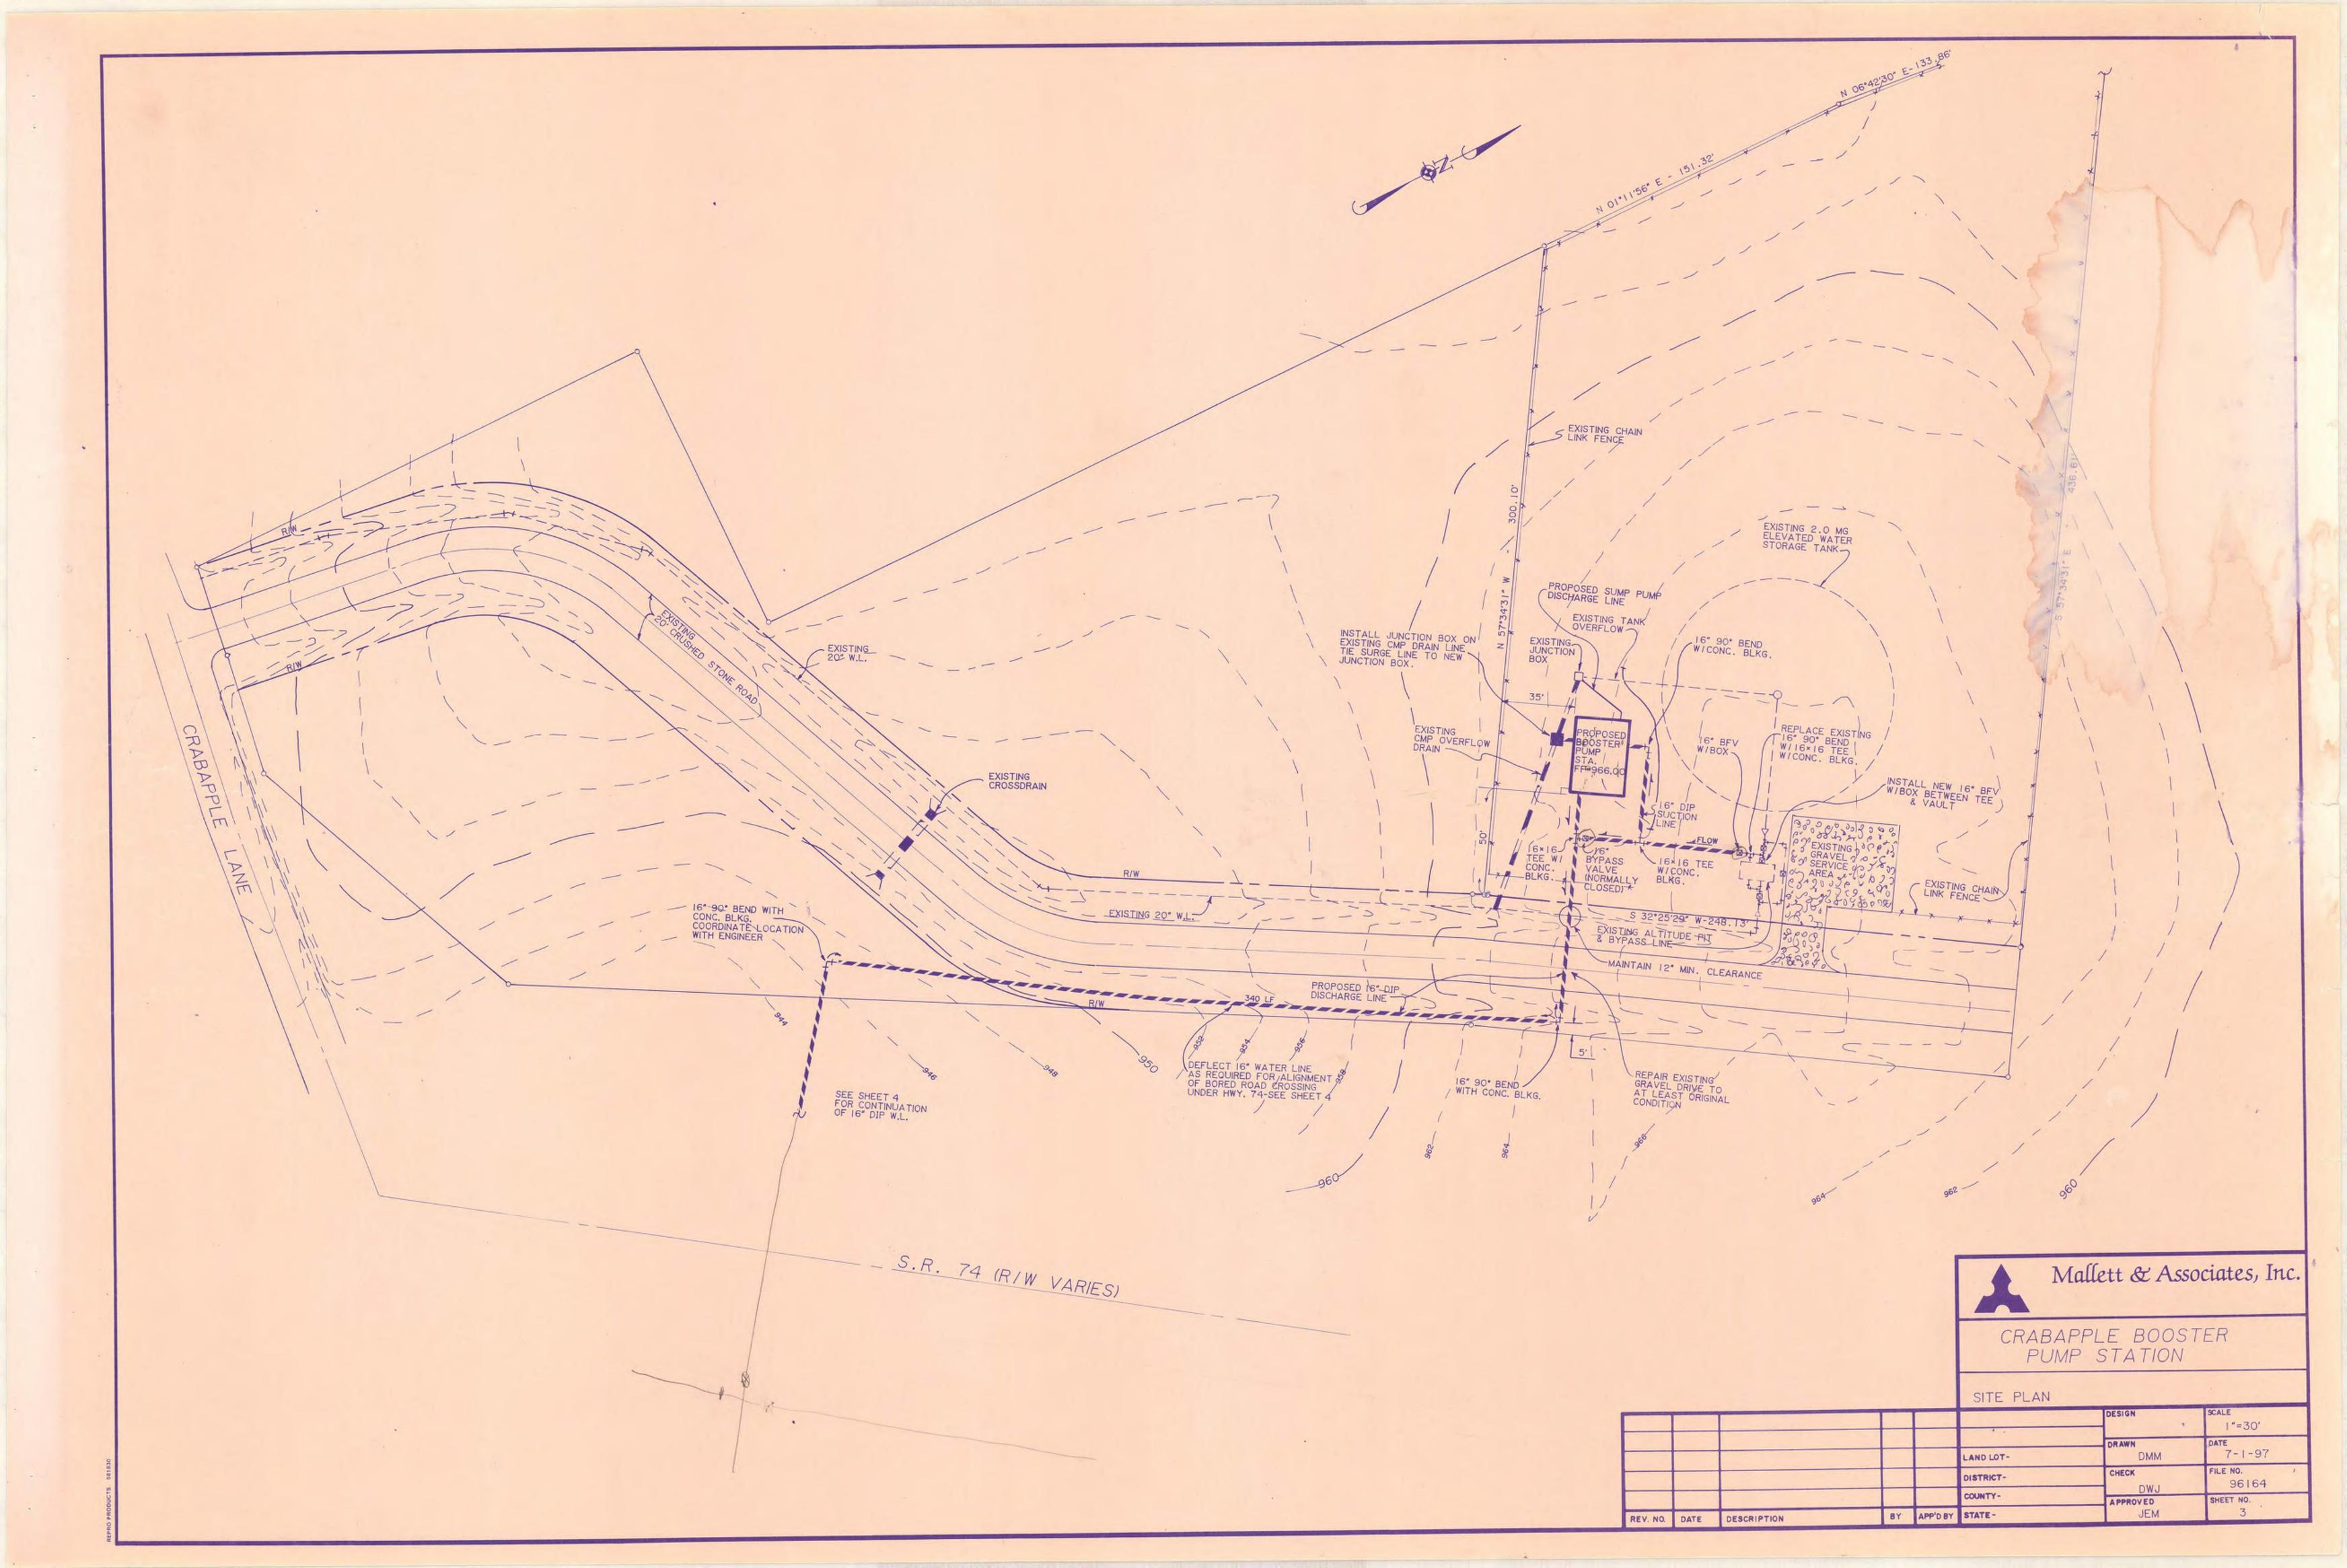


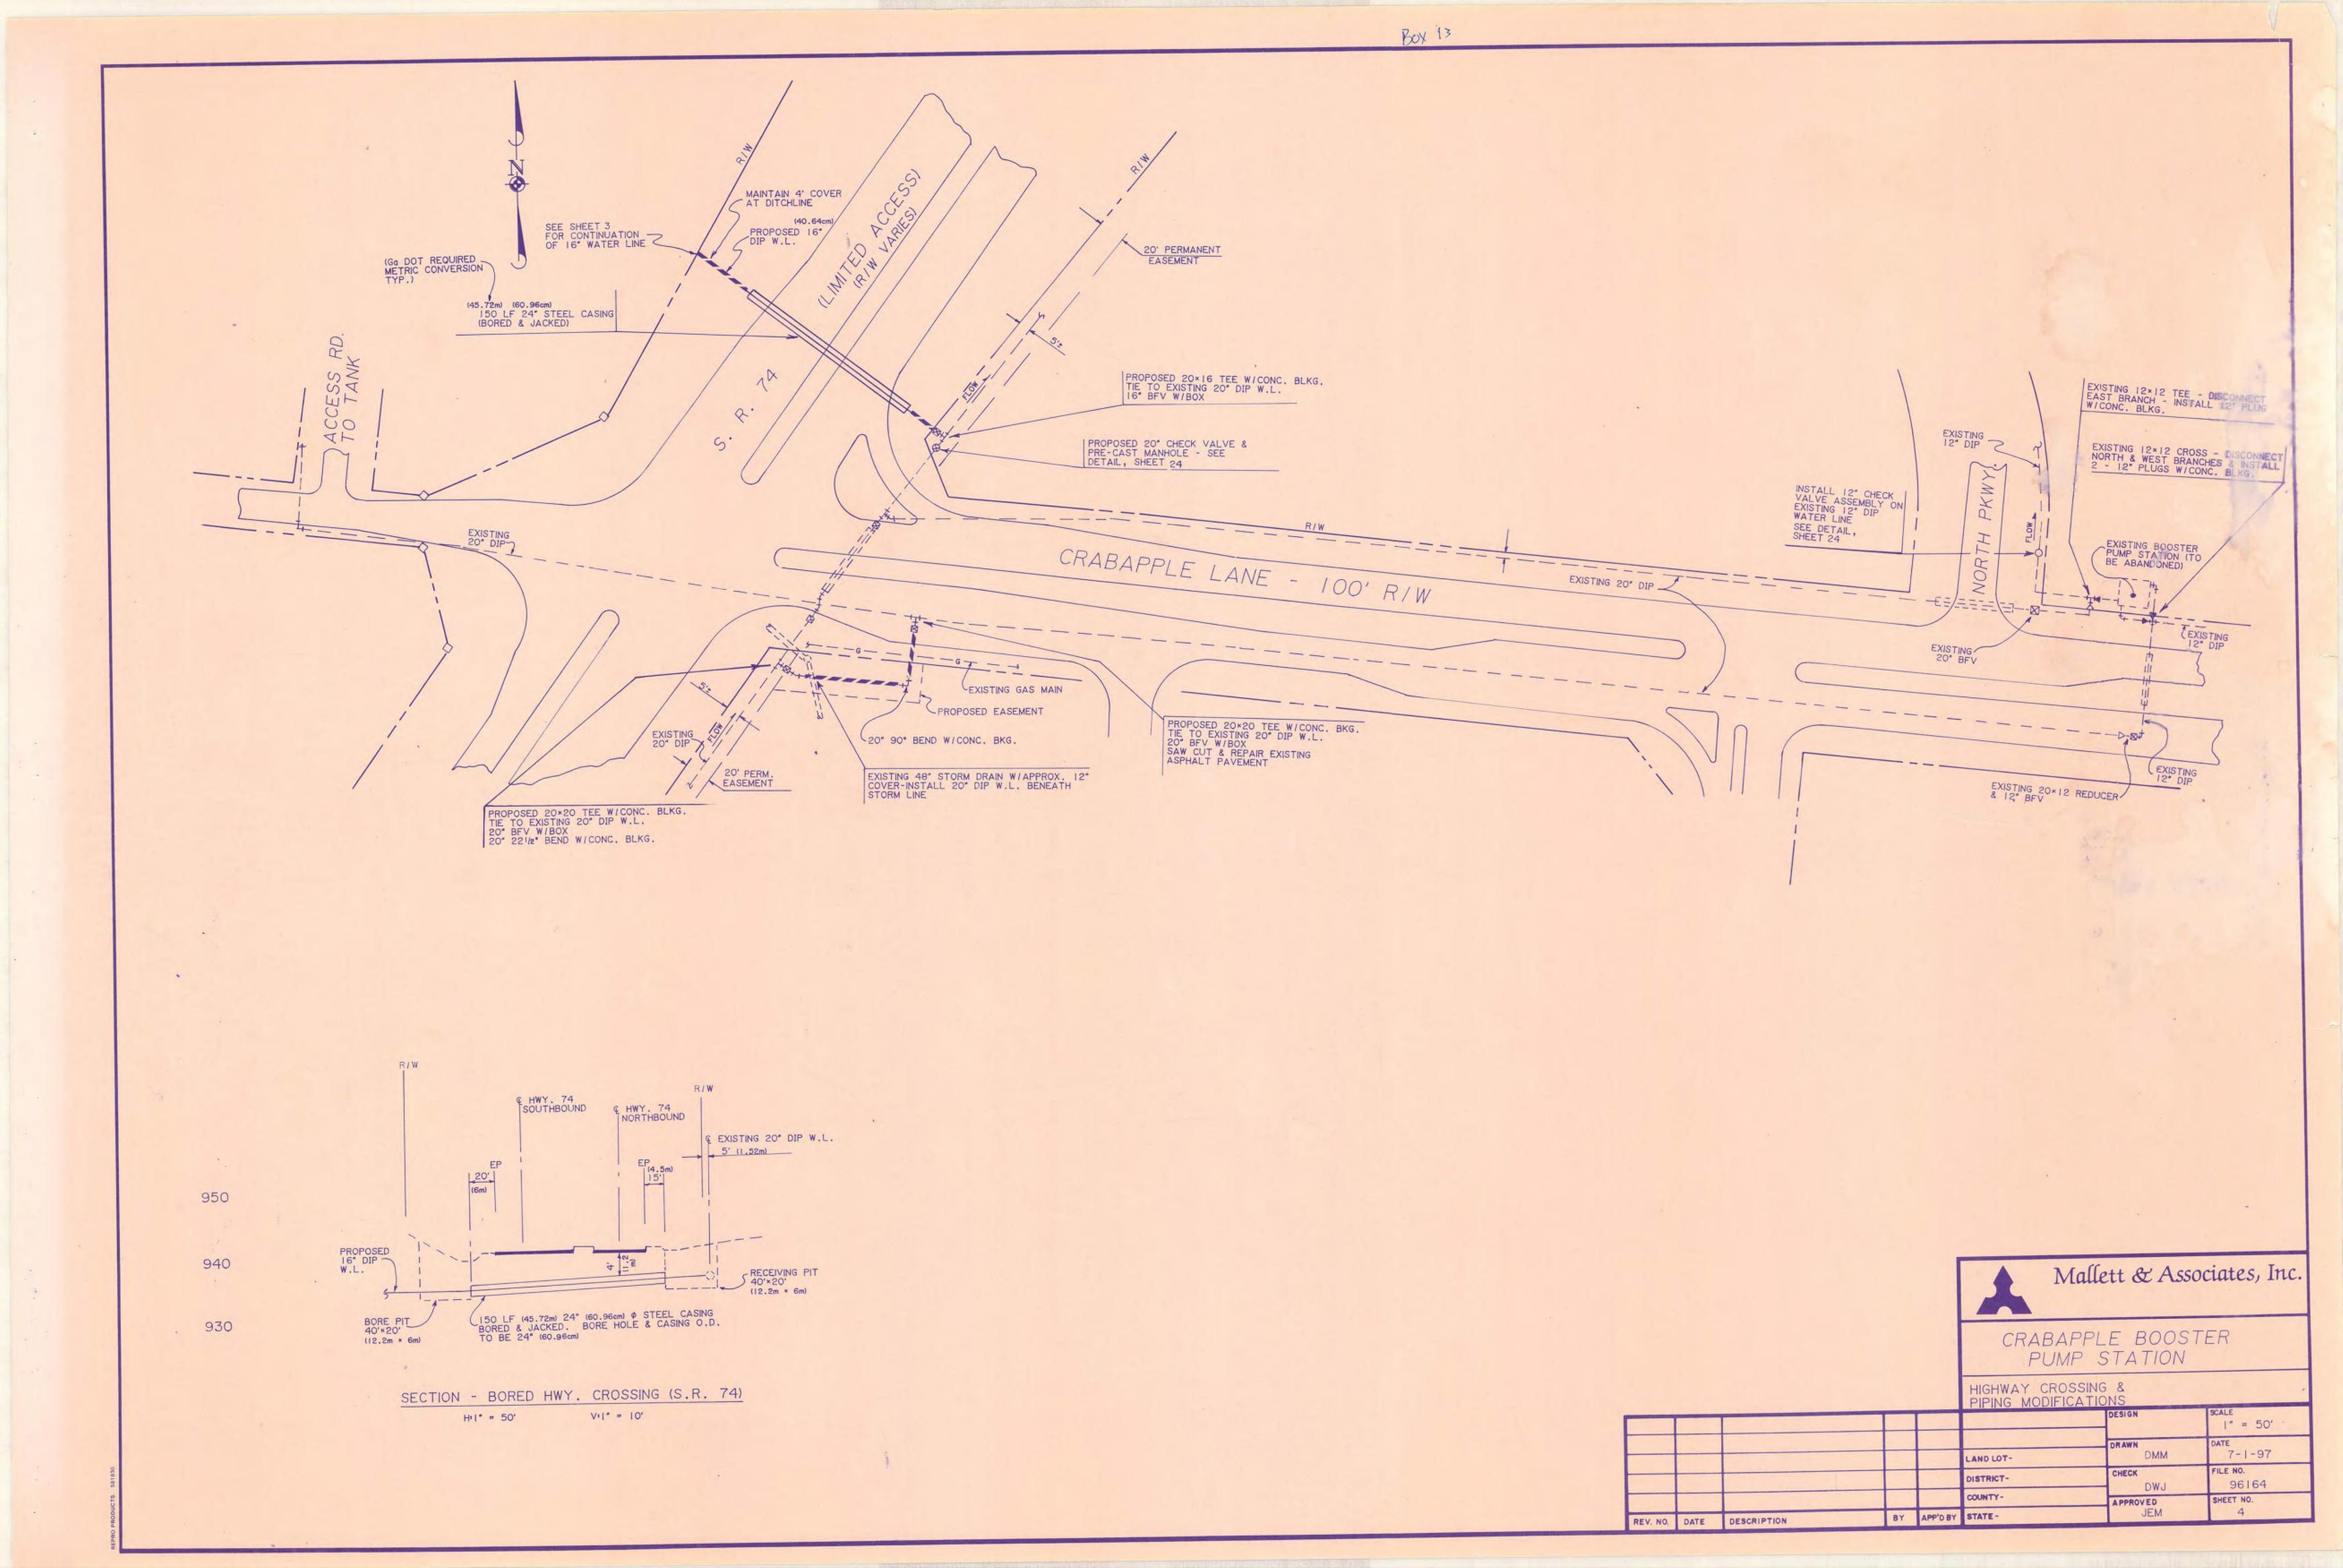


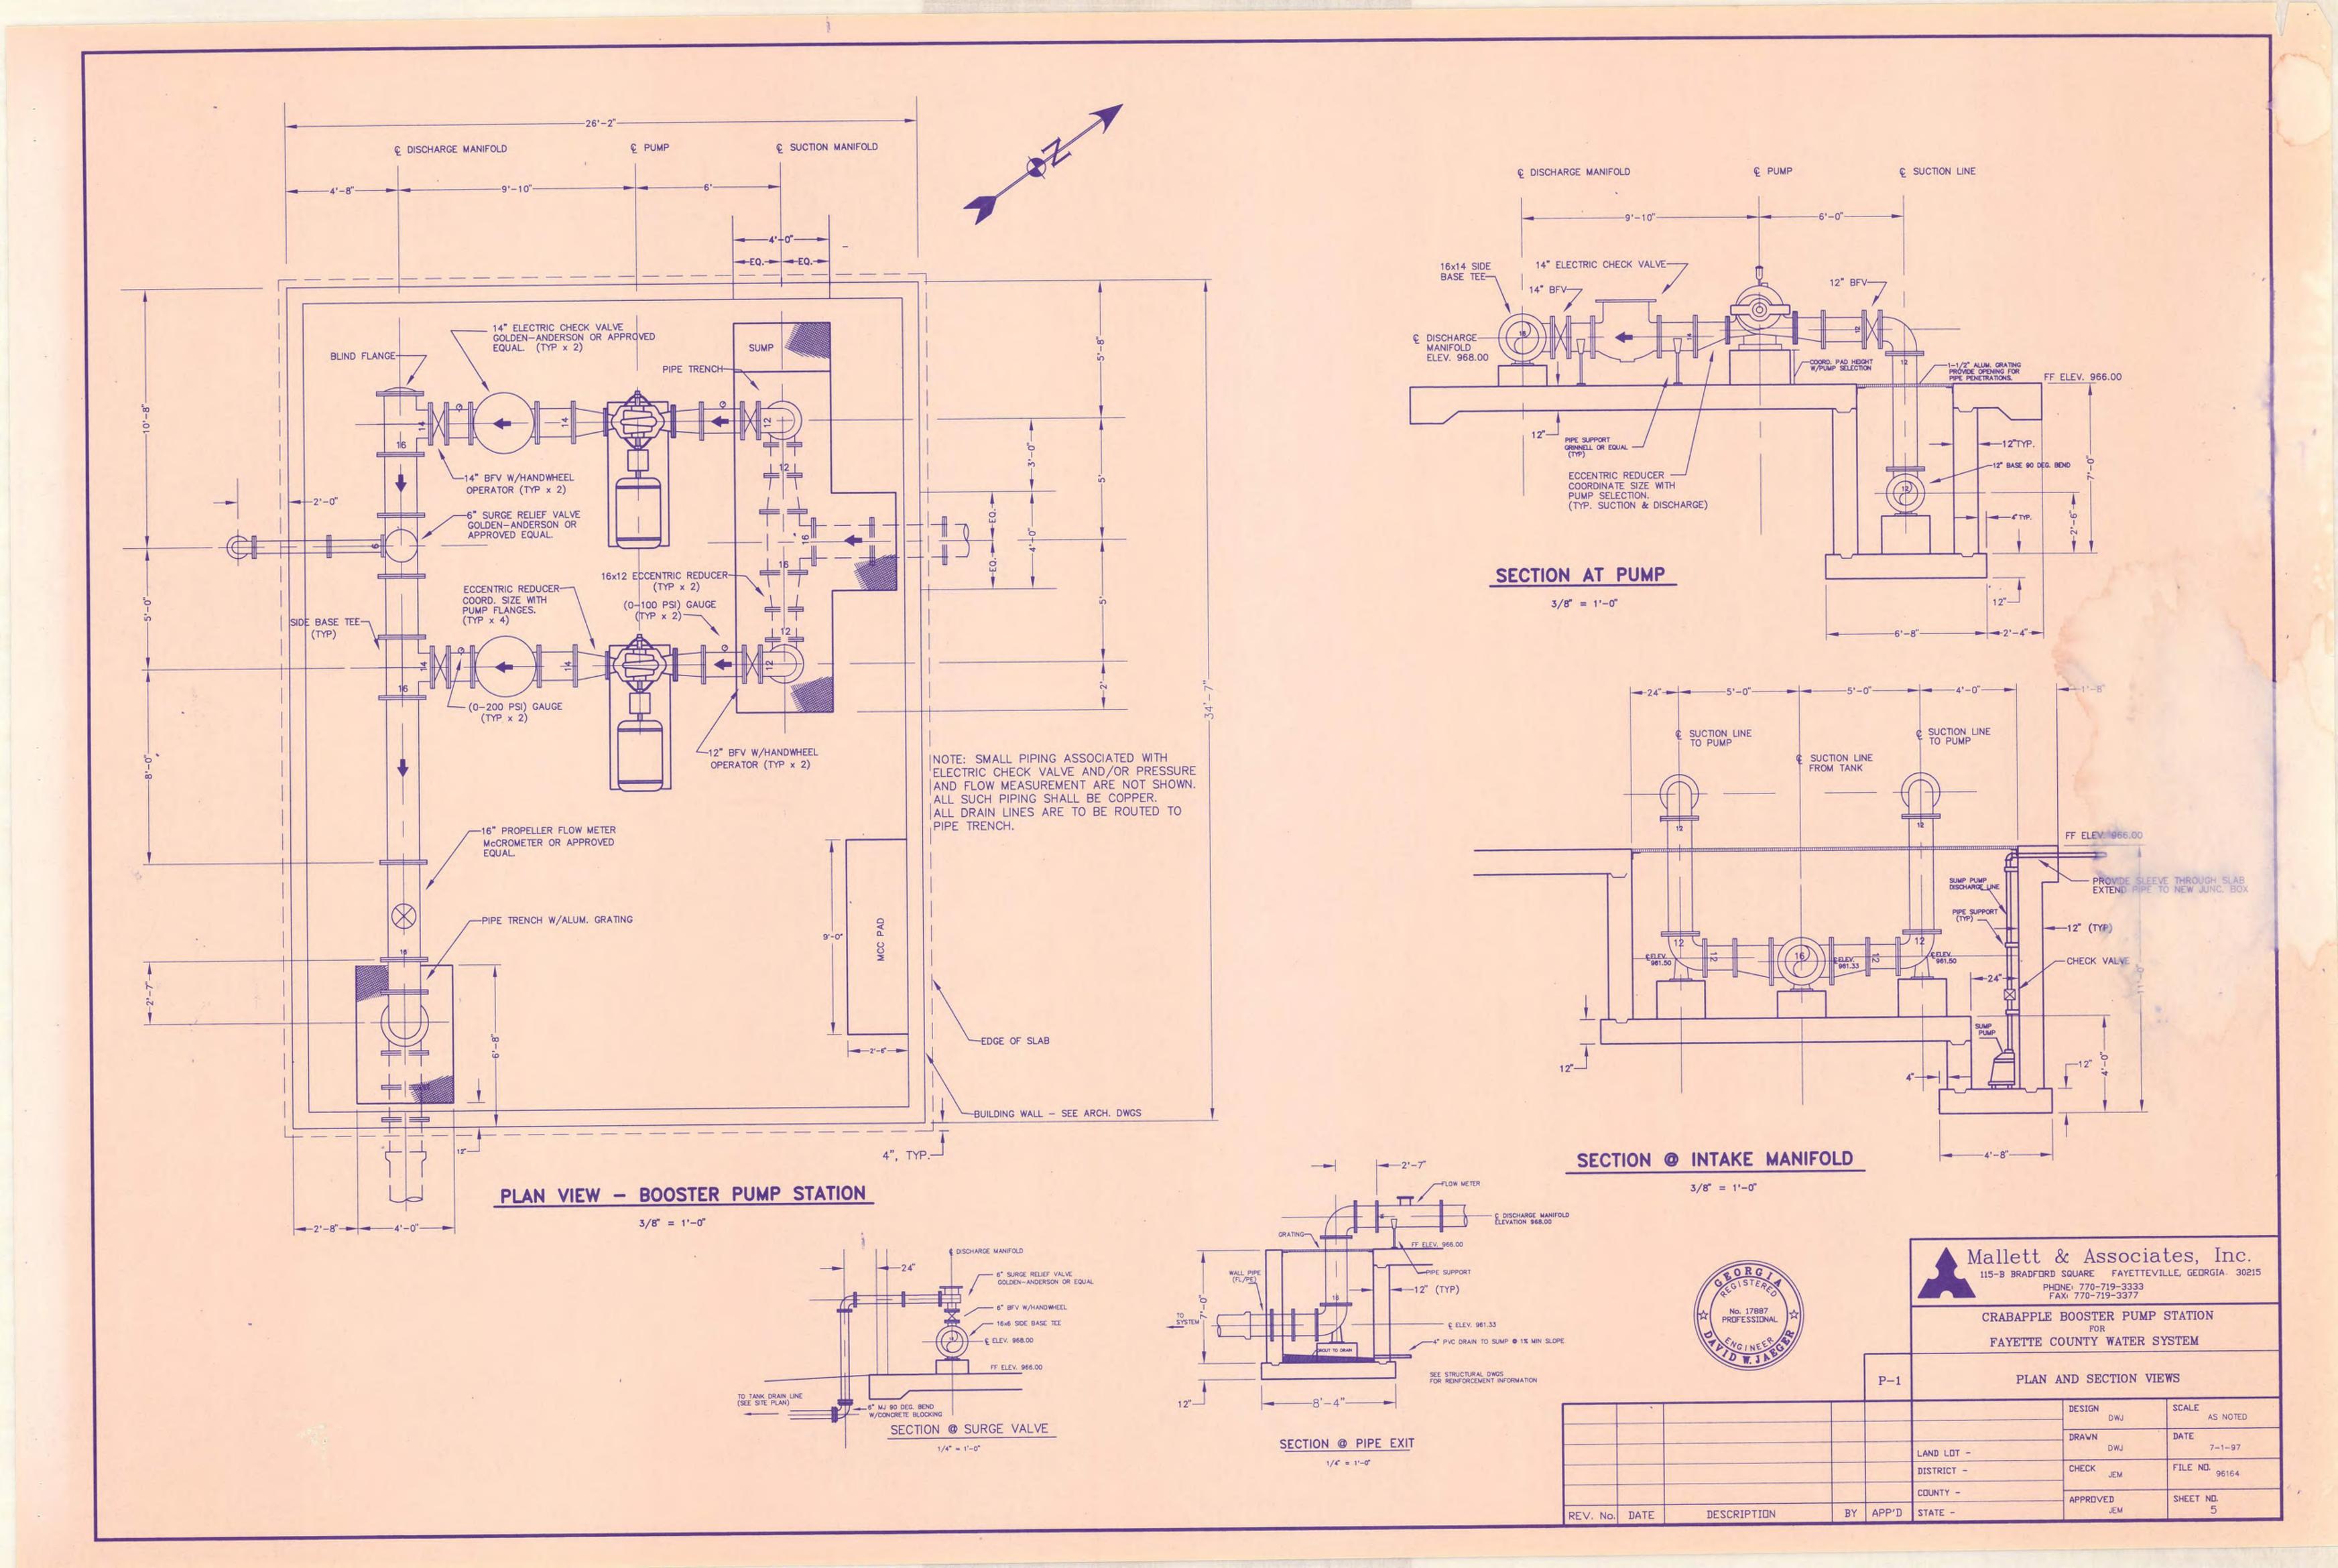


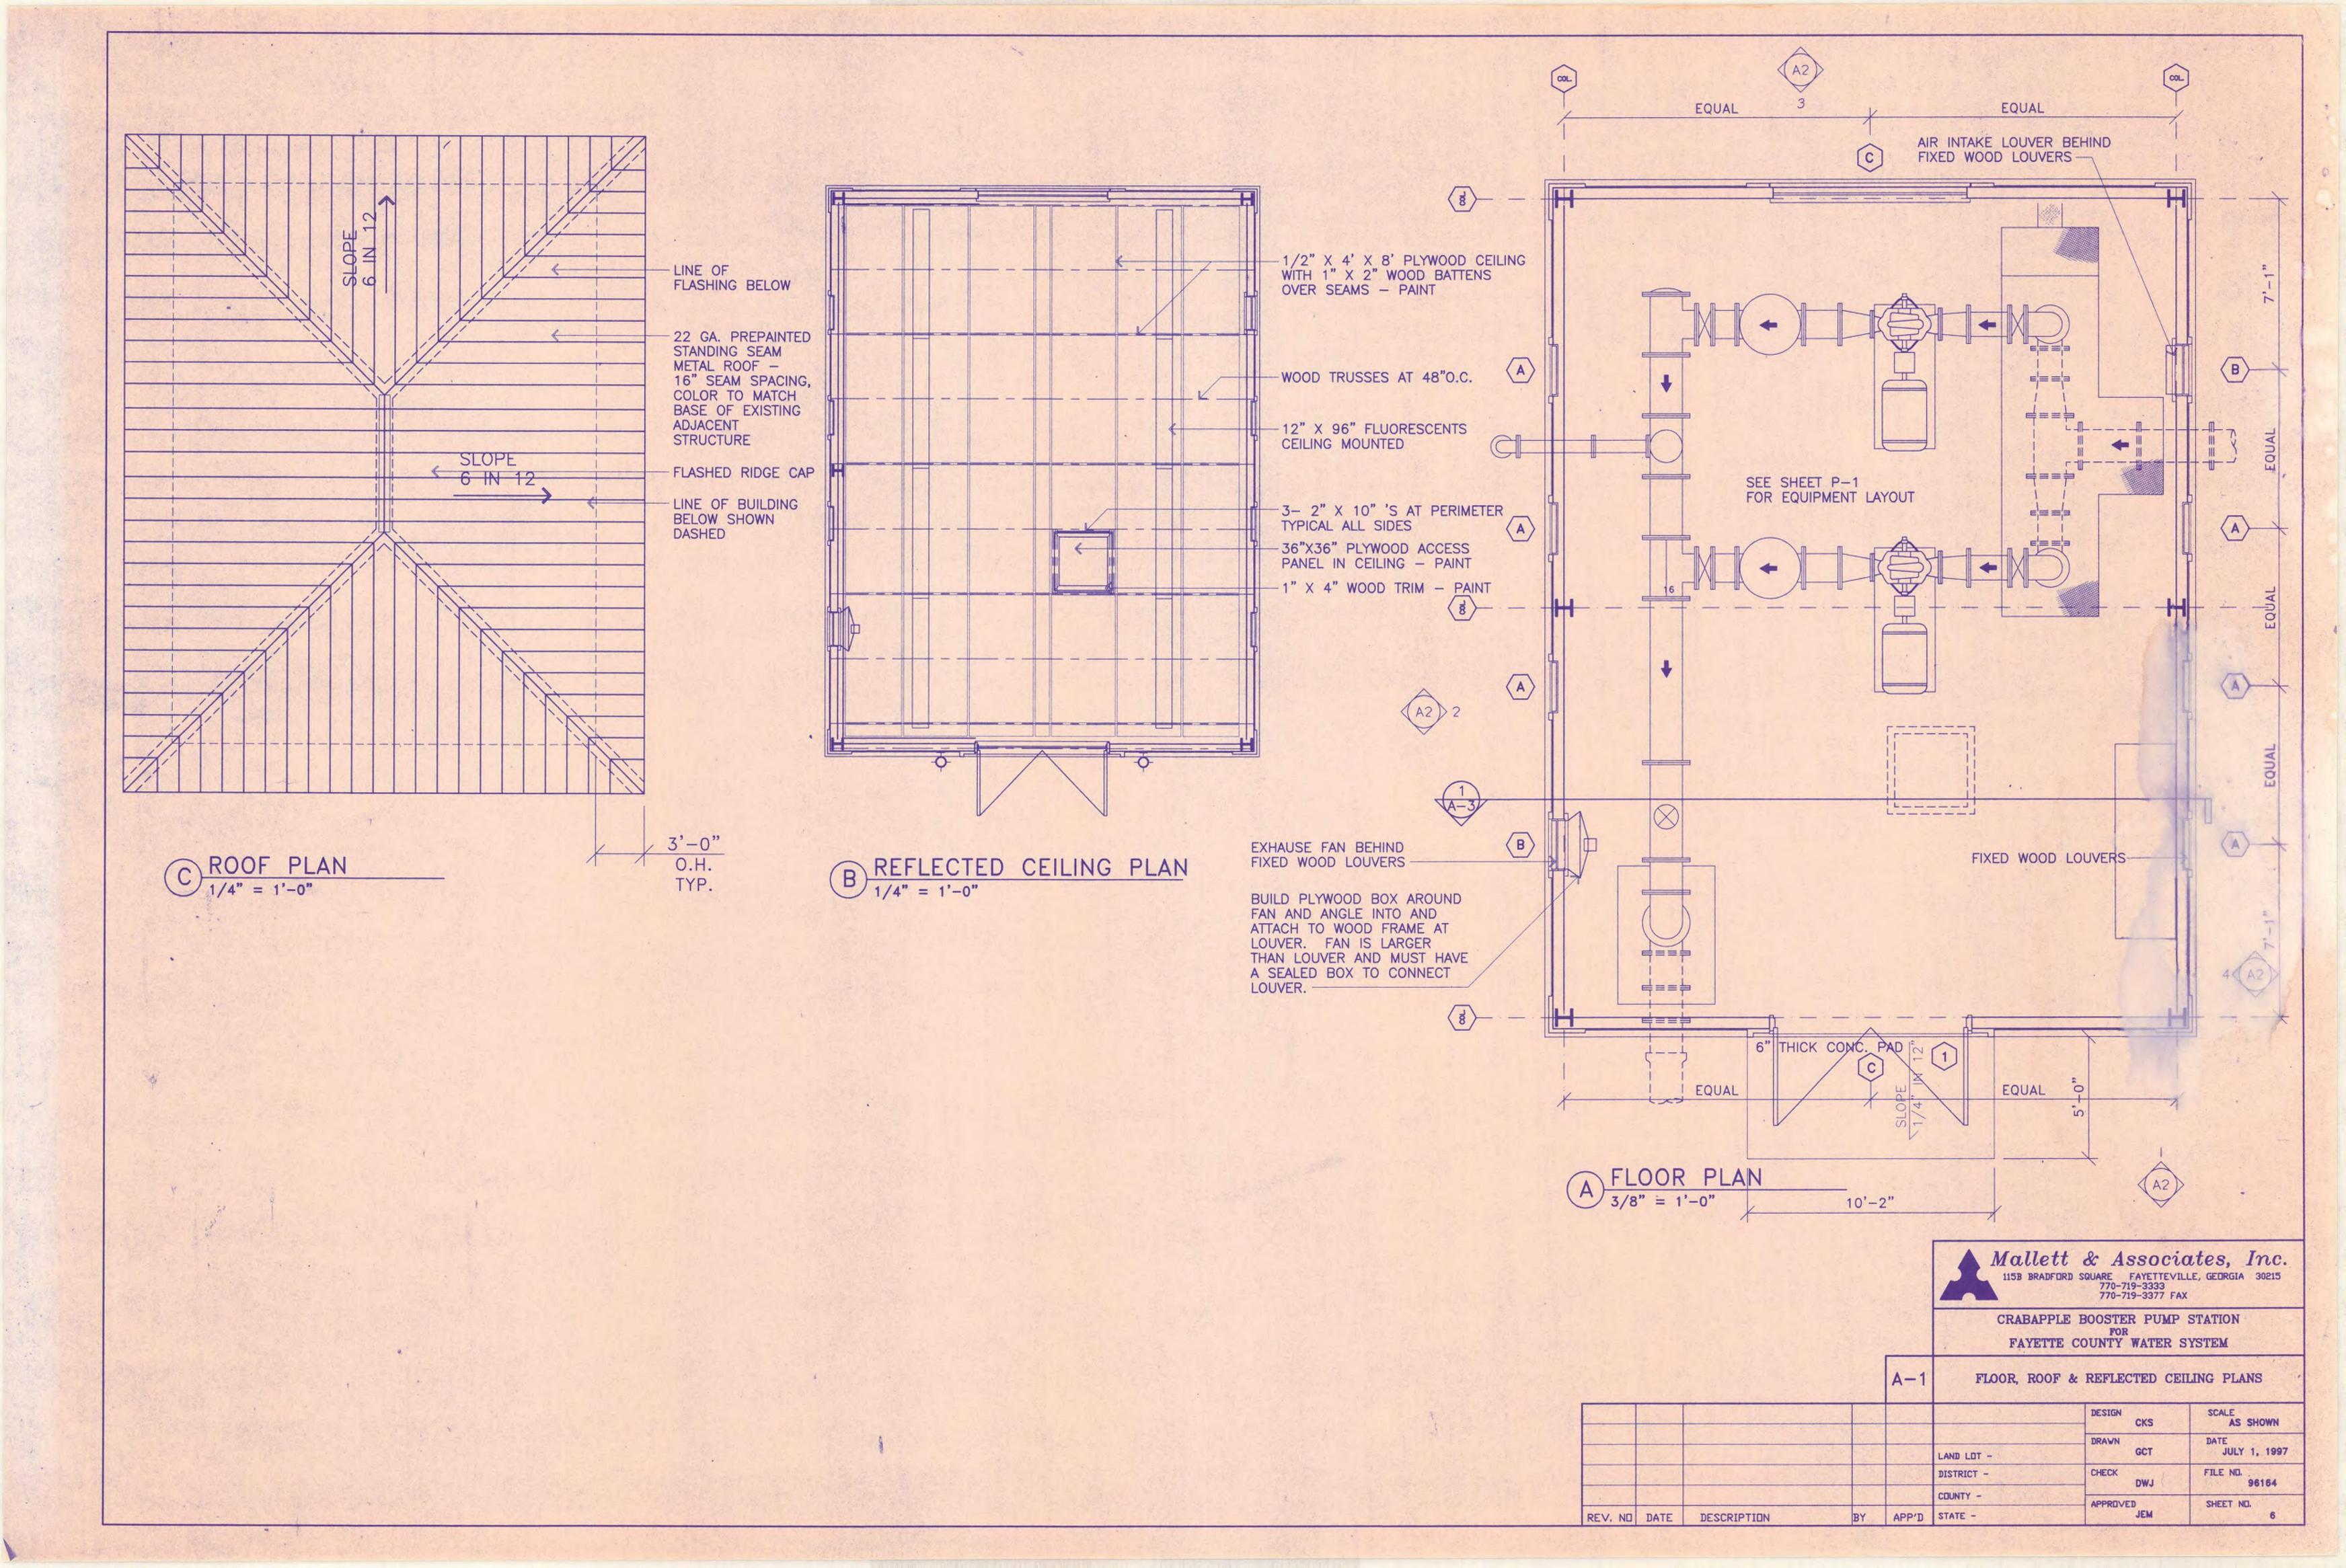

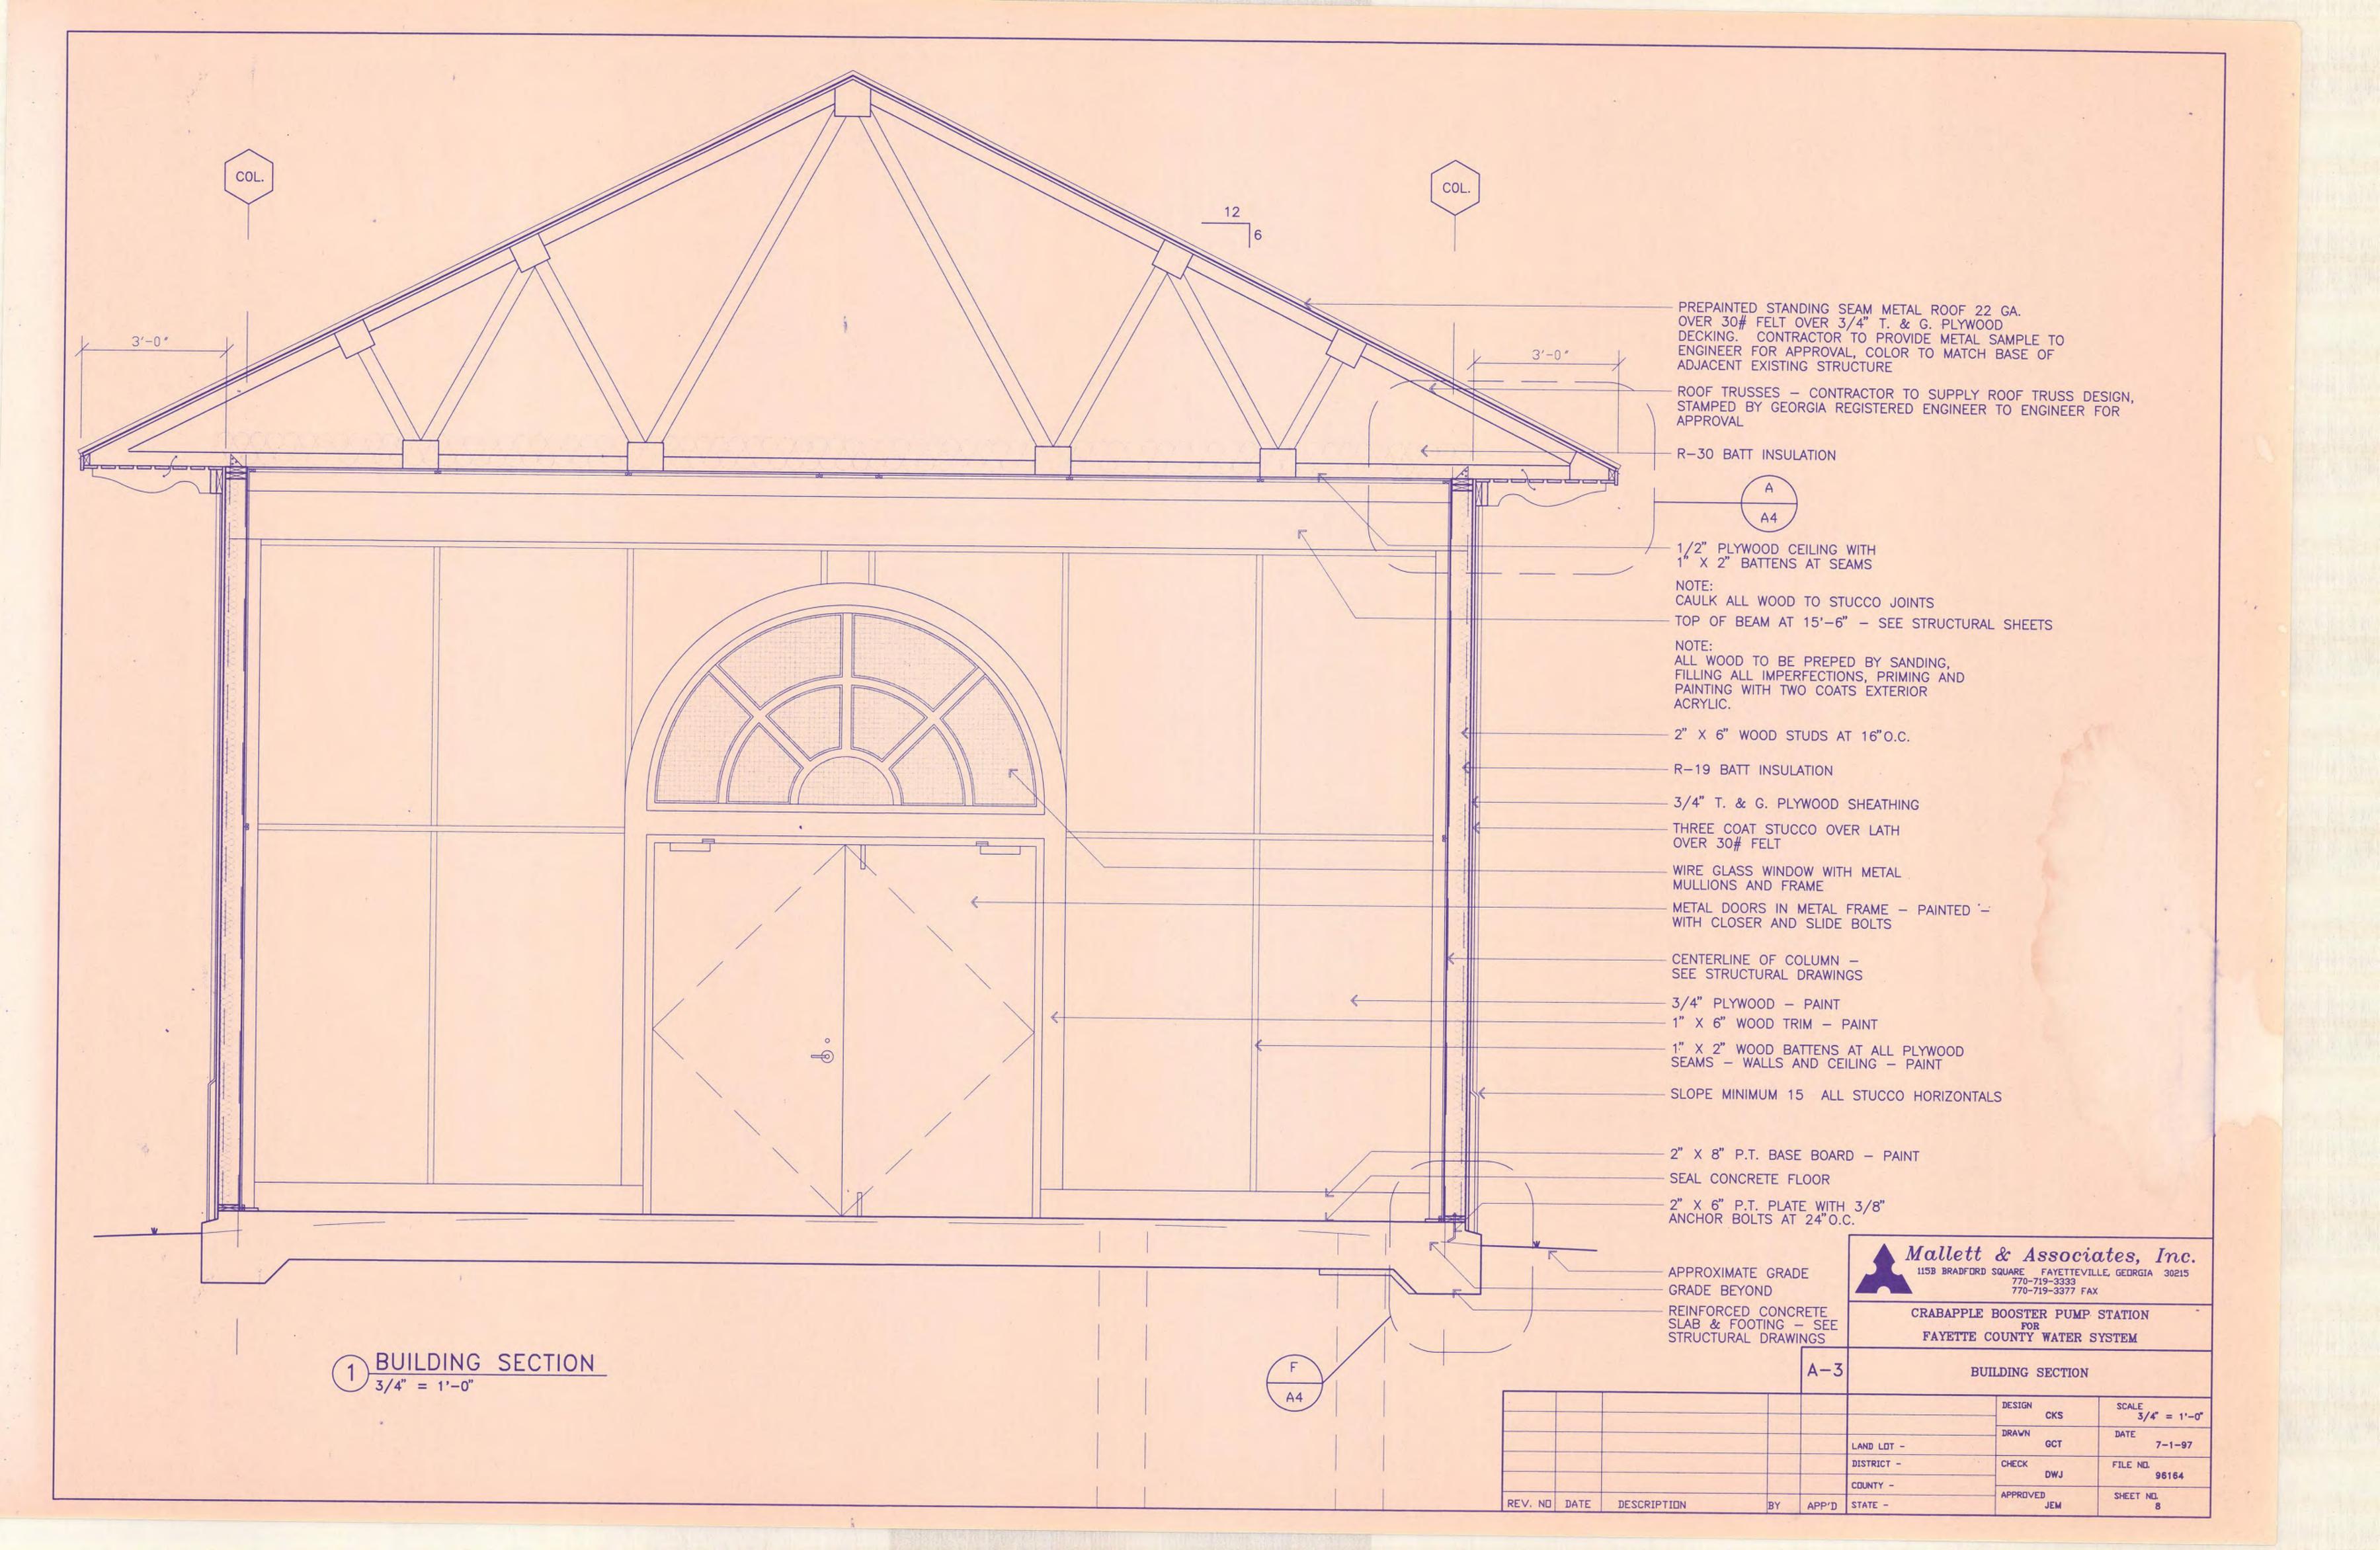

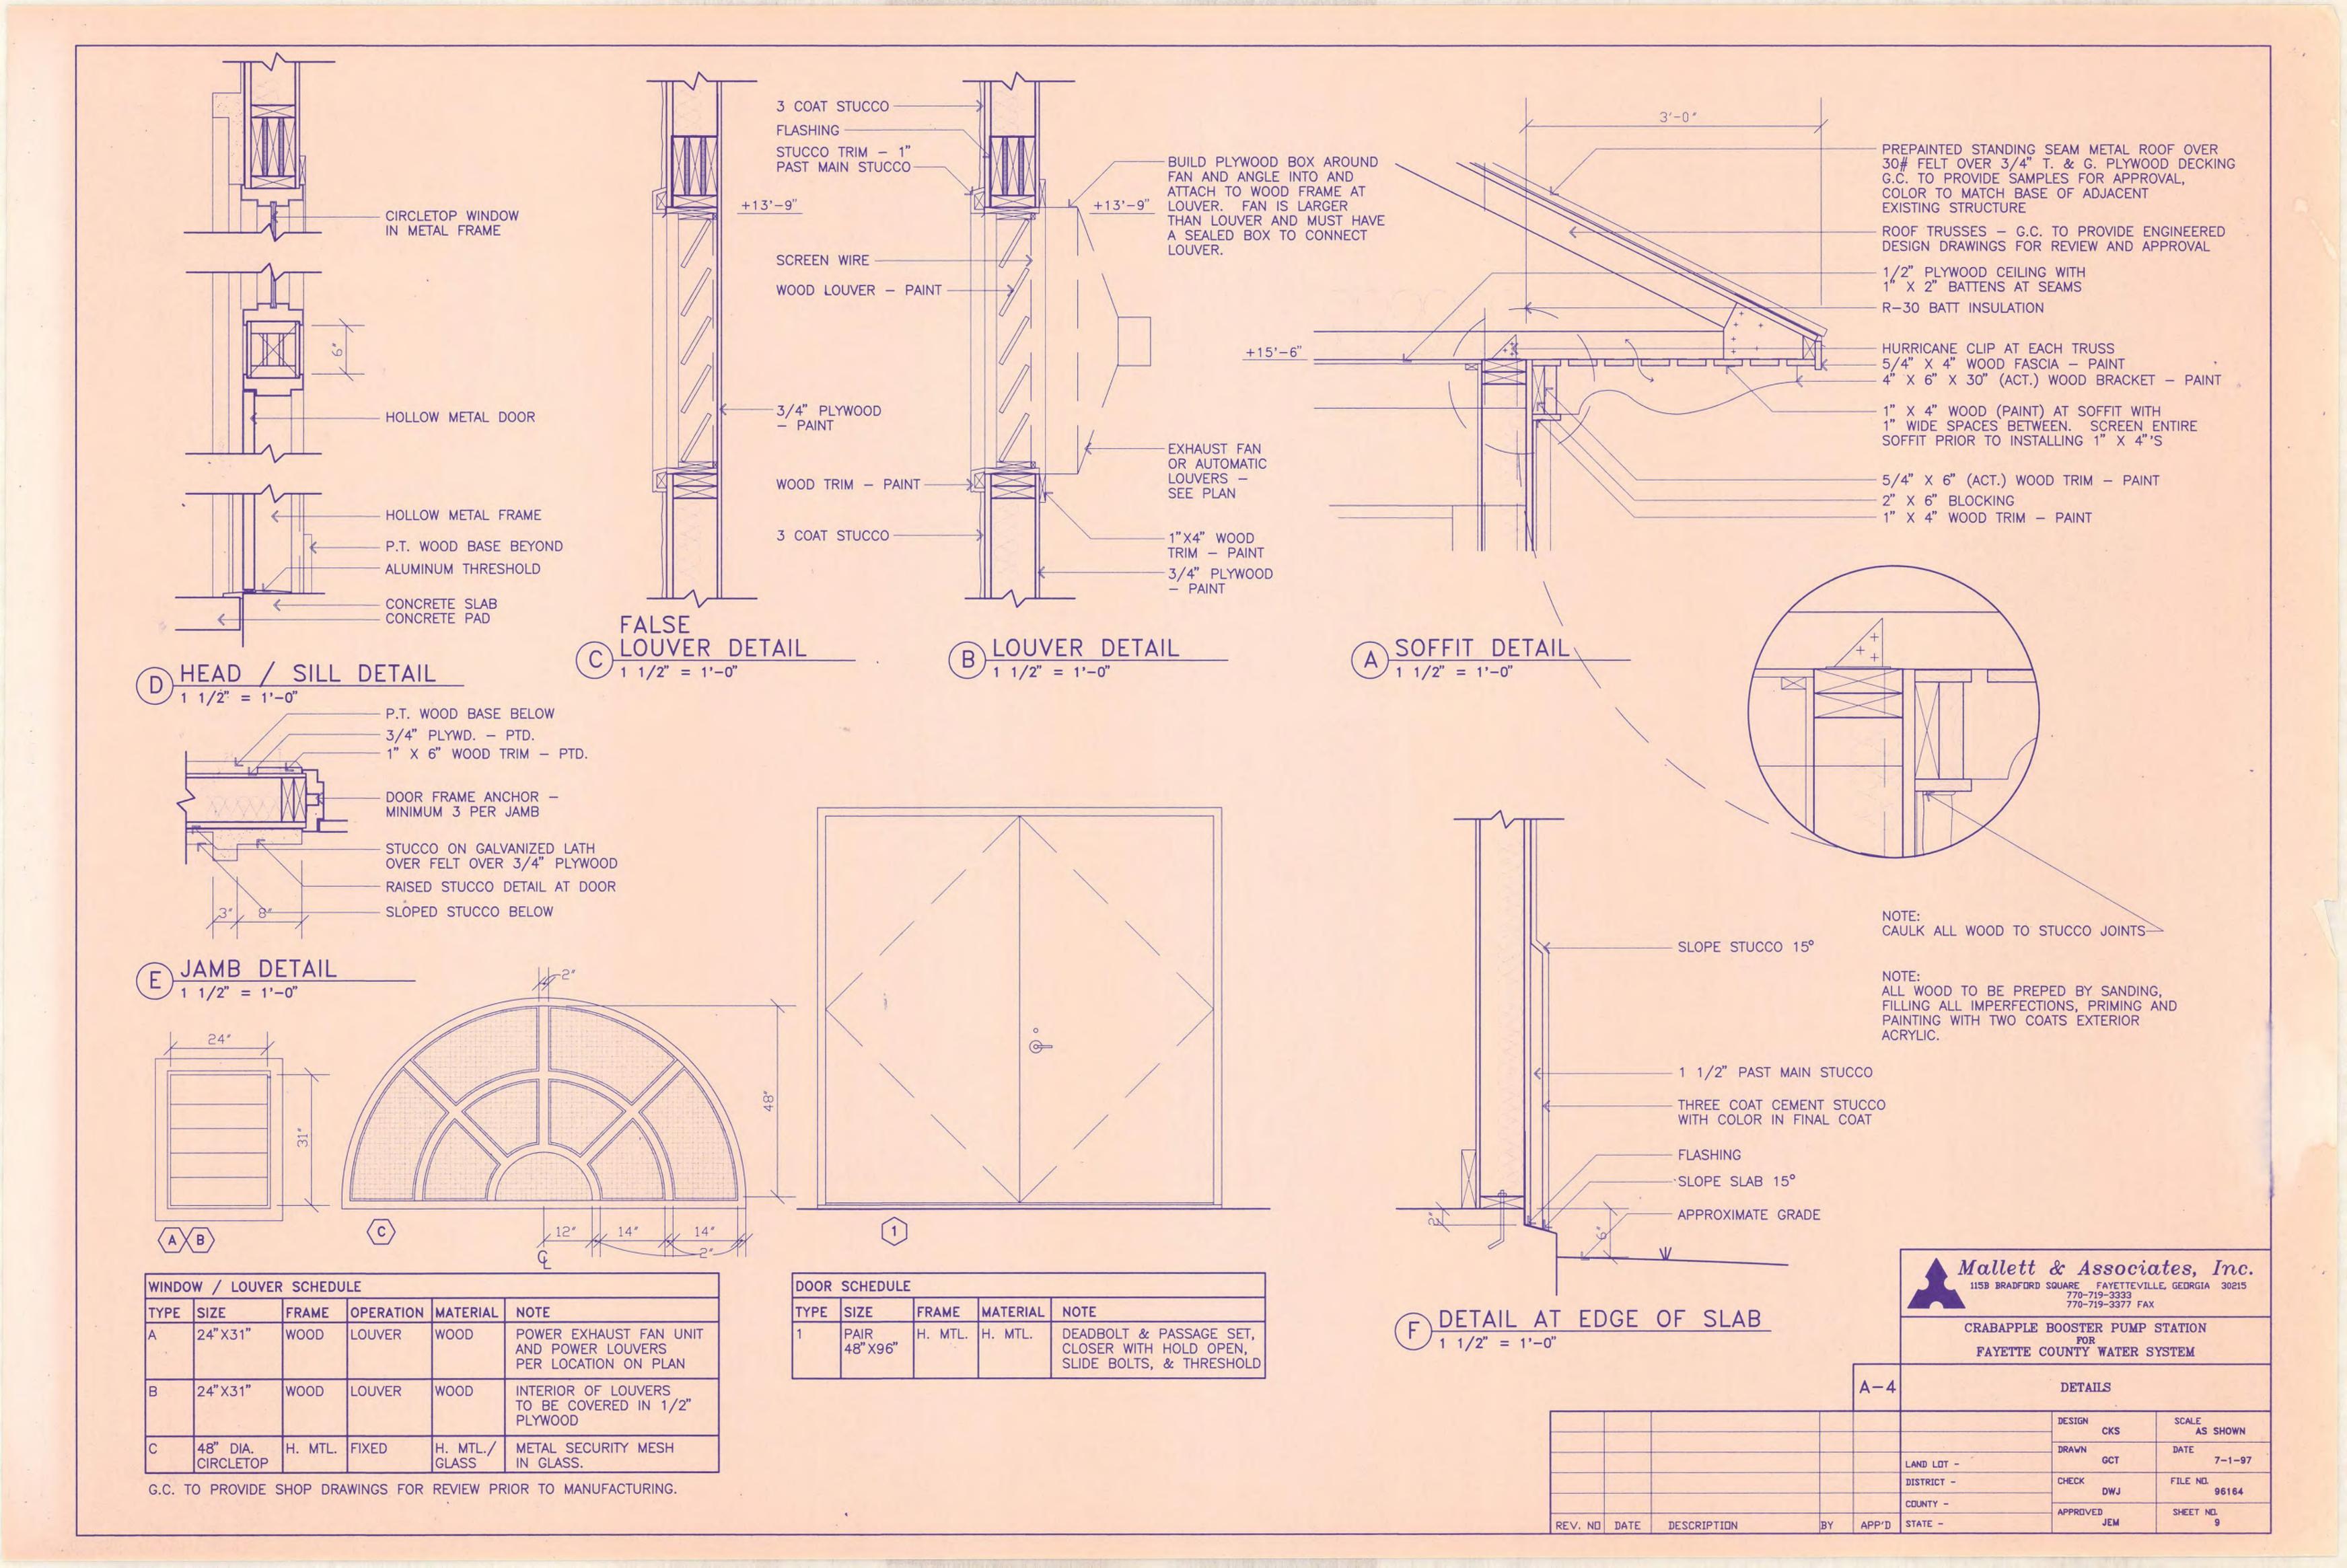

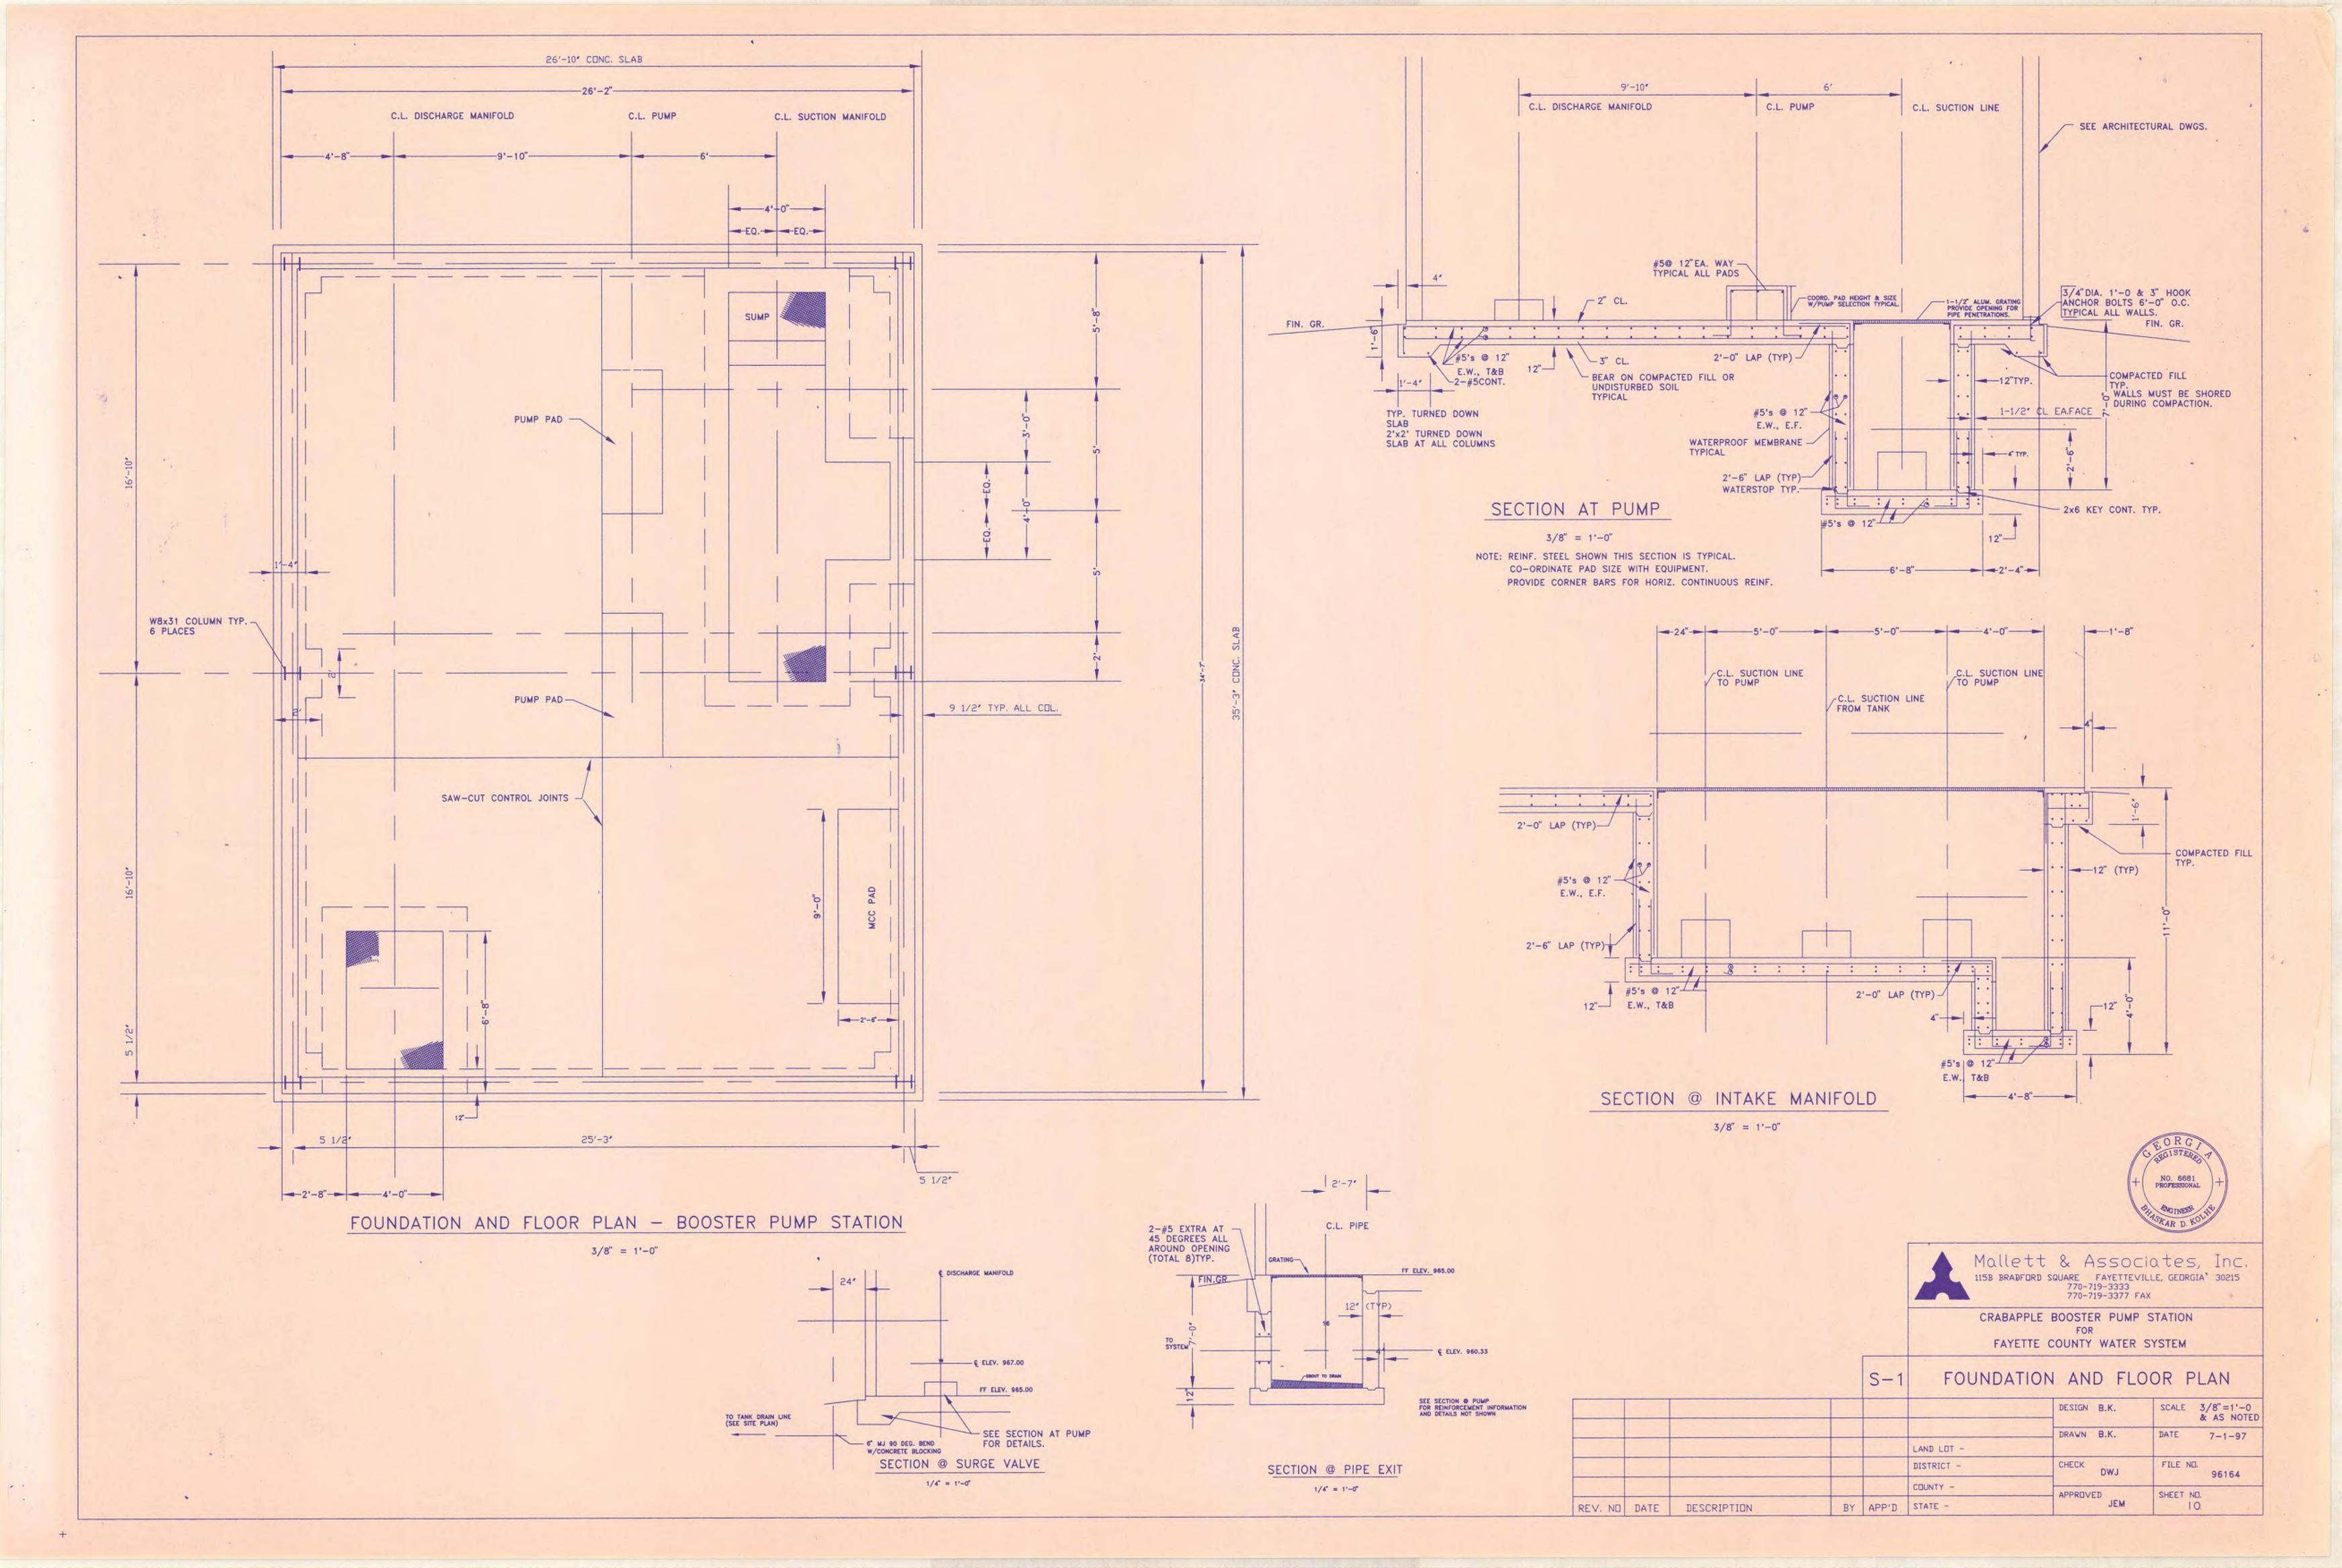

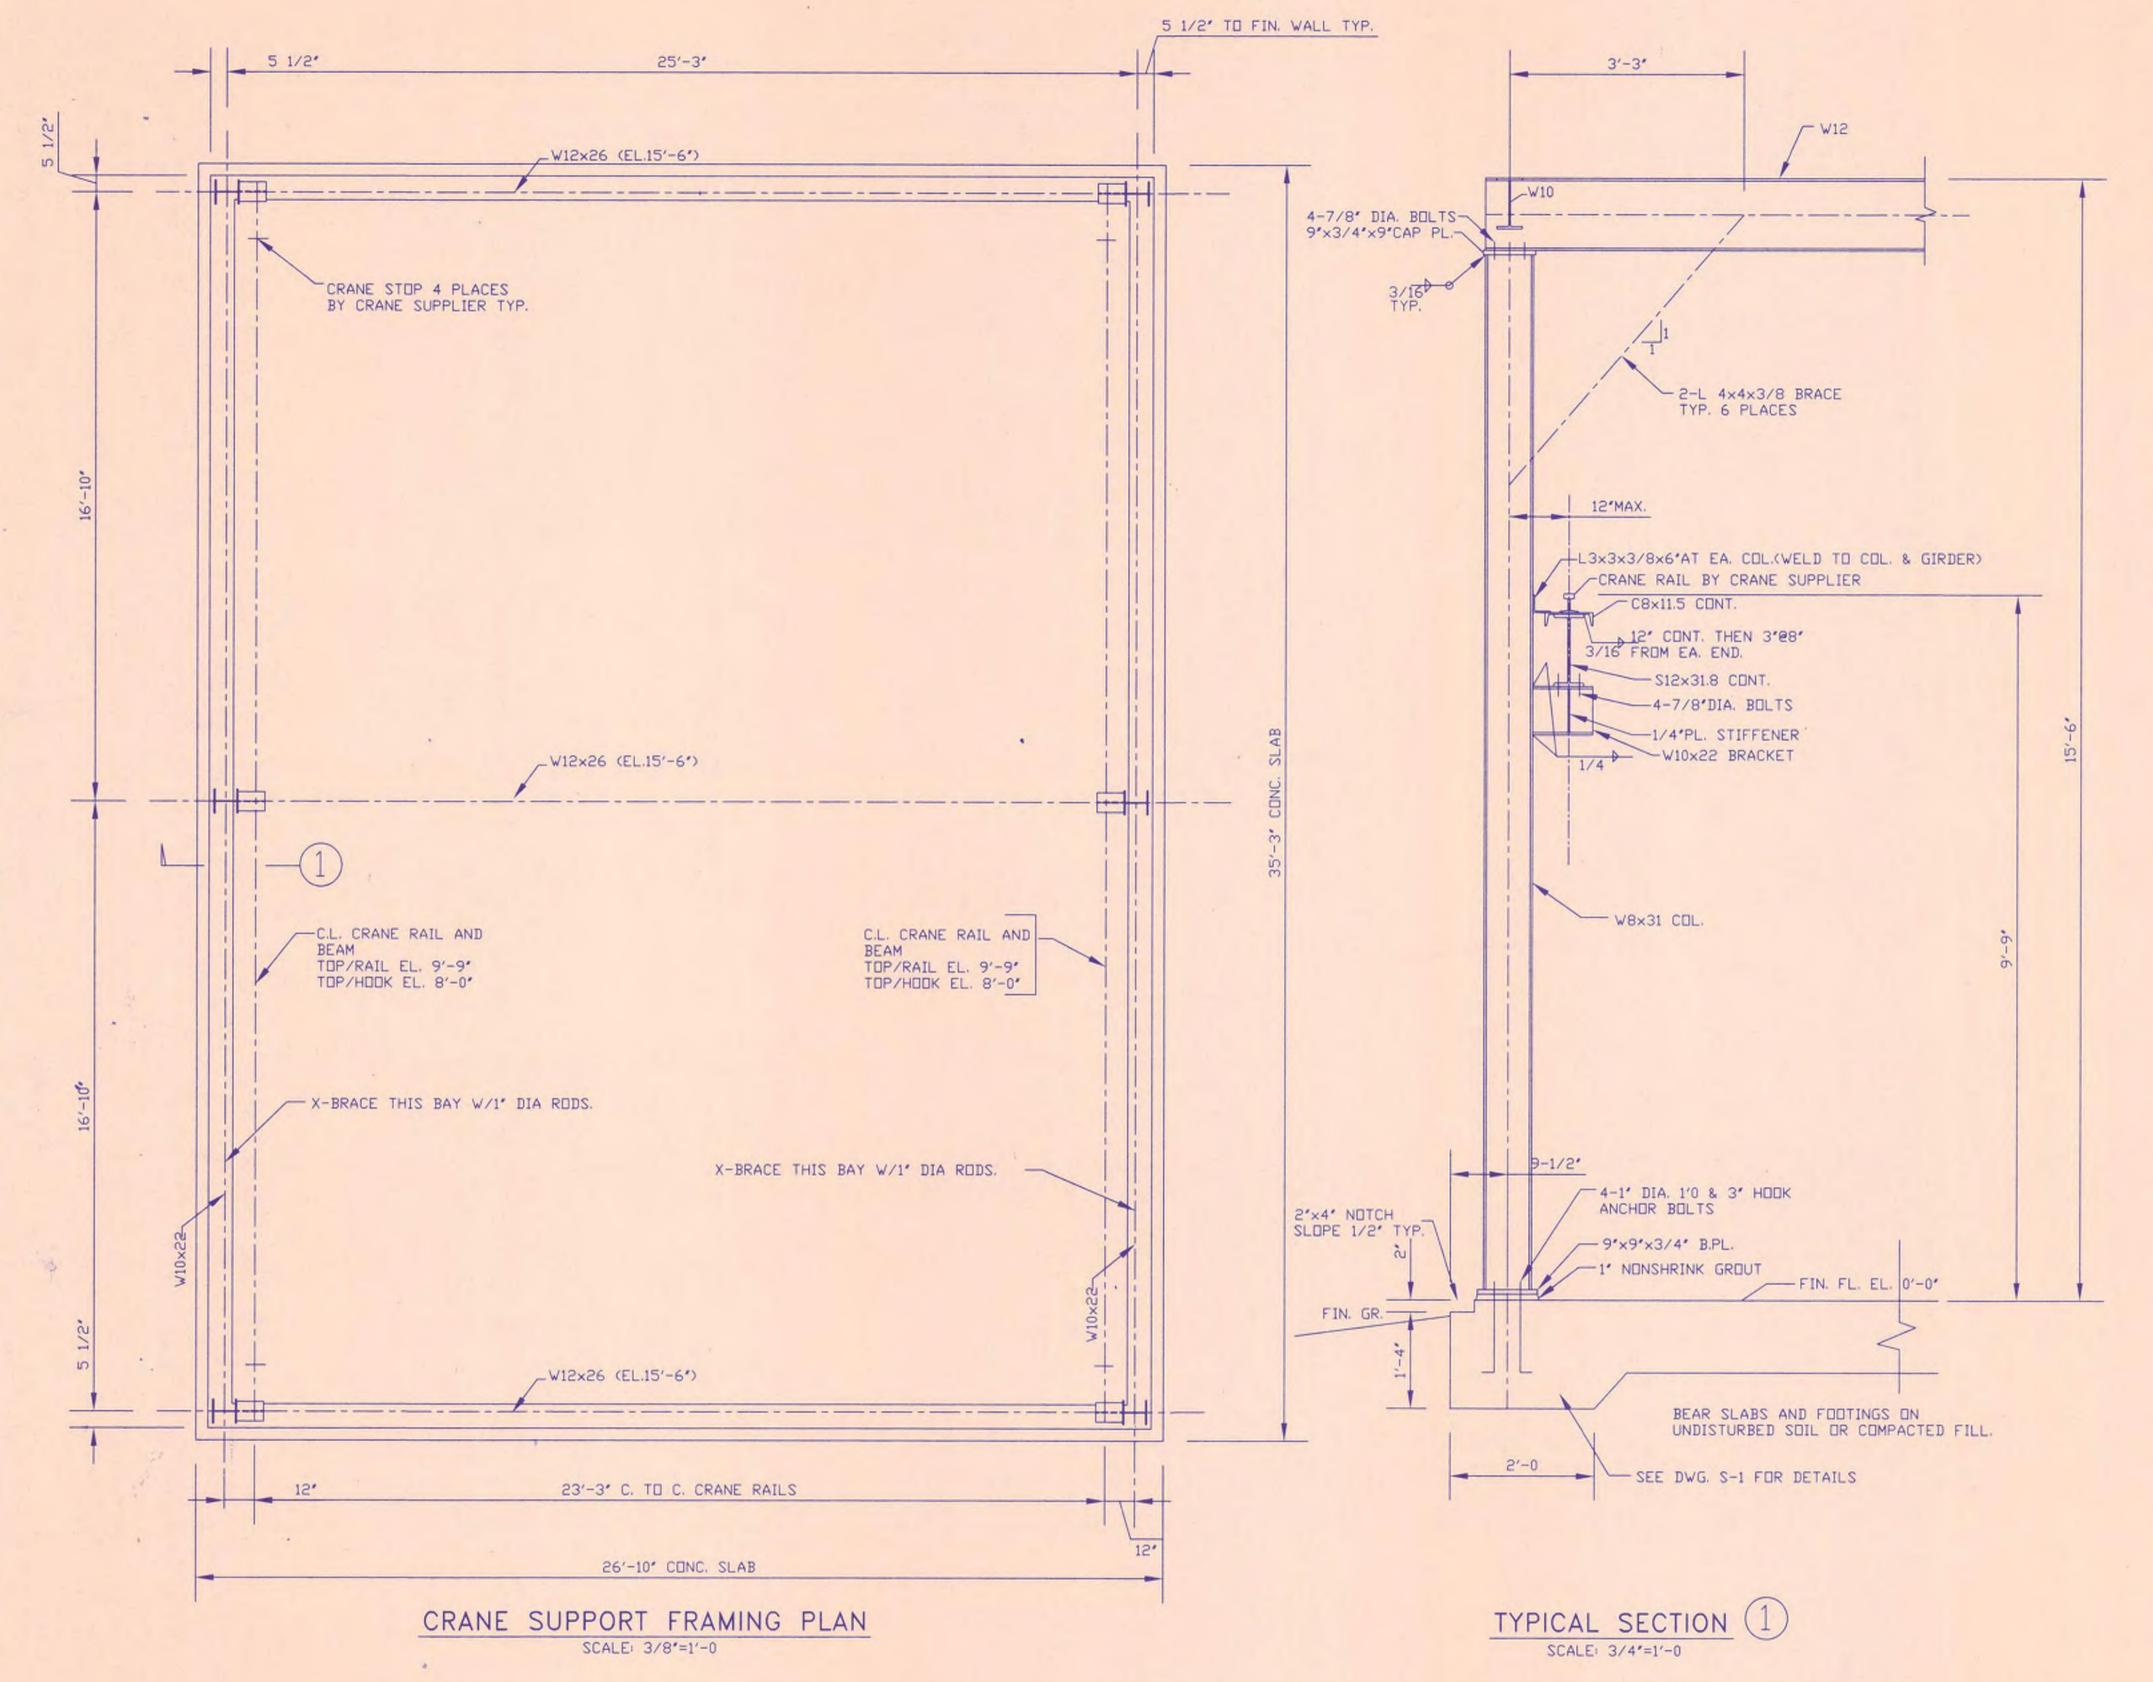

# GENERAL NOTES

- 1. FOOTINGS ARE DESIGNED TO BEAR ON UNDISTURBED SOIL OR COMPACTED FILL HAVING AN ALLOWABLE SOIL PRESSURE OF 2000 PSF. FILL SOIL SHALL BE COMPACTED IN EIGHT INCH LAYERS TO 95% OF PROCTOR DRY DENSITY.
- ALL CONCRETE SHALL HAVE A MINIMUM 28-DAY COMPRESSIVE STRENGTH OF 4000 PSI. DESIGN MIX AND PLACEMENT OF REINFORCING STEEL AND CONCRETE SHALL BE IN ACCORDANCE WITH ACI 318-95. CONTROL JOINTS FOR SLAB ON GRADE SHALL BE SAW CUT 1.5' DEEP WITHIN 16 HOURS OF POUR AND SHALL BE FILLED WITH ELASTOMERIC SEALANT. CHAMFER ALL EXPOSED CONCRETE EDGES 3/4"
- REINFORCING STEEL SHALL BE ASTM A615 GRADE 60. USE PROPER SUPPORTS FOR PLACEMENT OF REINFORCING TO OBTAIN THE SPECIFIED CONCRETE COVER.
- THE CONTRACTOR SHALL BE RESPONSIBLE FOR COORDINATING, LOCATING AND PLACING ALL SLEEVES, INSERTS, ANCHOR BOLTS AND CONCRETE PADS AS REQUIRED BY THE EQUIPMENT.
- STRUCTURAL STEEL SHALL COMPLY WITH ASTM A-36 STEEL. ALL STRUCTURAL STEEL WORK SHALL CONFORM TO THE 9TH EDITION OF THE AISC SPECIFICATIONS FOR THE DESIGN, FABRICATION AND ERECTION OF STRUCTURAL STEEL FOR BUILDINGS. SHOP DRAWINGS FOR ALL STRUCTURAL STEEL SHALL BE SUBMITTED AND APPROVED PRIOR TO ANY FABRICATION.
- STEEL FRAMING CONNECTIONS SHALL BE, IN GENERAL, SHOP WELDED AND FIELD BOLTED. BOLTS SHALL BE A MINIMUM 7/8' DIA. ASTM A-325.
- BEAMS SHALL BE FABRICATED AND ERECTED WITH NATURAL CAMBER UP. ALL WELDS SHALL CONFORM TO ANSI/ AWS DII 'STRUCTURAL WELDING CODE' AND WELDING MUST BE DONE BY CERTIFIED WELDERS. ALL STRUCTURAL STEEL SHALL BE SHOP PRIMED WITH RUST INHIBITIVE PRIMER. COORDINATE FINISH PAINT WITH THE
- STRUCTURAL STEEL FRAMING SHALL BE ERECTED TRUE AND PLUMB IN ACCORDANCE WITH AISC CODE OF STANDARD PRACTICE. PROVIDE TEMPORARY BRACING FOR THE STEEL FRAMING AS REQUIRED.
- THE CRANE SHALL BE RATED FOR 2 TON CAPACITY. THE CRANE SUPPLIER SHALL BE RESPONSIBLE FOR FURNISHING AND ERECTING CRANE RAILS IN ACCORDANCE WITH THE MANUFACTURER'S PRINTED INSTRUCTIONS. THE CRANE SUPPLIER SHALL INSTALL 4 CRANE STOPS ON THE RAILS AS PER THE MANUFACTURER'S REQUIREMENTS. THE RAIL SPLICES SHALL BE STAGGERED. THE CRANE SUPPLIER SHALL COORDINATE HIS WORK WITH THE CONTRACTOR AND FURNISH TOLERANCES FOR INSTALLATION OF CRANE GIRDERS.
- 10. THE CONTRACTOR SHALL BE FULLY RESPONSIBLE FOR PROVIDING NECESSARY SHORING DURING CONSTRUCTION AND SHALL COMPLY WITH THE OSHA REGULATIONS AND PROVIDE SAFE WORKING CONDITIONS ALL THE TIME DURING CONSTRUCTION. ALL PIT WALLS MUST BE SHORED DURING COMPACTION AND UNTIL FLOOR SLAB IS FULLY CURED.

11. DESIGN LOADS:

RODF: LIVE LOAD DEAD LOAD

WIND

CRANE

15 PSF TOP CHORD

10 PSF BOTTOM CHORD 200 PSF LIVE LOAD ANYWHERE ON BOT. CHORD

3100 Lbs. EA. WHEEL

100 MPH



Mallett & Associates, Inc. 115B BRADFORD SQUARE FAYETTEVILLE, GEORGIA 30215 770-719-3333 770-719-3377 FAX

CRABAPPLE BOOSTER PUMP STATION FAYETTE COUNTY WATER SYSTEM

2-5	CRANE	SUPPORT	FRAMING	PLAN
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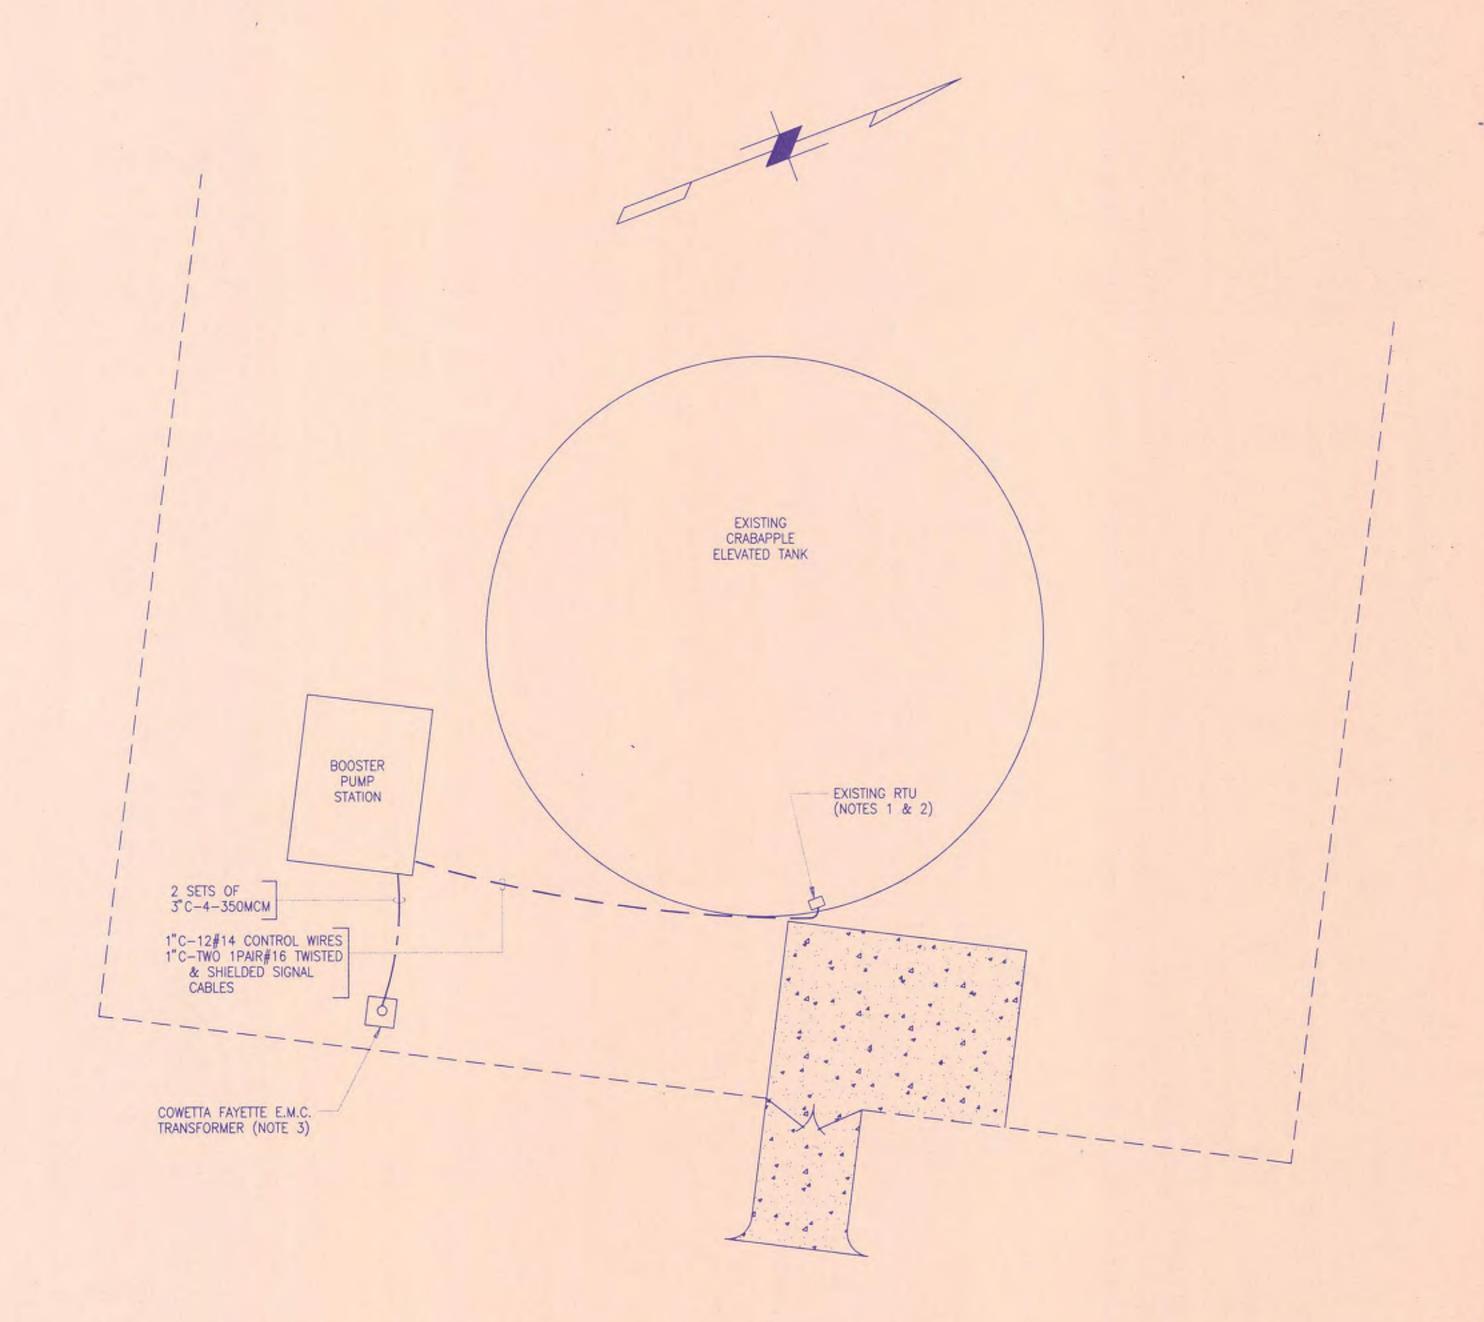
				0 -	CHAIL SOIT	OINT TIMAWIII	NO FLAN
						DESIGN B.K.	SCALE 3/8'=1'-0 & AS NOTED
						DRAWN B.K.	DATE
					LAND LOT -	B.K.	B.K.
					DISTRICT -	CHECK DWJ	FILE NO. 96164
					COUNTY -		
REV. NO	DATE	DESCRIPTION	BY	APP'D	STATE -	APPROVED JEM	SHEET NO.

# LEGEND

4.5					
	UNDERGROUND DUCT BANK	ems m	TRANSFORMER	oTo	TIME DELAY RELAY CONTACT OPENS AFTER TIME DELAY
	ELECTRICAL MANHOLE	KWH	KILOWATTHOUR METER	0-10	TIME DELAY RELAY CONTACT
•—•	POLE MOUNTED LUMINAIRE SEE LIGHT FIXTURE SCHEDULE	A	AMMETER	<b>1</b>	OPENS INSTANTANEOUSLY. CLOSES AFTER TIME DELAY
	CONDUIT BANK	V	VOLTMETER	000	TIME DELAY RELAY CONTACT CLOSES INSTANTANEOUSLY OPENS AFTER TIME DELAY
-4	CONDUIT RUN EXPOSED	VS	VOLTMETER SELECTOR SWITCH FOUR POSITION—"A-B, B-C, C-A, OFF"	X	INDICATING LIGHT R: RED
/	CONDUIT CONCEALED IN FLOOR AND/OR WALL	AS	AMMETER SELECTOR SWITCH FOUR POSITION—"A, B, C, OFF"		G: GREEN A: AMBER  PUSH-TO-TEST-TYPE
	CONDUIT CONCEALED IN WALL AND/OR SUSPENDED CEILING	#	CURRENT TRANSFORMER		R: RED G: GREEN A: AMBER
	HOMERUN TO PANELBOARD CIRCUIT NUMBERS AS INDICATED.	36	POTENTIAL OR CONTROL-POWER TRANSFORMER	***	SELECTOR SWITCH THREE POSITION
-	SHORT HASHMARKS INDICATE NUMBER OF NO.12 AWG PHASE CONDUCTORS. LONG HASHMARKS	S.S.	SURGE SUPPRESSOR	· • • ×	H-O-A: HAND-OFF-AUTO L-O-R: LOCAL-OFF-REMOTE
LA-1,3	NEUTRAL CONDUCTORS. NO HASHMARKS INDICATE 2#12AWG CONDUCTORS IN THE CONDUIT.	\$	LOW VOLTAGE POWER CIRCUIT BREAKER	- o	SELECTOR SWITCH, TWO POSITION
	GROUND CONDUCTOR(S) (NOT SHOWN) SIZED PER N.E.C. MUST BE PROVIDED IN EACH CONDUIT.	Š	MOLDED CASE CIRCUIT BREAKER MCP DENOTES MOTOR CIRCUIT	010	MOMENTARY CONTACT PUSHBUTTON "STOP"
	LIGHTING PANELBOARD		PROTECTOR	0 0	MOMENTARY CONTACT PUSHBUTTON "START"
	DISTRIBUTION PANELBOARD	\$	MAGNETIC STARTER-CONTACTOR WITH THERMAL ELEMENT	20	LEVEL OR FLOAT SWITCH
T	LIGHTING TRANSFORMER	<u></u>	MAGNETIC STARTER - REDUCED VOLTAGE, CLOSED TRANSITION AUTOTRANSFORMER TYPE	1	
<b>3</b>	JUNCTION BOX	Ę		20	PRESSURE SWITCH
F1 -	FLUORESCENT LIGHT FIXTURE WITH OUTLET. FIXTURE TYPE AS INDICATED.	125	MOTOR-NUMBER INSIDE INDICATES HORSEPOWER RATING		OVERTORQUE SWITCH OPENS ON OVERLOAD
$\otimes$	EXIT SIGN	30/3 NEMA-1		050	TEMPERATURE SWITCH
S	SINGLE POLE SWITCH, 48" AFF	Ŷ	AND ENCLOSURE TYPE AS NOTED.	<del></del>	NORMALLY CLOSED (N.C.) CONTACT
s 3	THREE WAY SWITCH, 48" AFF	M	STARTER COIL	010	SOLENOID VALVE
s M	MANUAL MOTOR STARTER, 48" AFF	**	CONTROL POWER TRANSFORMER	o ZS o	LIMIT SWITCH
<b>=</b>	DUPLEX RECEPTACLE, 18" AFF	OL'S	FUSE	ET	ELAPSED TIME METER
	SPECIAL OUTLET, RATING AS NOTED ON DRAWINGS, 18" AFF	<b>→</b> ₩	OVERLOAD RELAY CIRCUIT OPENS ON OVERLOAD	<sup>M</sup> )	
•	TELEPHONE OUTLET	$\dashv$ $\vdash$	NORMALLY OPEN (N.O.) CONTACT		SOLID STATE STARTER
30/3/3R	HEAVY DUTY DISCONNECT SWITCH. AMPERE RATING/POLES/ENCLOSURE TYPE AS INDICATED.	(TD)	TIME DELAY RELAY TDAE: DENOTES TIME DELAY AFTER ENERGIZING TDAD: DENOTES TIME DELAY AFTER DEENERGIZING	♠ )	THERMOSTAT
CS	CONTROL STATION, SEE SCHEMATIC DIAGRAM FOR REQUIREMENTS.	200	TIME DELAY RELAY CONTACT CLOSES AFTER TIME DELAY		

# NOTES:

- MODIFY THE EXISTING R.T.U. IN ACCORDANCE WITH THE SPECIFICATIONS.
- FURNISH AND INSTALL 4' FLUORESCENT LIGHT FIXTURE
  TYPE 'C' ABOVE THE R.T.U. MOUNT LIGHT FIXTURE 8'-0"
  ABOVE FINISHED FLOOR. PROVIDE WELDED UNISTRUTS
  FROM TANK WALL TO INSTALL THE FIXTURE WITH THE
  DIFFUSER FACING DOWN. CONNECT THE LIGHT FIXTURE TO
  EXISTING LIGHT FIXTURE IN THE VICINITY.
- CONTRACTOR SHALL COORDINATE EXACT LOCATION WITH THE POWER COMPANY.



# ELECTRICAL SITE LAYOUT 1" = 20'

Mallett & Associates, Inc.
115B BRADFORD SQUARE FAYETTEVILLE, GEORGIA 30215
770-719-3333
770-719-3377 FAX

CRABAPPLE BOOSTER PUMP STATION FOR

FAYETTE COUNTY WATER SYSTEM



				E1	LEGEND, SCHE	DULES & SITE	LAYOUT
						DESIGN SNK	SCALE 1' = 20'
						DRAWN	DATE .
					LAND LOT -	PYB	JULY 1, 1997
					DISTRICT -	CHECK	FILE NO. 96164
					COUNTY -	APPROVED -	SHEET NO.
REV. NO	DATE	DESCRIPTION	BY	APP'D	STATE -	JEM	12

# LIGHT FIXTURE SCHEDULE

TYPE

DESCRIPTION

8' DUST & MOISTURE RESISTANT FLUORESCENT FIXTURE, IMPACT-RESISTANT REINFORCED POLYESTER HOUSING, BAKED ENAMEL FINISH, TWO F96T12/CW/HO LAMPS, 120V BALLAST.

LITHONIA #DM296HO-120


INCANDESCENT DECORATIVE WALL MOUNTED LIGHT FIXTURE, BRASS CONSTRUCTION, TWO 60W CANDELABRA BASE LAMPS


MCLEAN LIGHTING WORKS — "ZENKE (SMALL)"

mocent commo monto centre (onese)

4' FLUORESCENT FIXTURE, REINFORCED POLYESTER FIBERGLASS HOUSING, ACRYLIC DIFFUSER, TWO 40W T12 COOL WHITE LAMPS, 120V ENERGY SAVING BALLAST, U.L. LISTED FOR DAMP LOCATION.

LITHONIA #DM240-120-ES

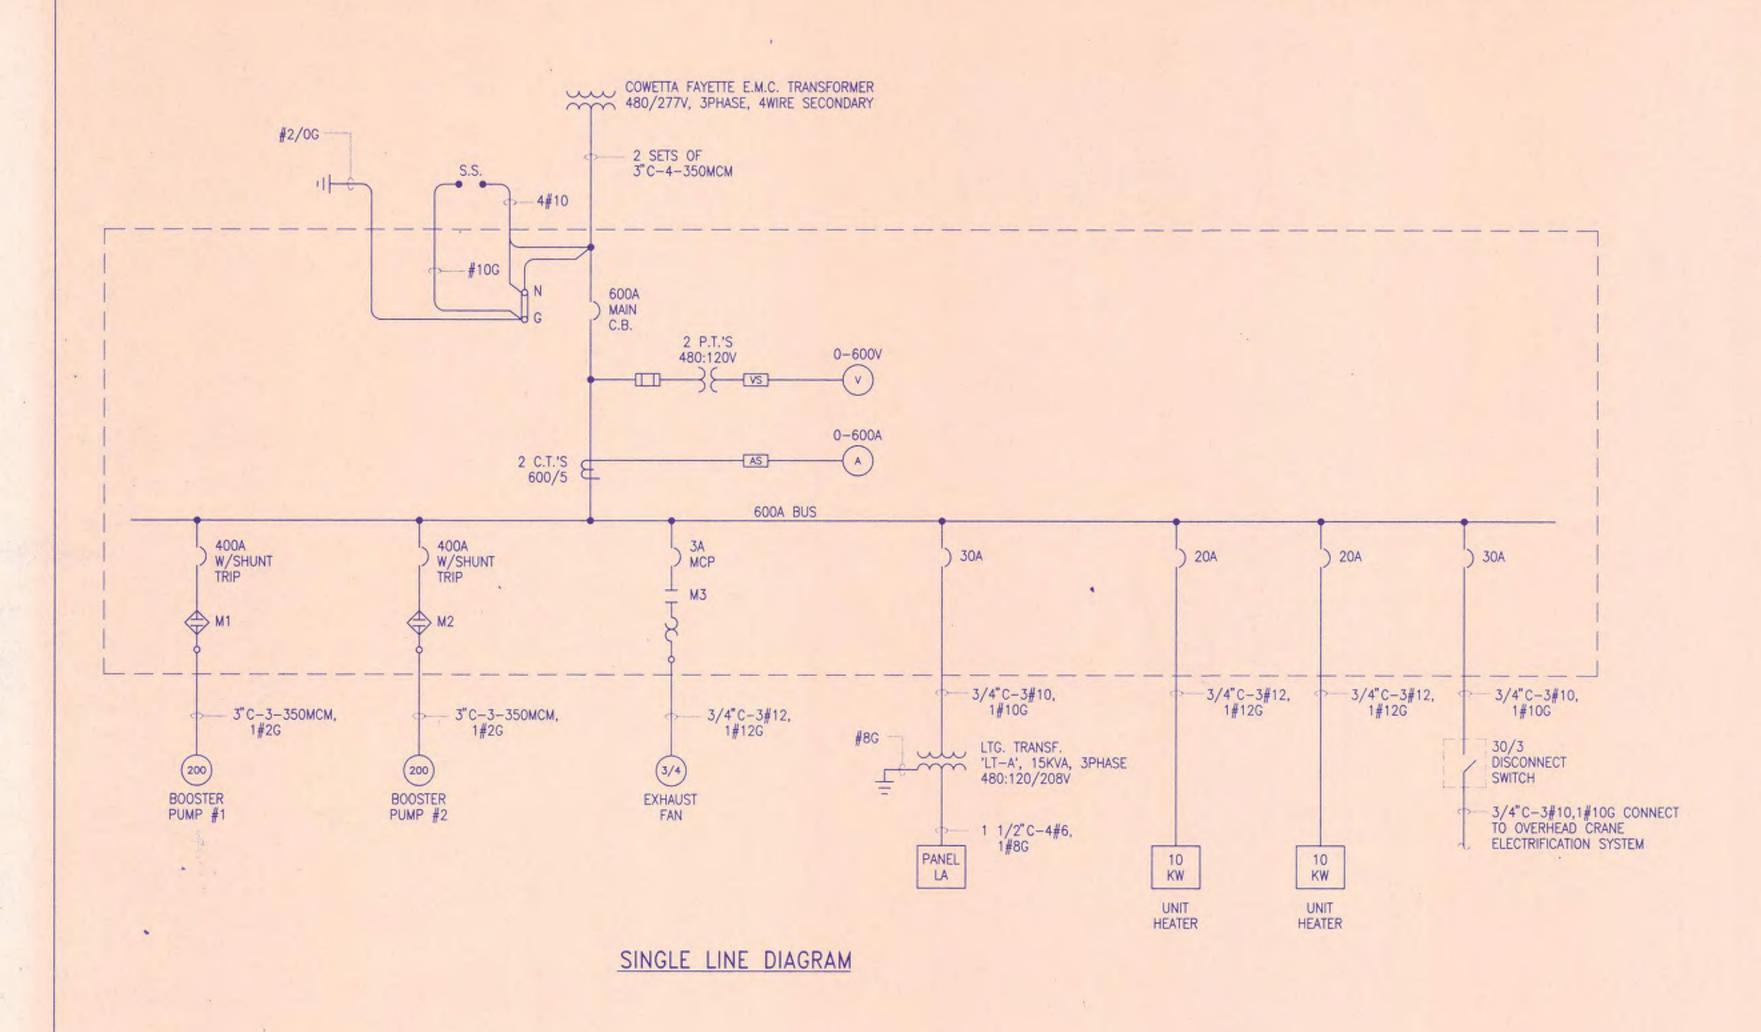

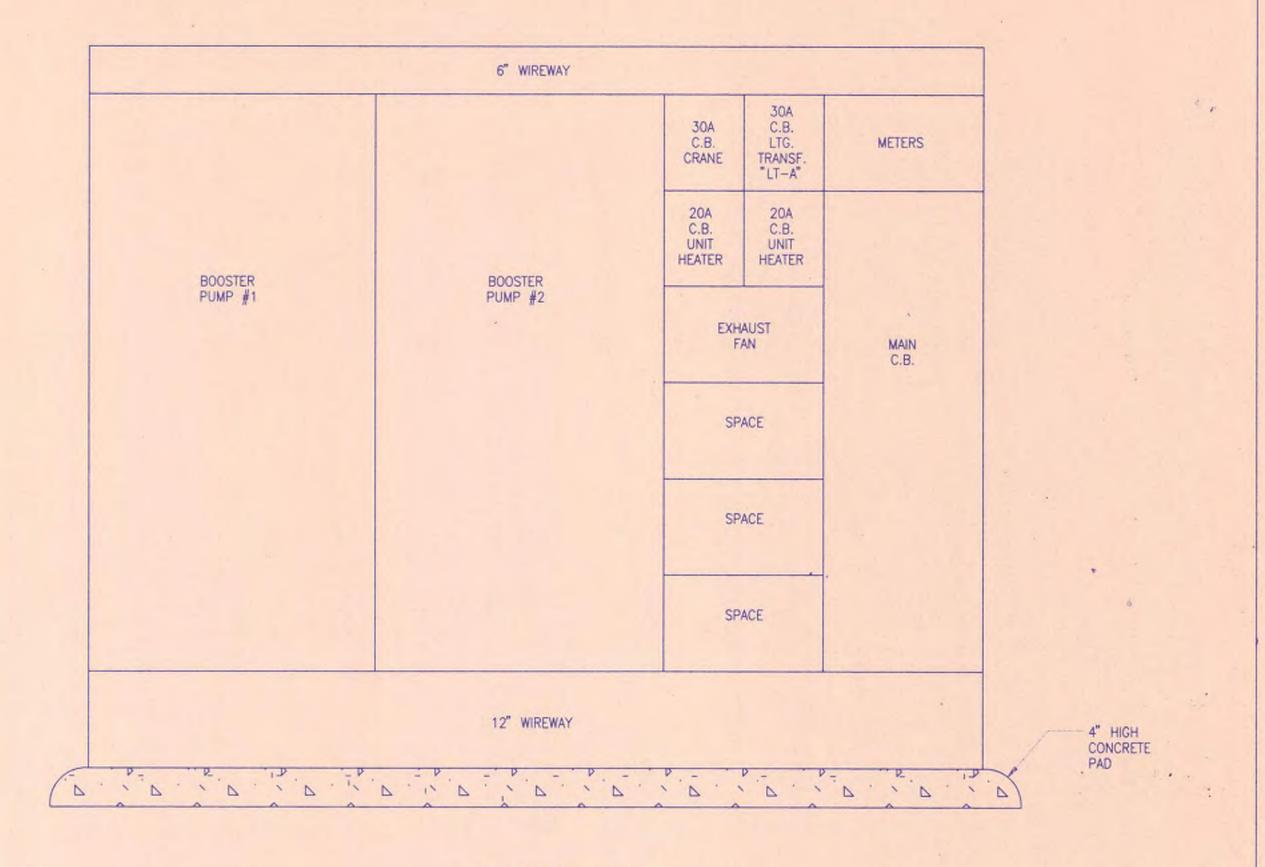

MCC FRONT VIEW

A M

Mallett & Associates, Inc.

115B BRADFORD SQUARE FAYETTEVILLE, GEORGIA 30215


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CRABAPPLE BOOSTER PUMP STATION FOR FAYETTE COUNTY WATER SYSTEM

	SINGLE	LINE	DIAGRAM




							DESIGN SNK	SCALE NONE
							DRAWN	DATE
1						LAND LOT -	PYB	JULY 1, 1997
+						DISTRICT -	CHECK	FILE NO. 96164
						COUNTY -	APPROVED	SHEET NO.
	REV. NO	DATE	DESCRIPTION	BY	APP'D	STATE -	JEM	13

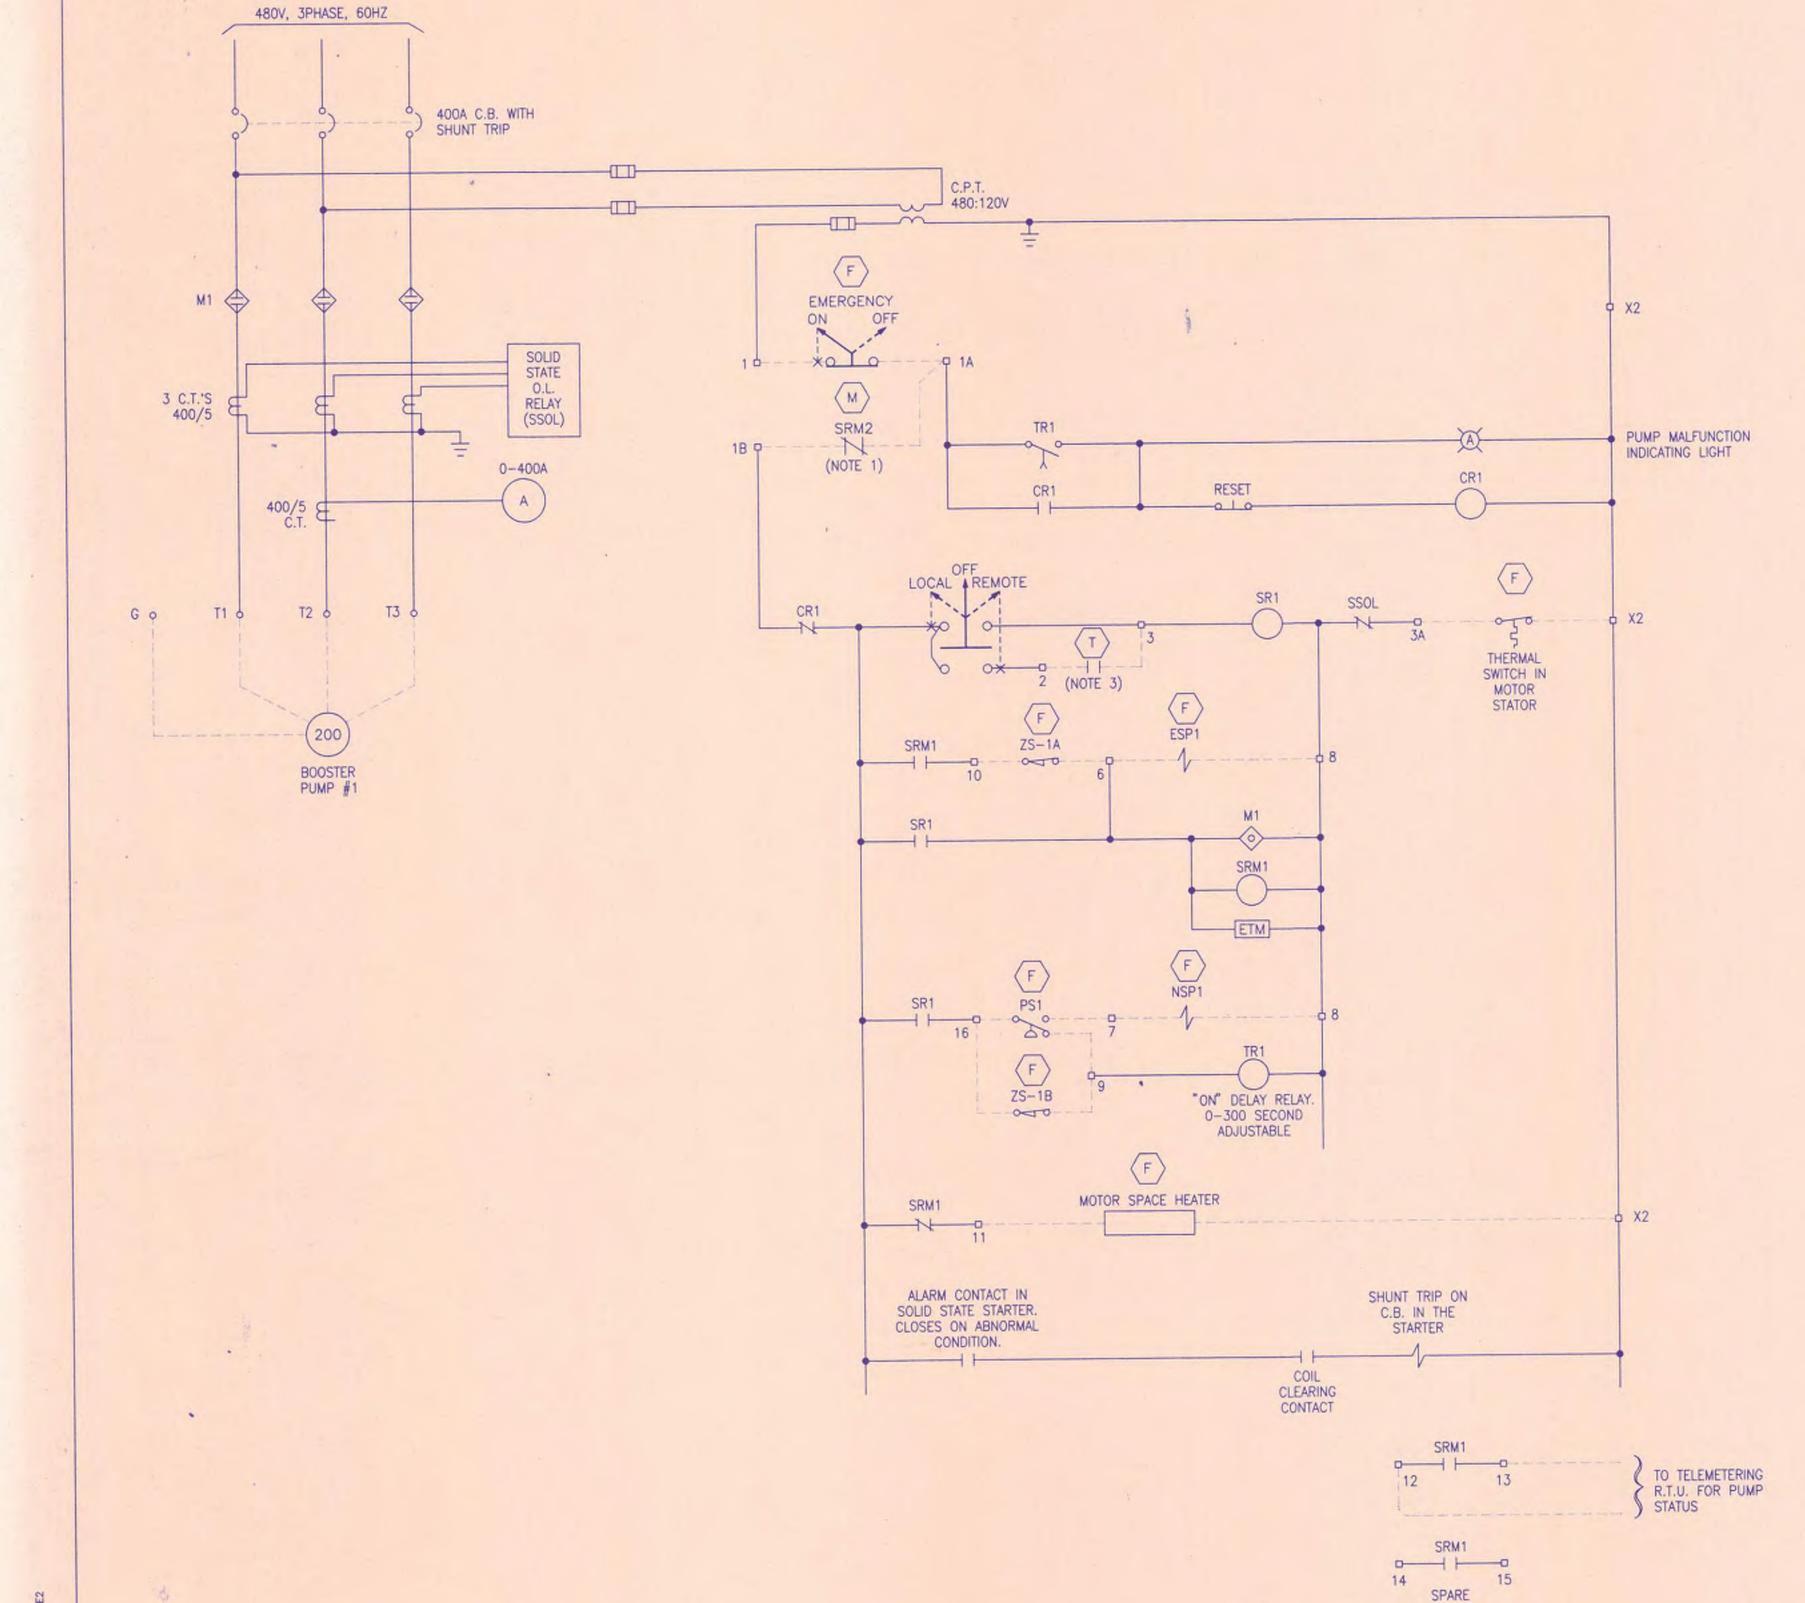

SCHEMATIC DIAGRAM
BOOSTER PUMP #1

(NOTE 1)

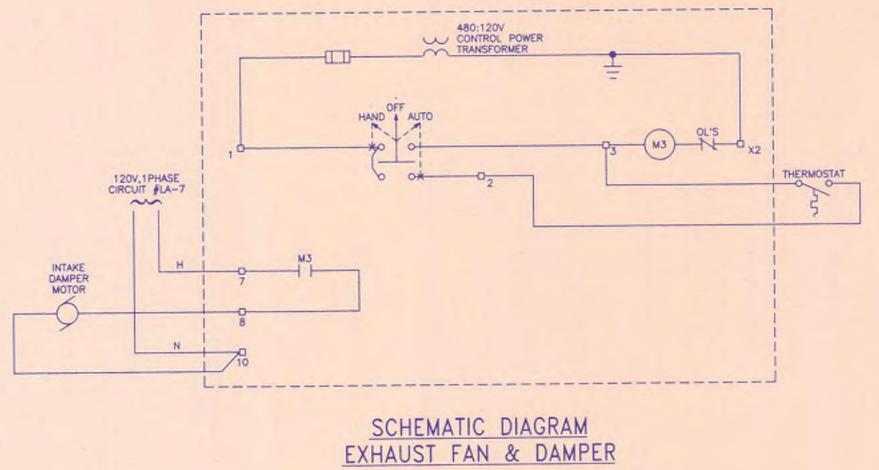

NOTES:

- SCHEMATIC DIAGRAM FOR BOOSTER PUMP #2 SHALL BE SIMILAR.
- CONTACT IN BOOSTER PUMP #2 STARTER. OPENS WHEN BOOSTER PUMP #2 IS RUNNING TO PREVENT PUMP #1 FROM RUNNING.
- PUMP START/STOP CONTACT IN TELEMETERING R.T.U. LOCATED AT CRABAPPLE TANK.

# LEGEND

i	FIELD WIRING
NSP1	DENOTES NORMAL SOLENOID PILOT VALVE
ESP1	DENOTES EMERGENCY SOLENOID PILOT VALVE
PS1	DENOTES PUMP DISCHARGE PRESSURE SWITCH, CONTACT TRANSFERS WHEN PUMP PRODUCES PROPER PRESSURE
ZS-1A	LIMIT SWITCH ON PUMP DISCHARGE VALVE, OPENS WHEN VALVE IS FULLY CLOSED.
ZS-1B	LIMIT SWITCH ON PUMP DISCHARGE VALVE. CLOSED WHEN VALVE IS NOT FULLY OPEN.

# LOCATION LEGEND

(F)	LOCATED	IN	FI

M LOCATED IN DIFFERENT STARTER IN M.C.C.

LOCATED IN TELEMETERING R.T.U.

ALL THE OTHER UNDESIGNATED DEVICES ARE LOCATED IN THE


Mallett & Associates, Inc.


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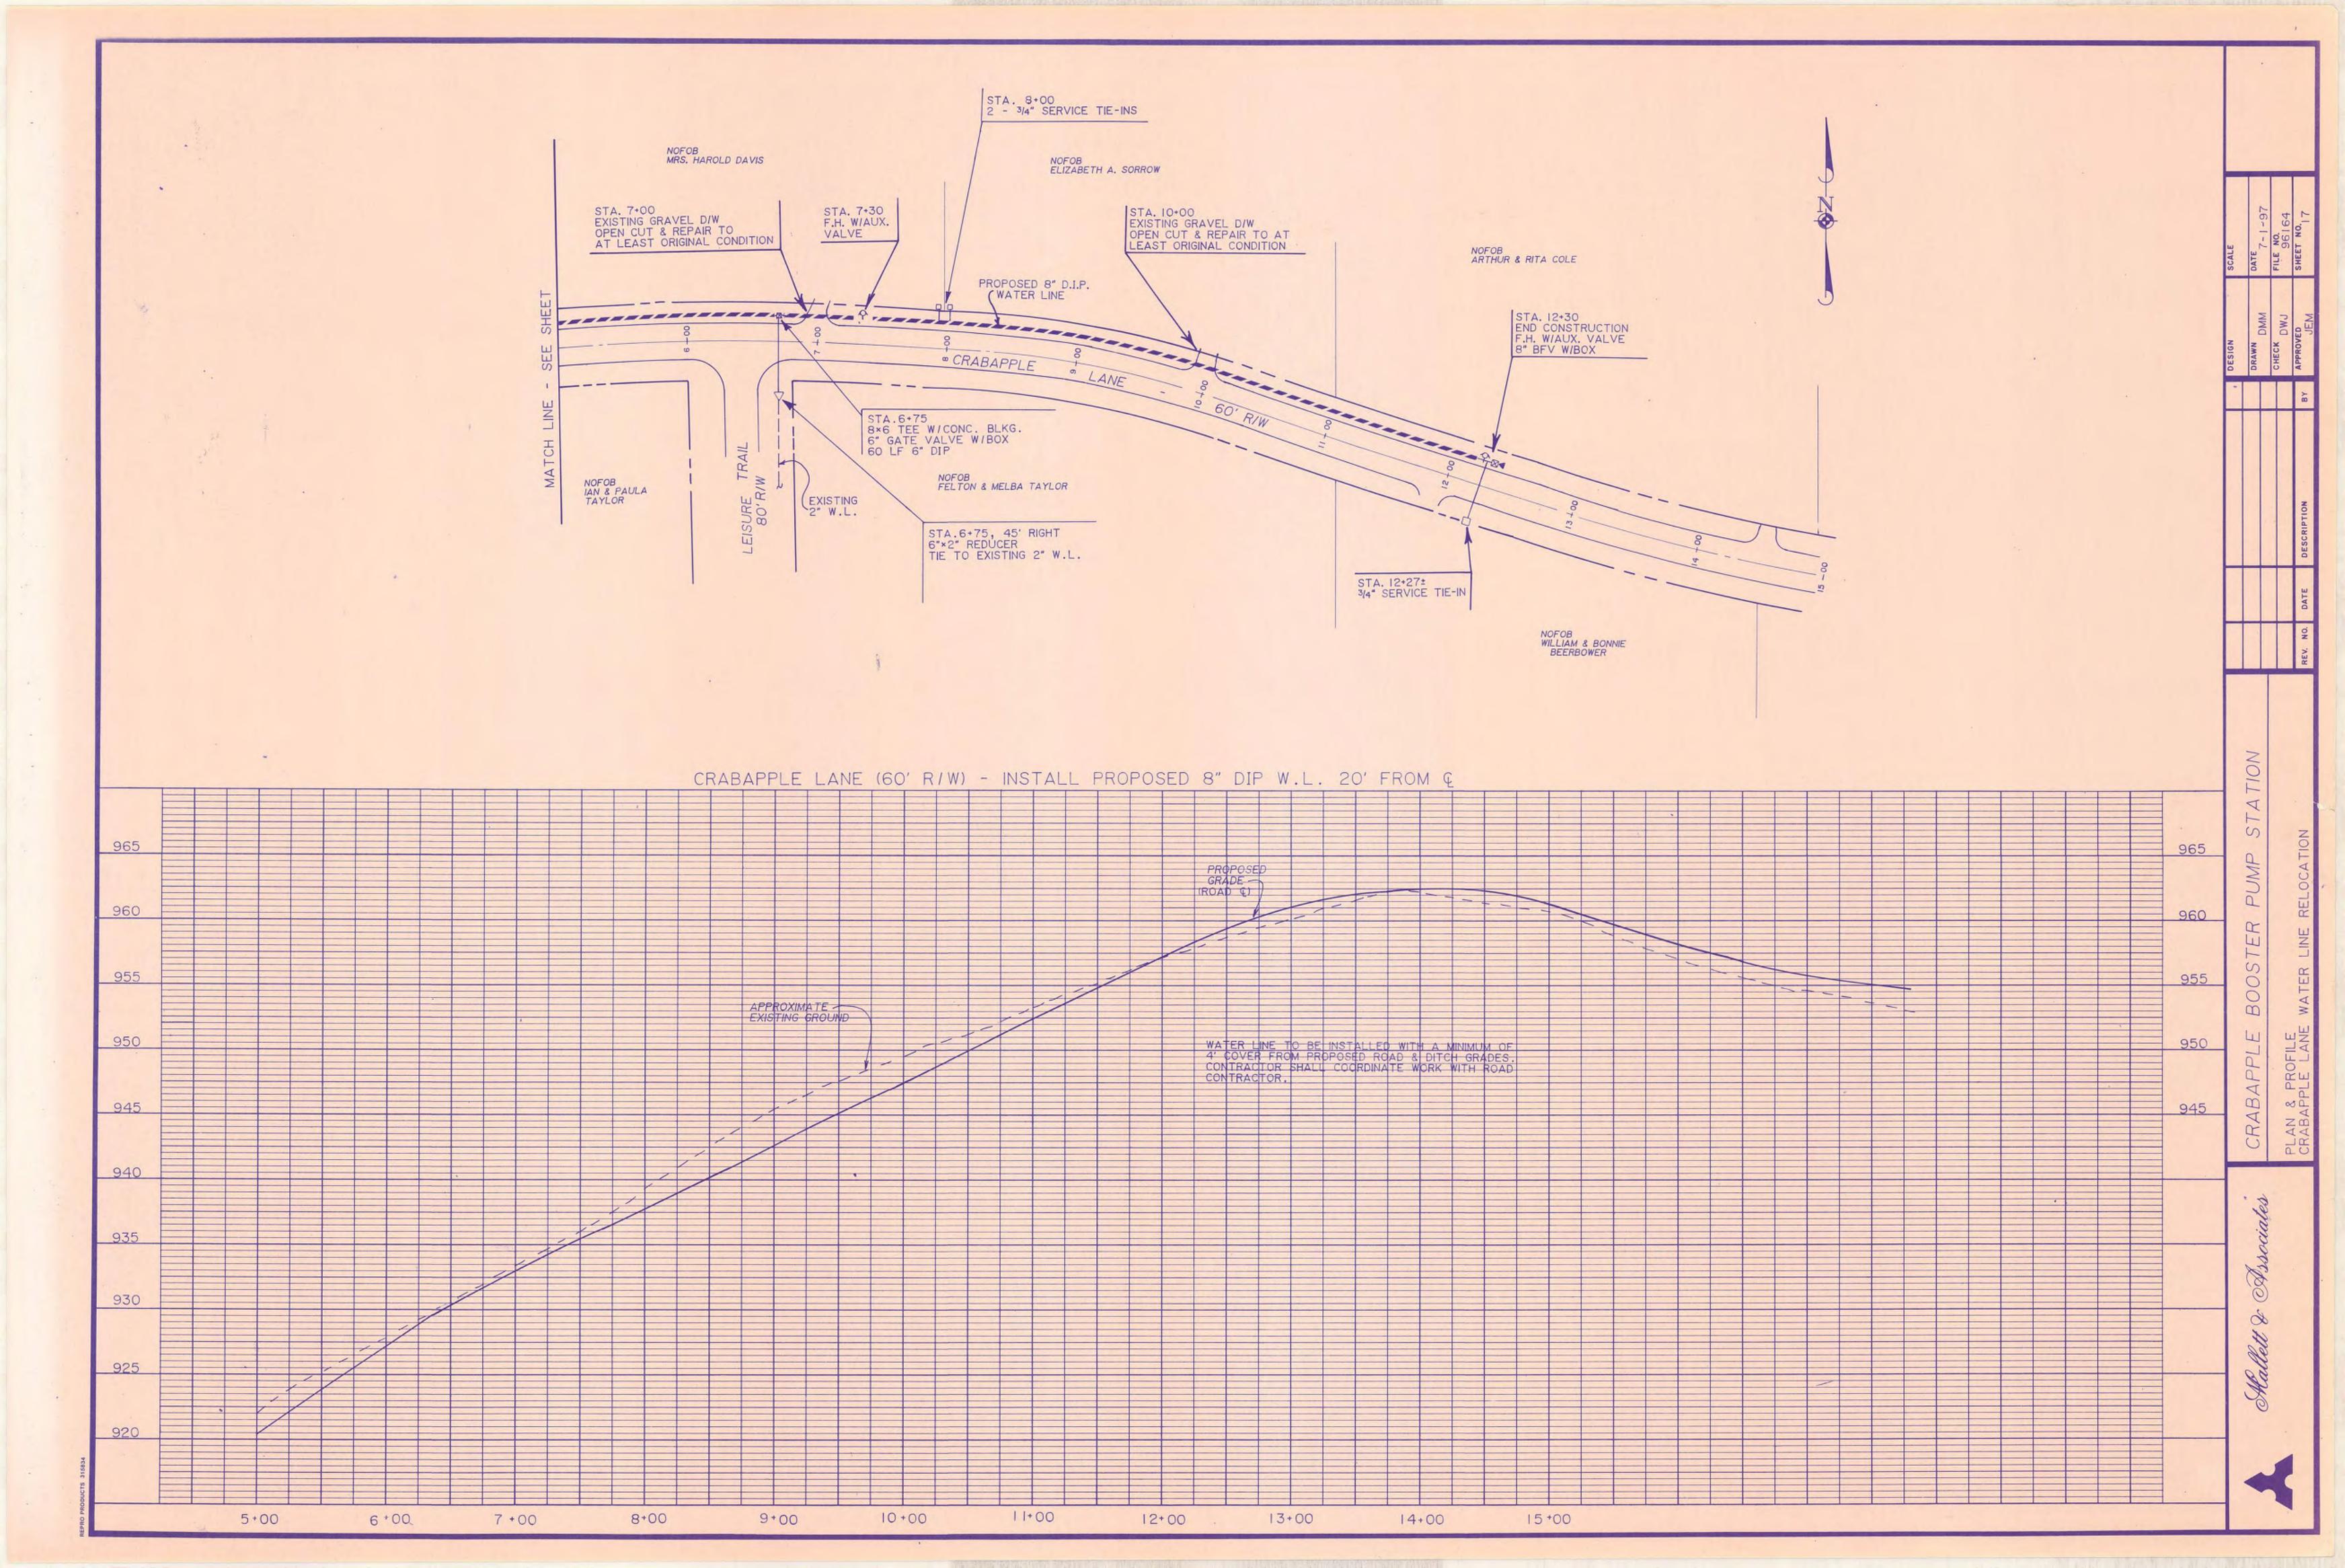
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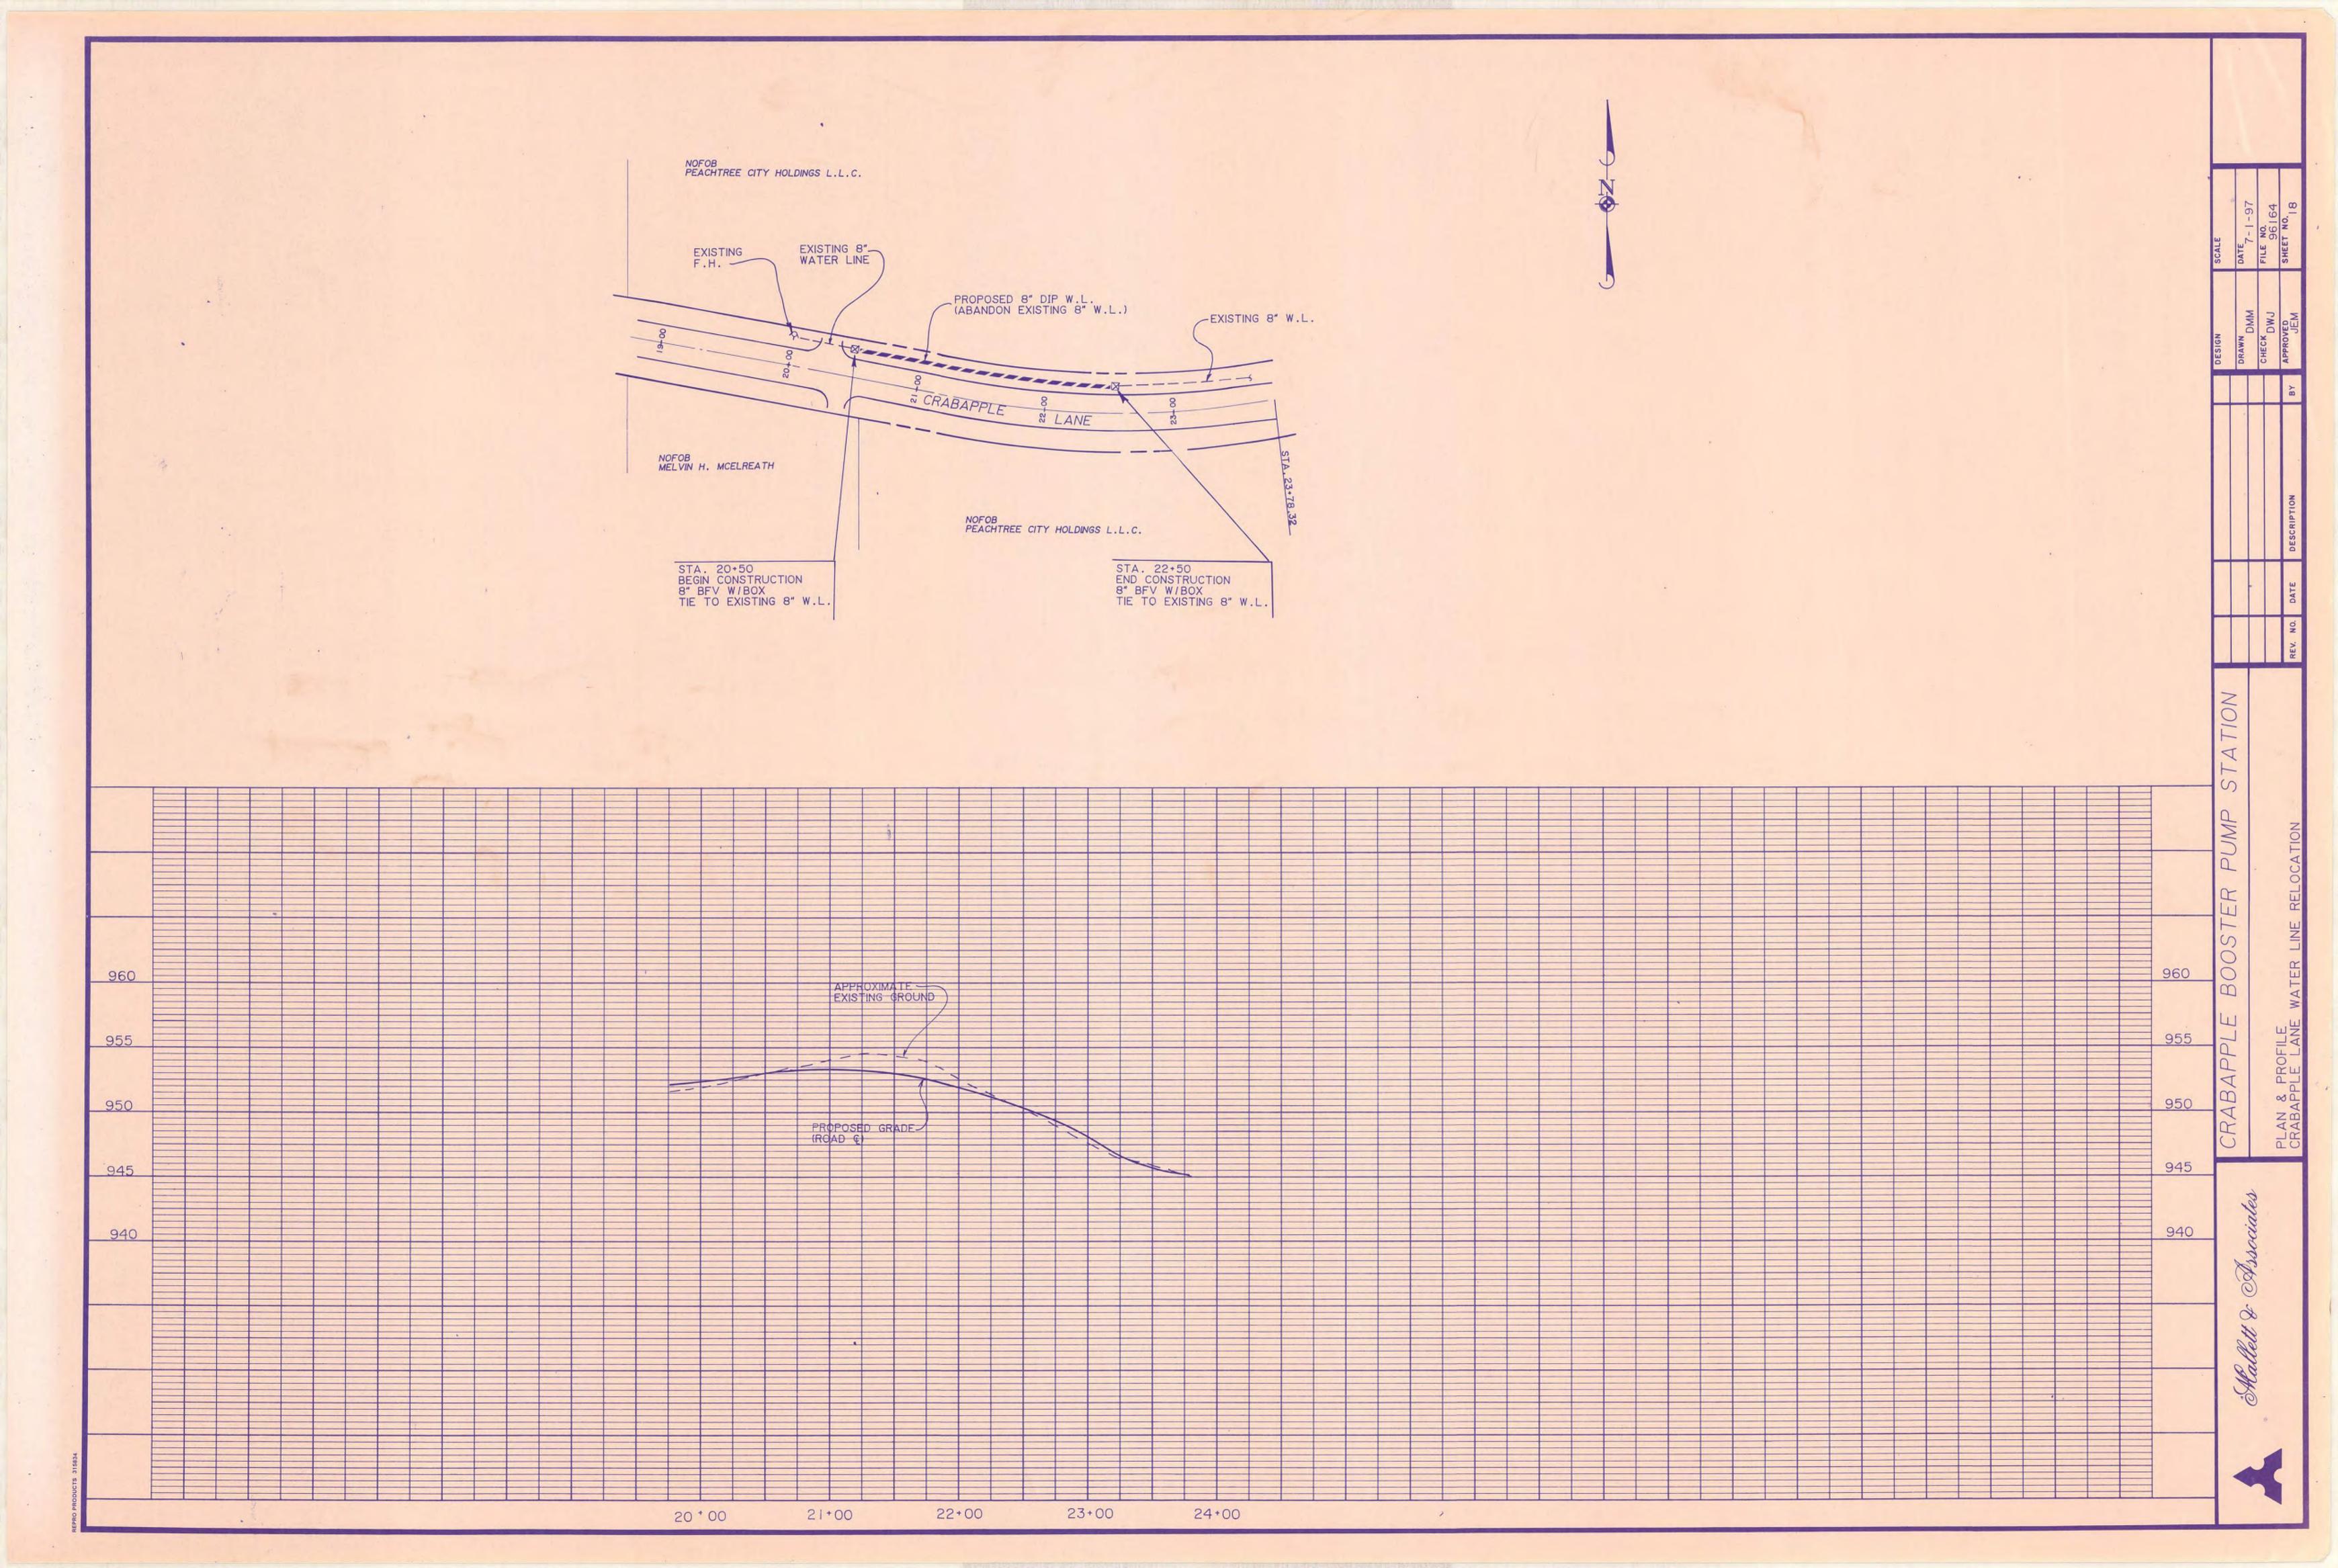
CRABAPPLE BOOSTER PUMP STATION FOR FAYETTE COUNTY WATER SYSTEM


				E3	SCHEMATIC DIAGRAMS			
							DESIGN	SCALE NONE
						LAND LOT	DRAWN PYB	DATE JULY 1, 1997
						DISTRICT -	CHECK	FILE ND. 96164
						CDUNTY -	APPROVED	SHEET NO.
	REV. NO	DATE	DESCRIPTION	BY	APP'D	STATE -	JEM	14






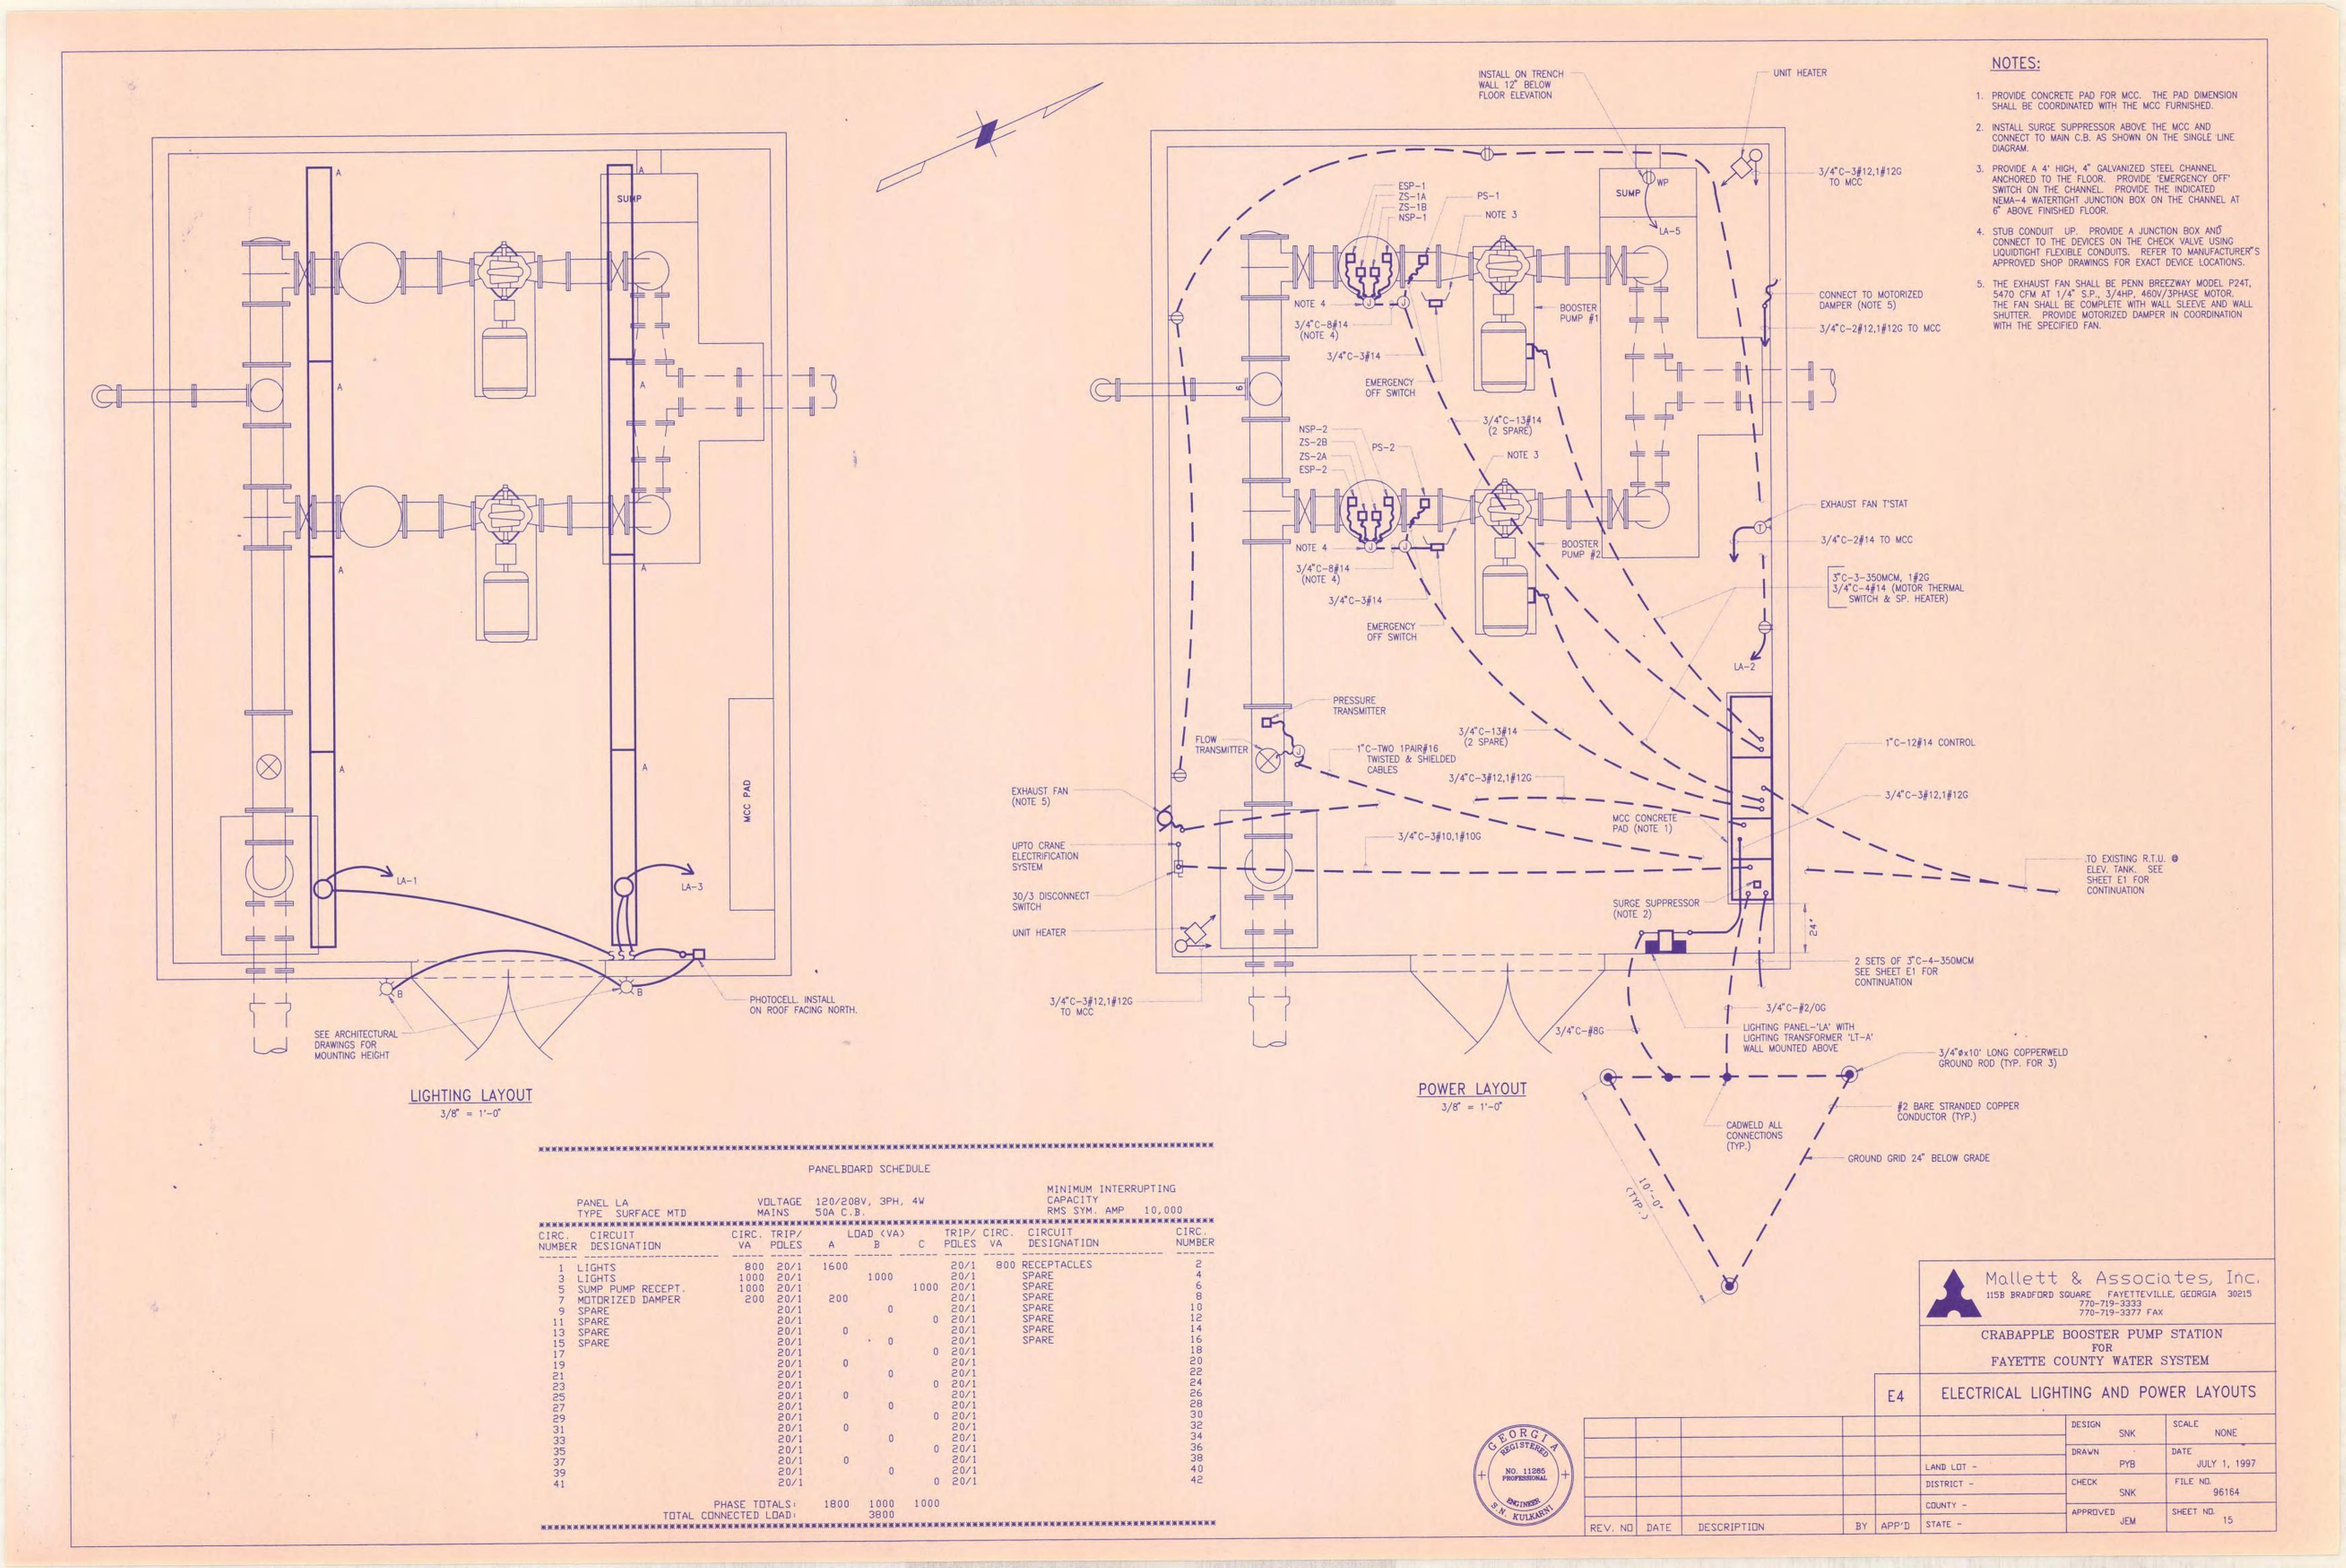


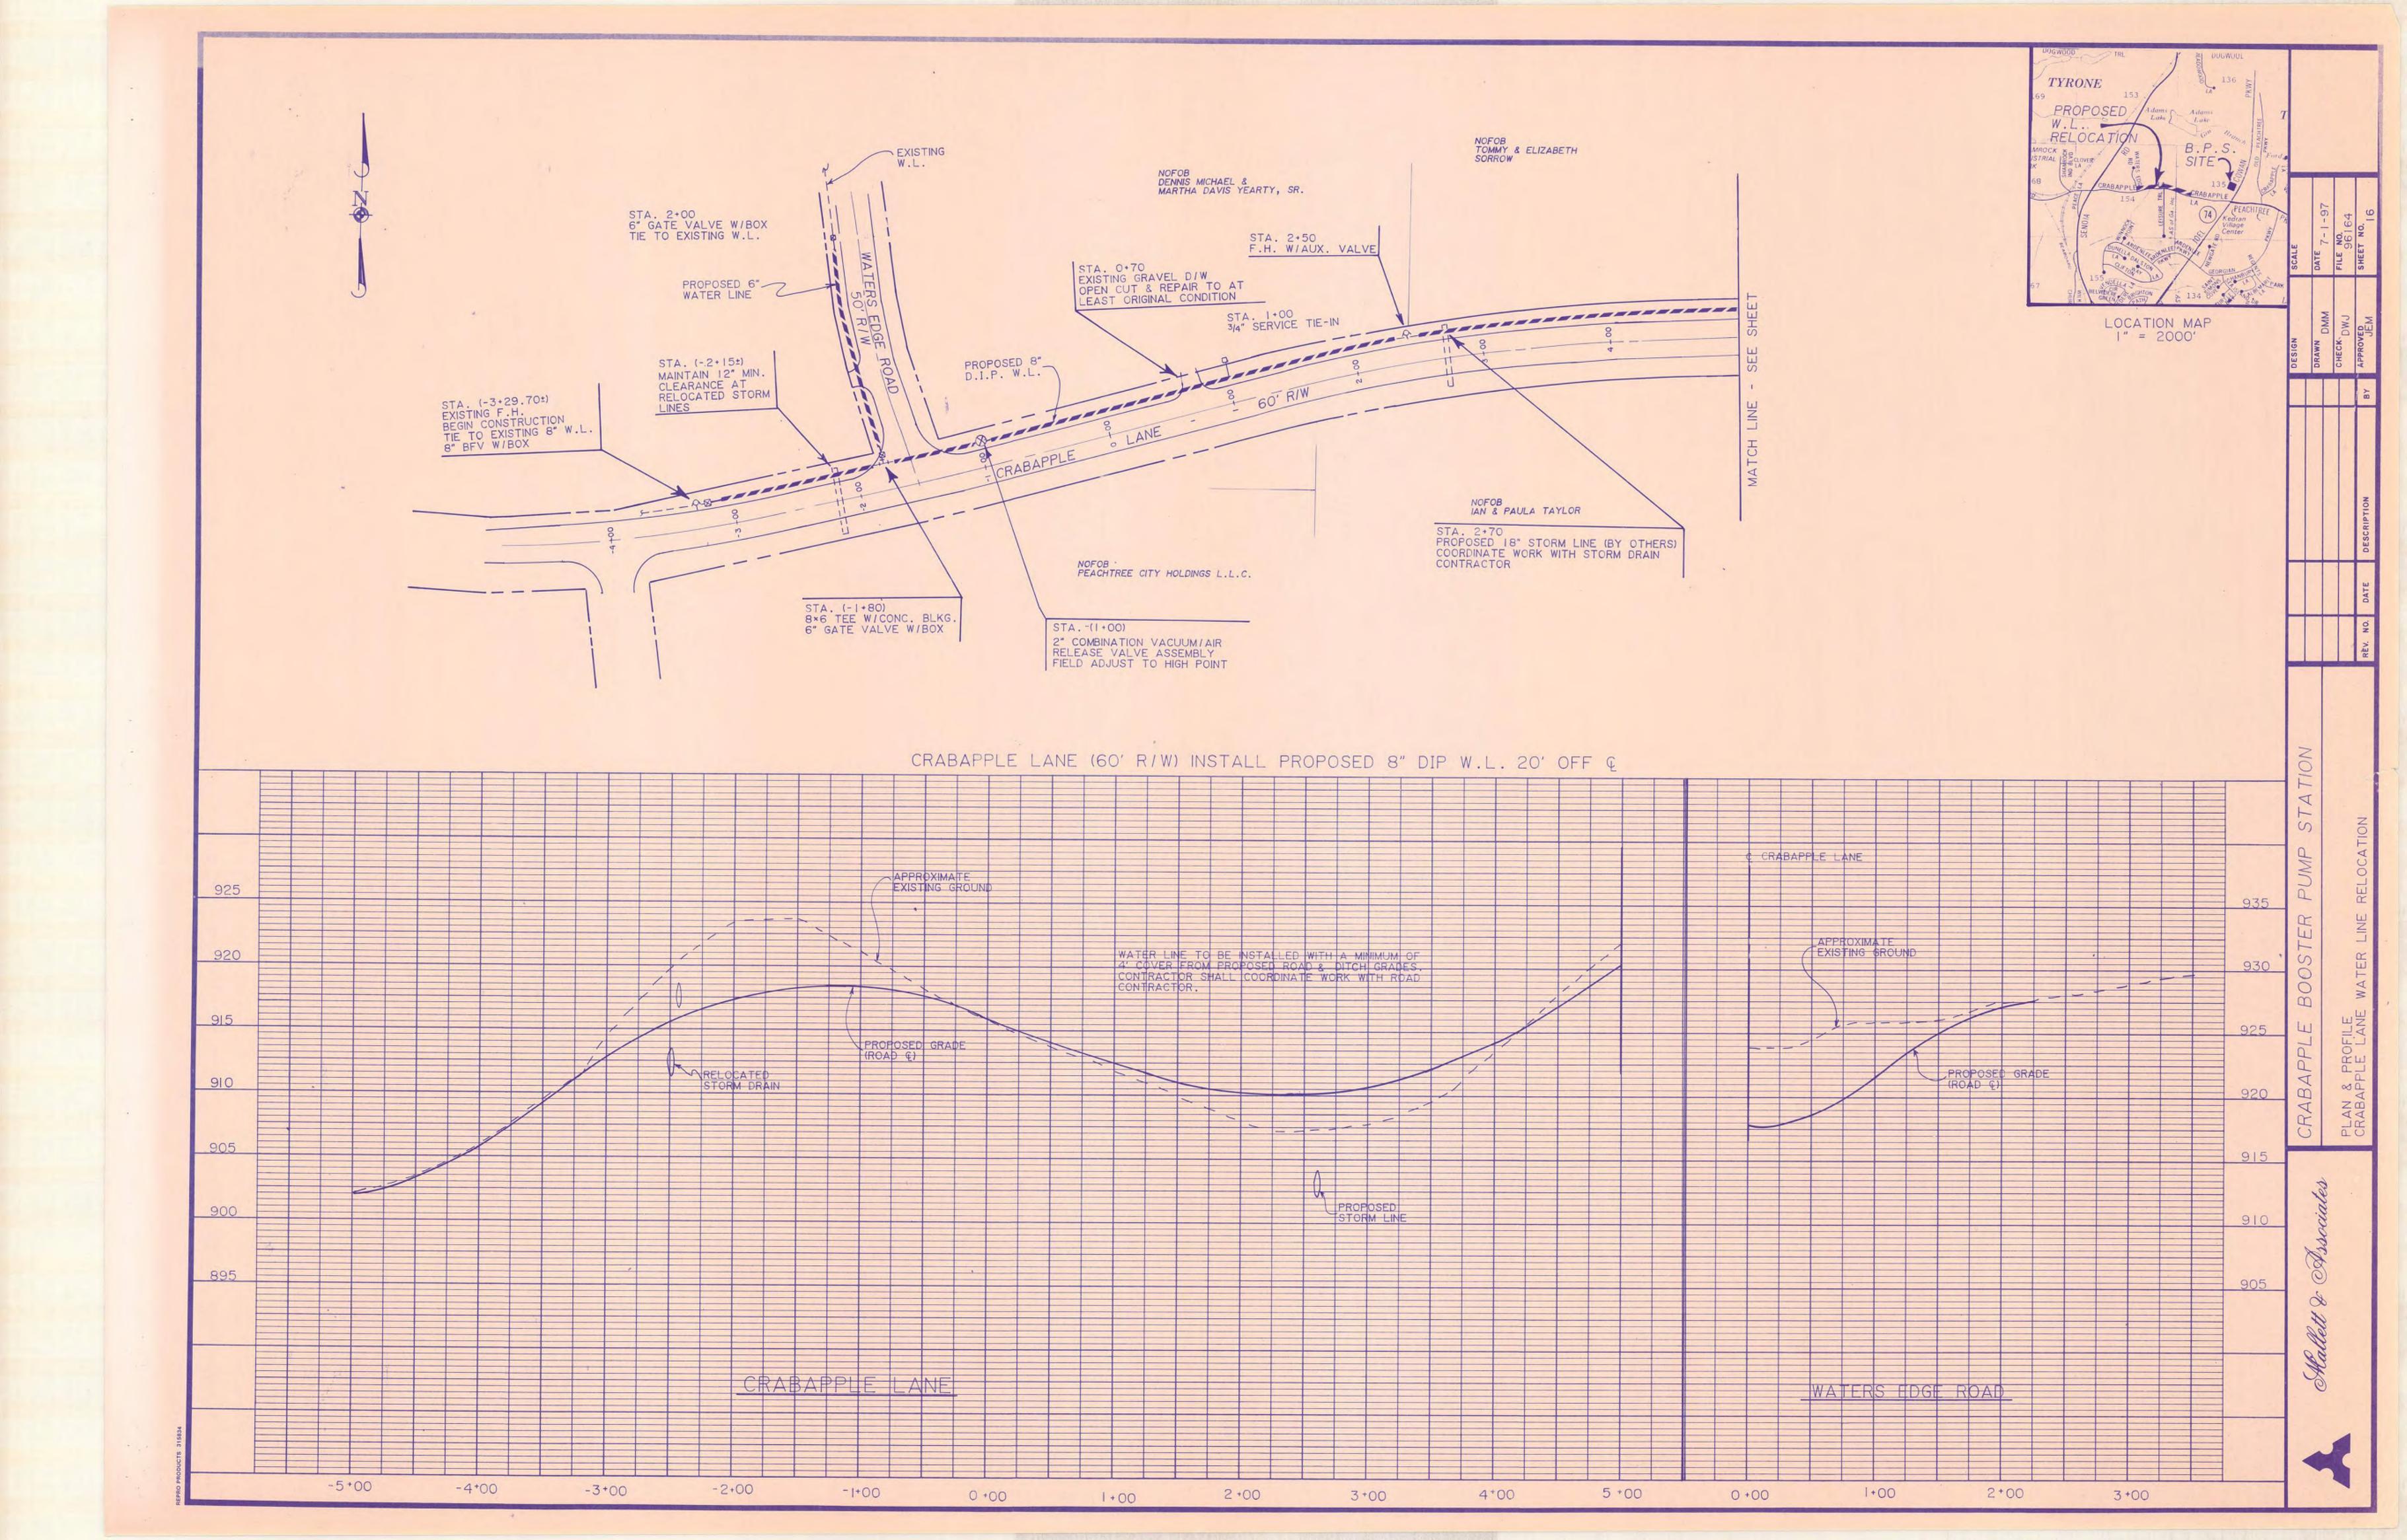

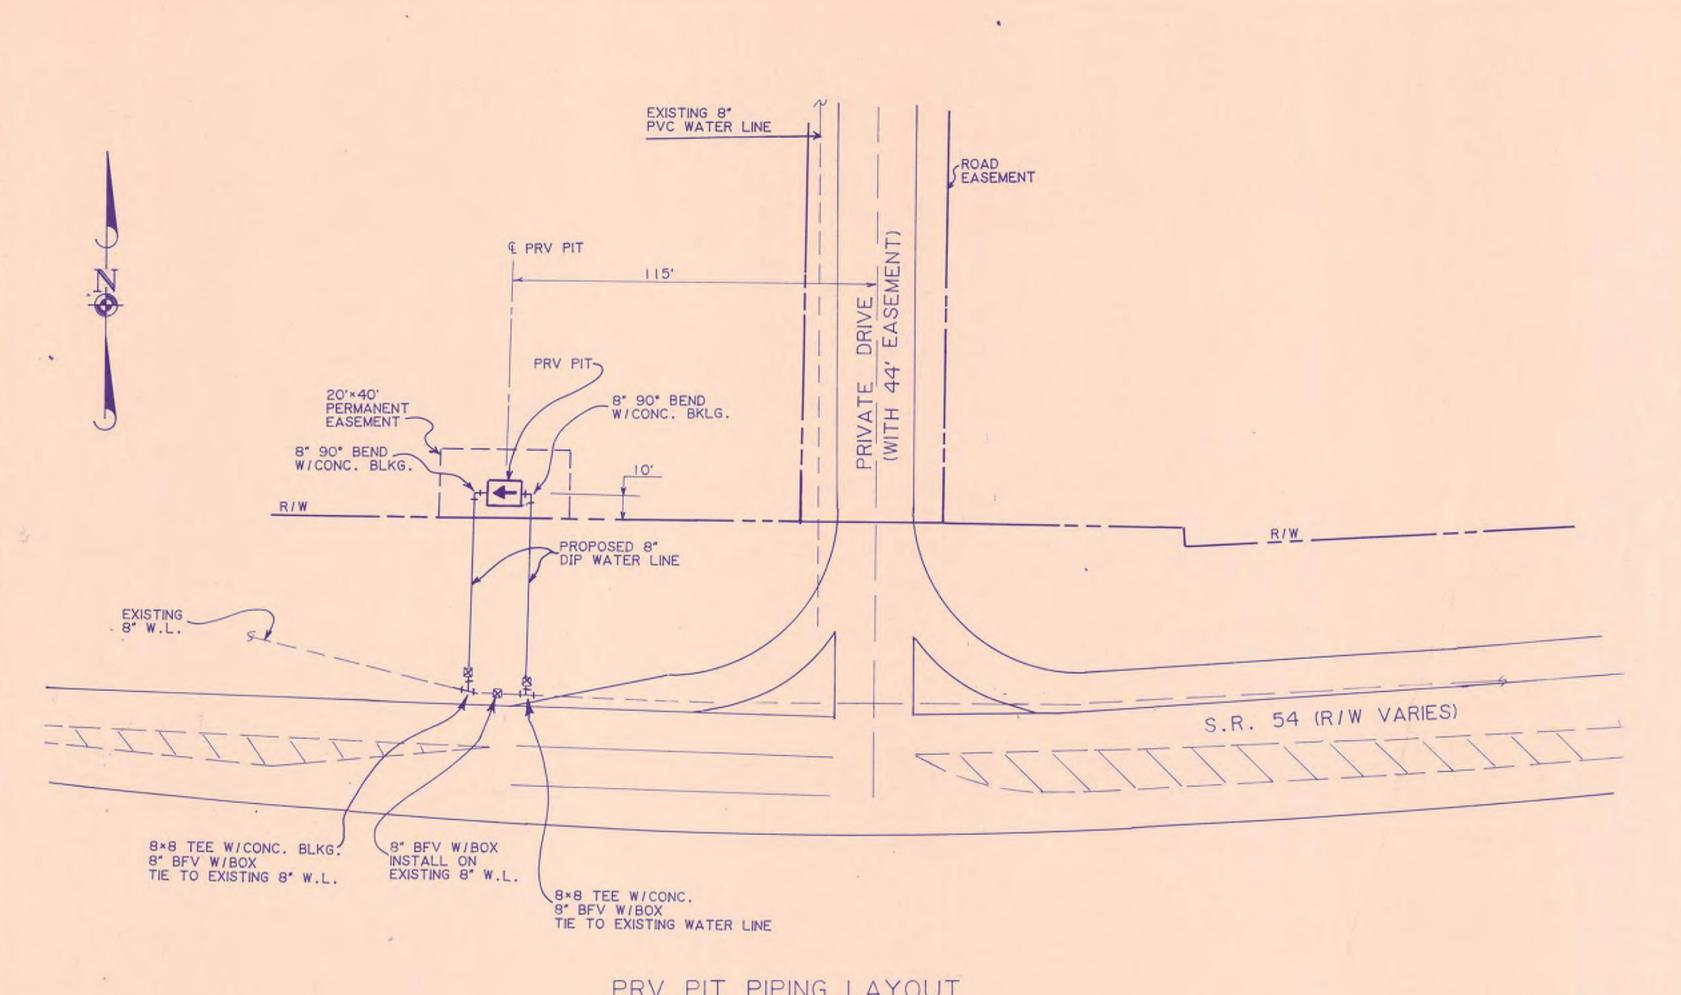



PRV PIT PIPING LAYOUT

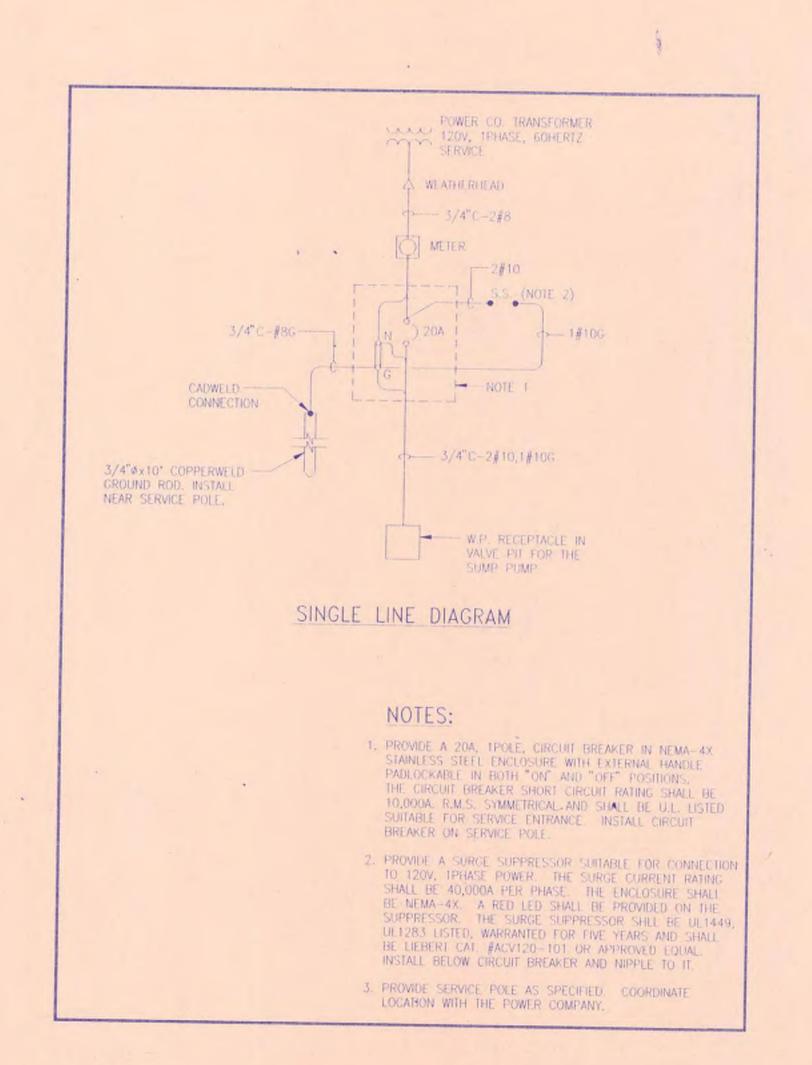

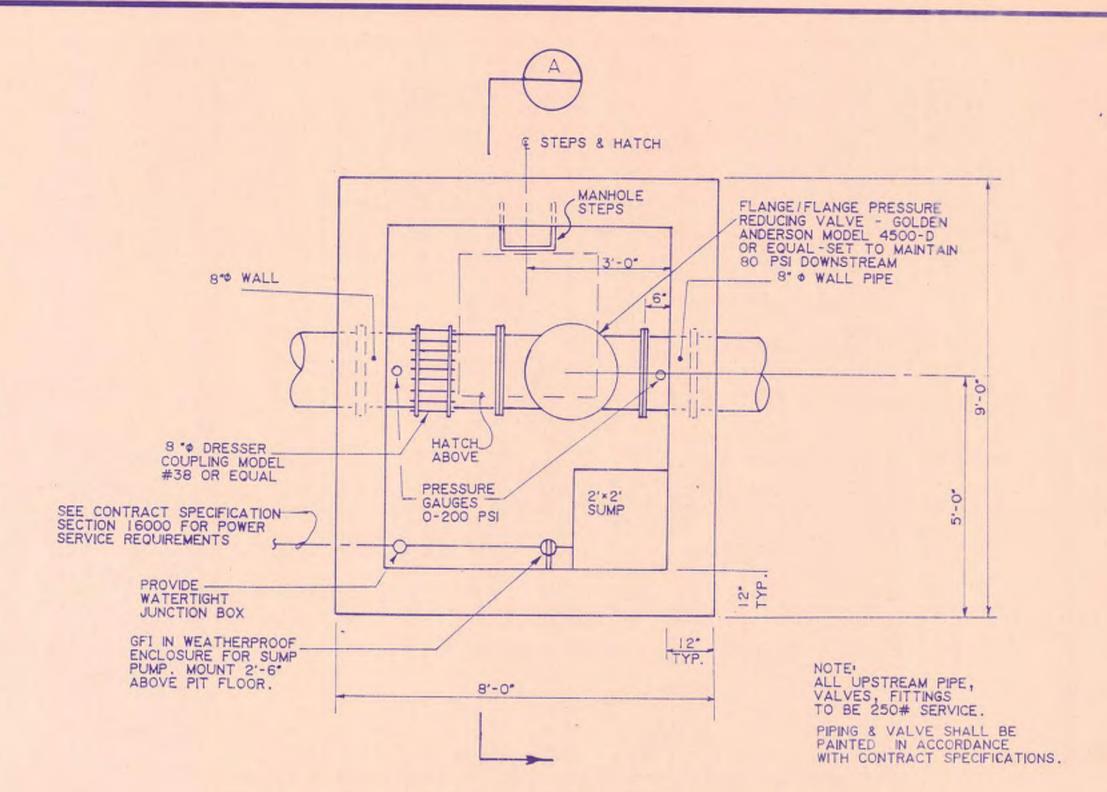

PLAN VIEW - PRESSURE REDUCING VALVE PIT

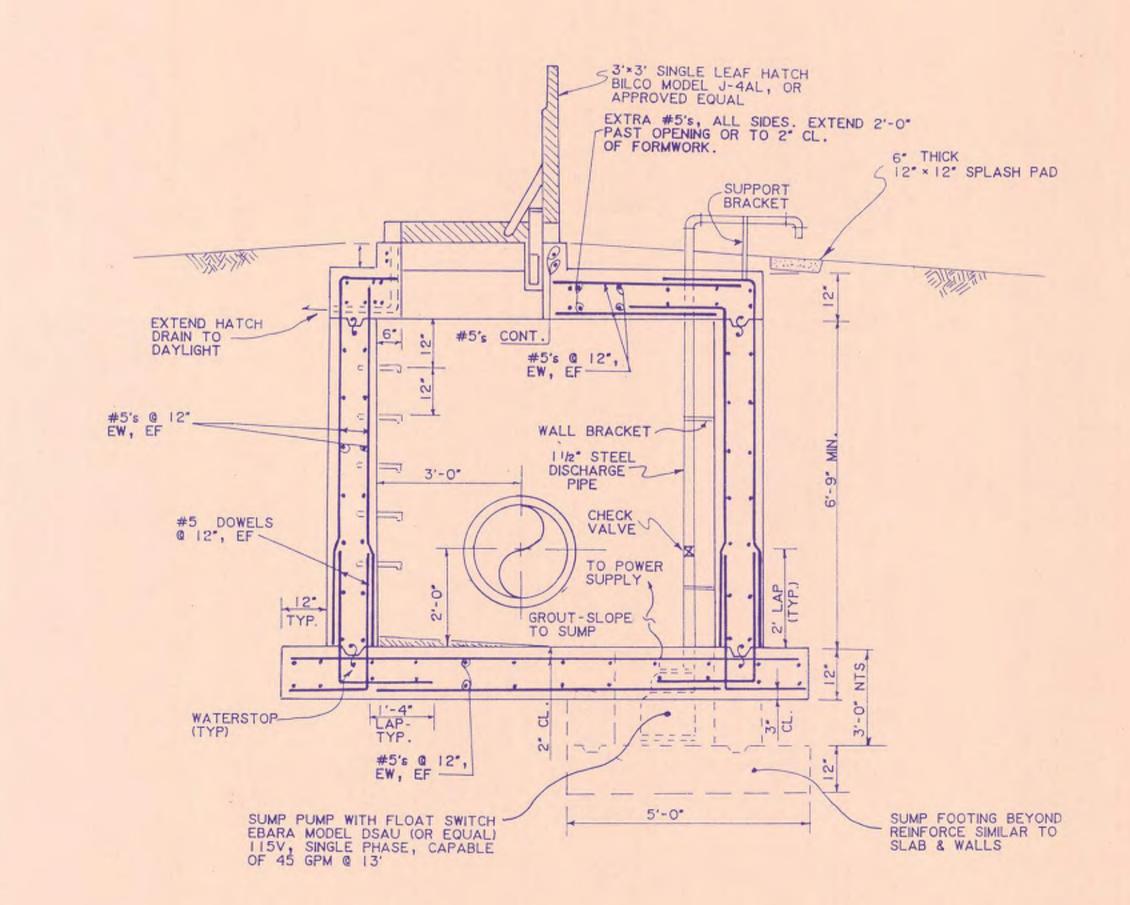

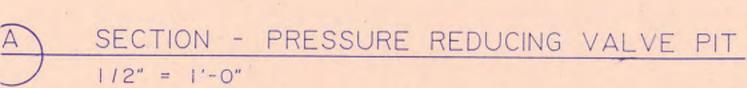



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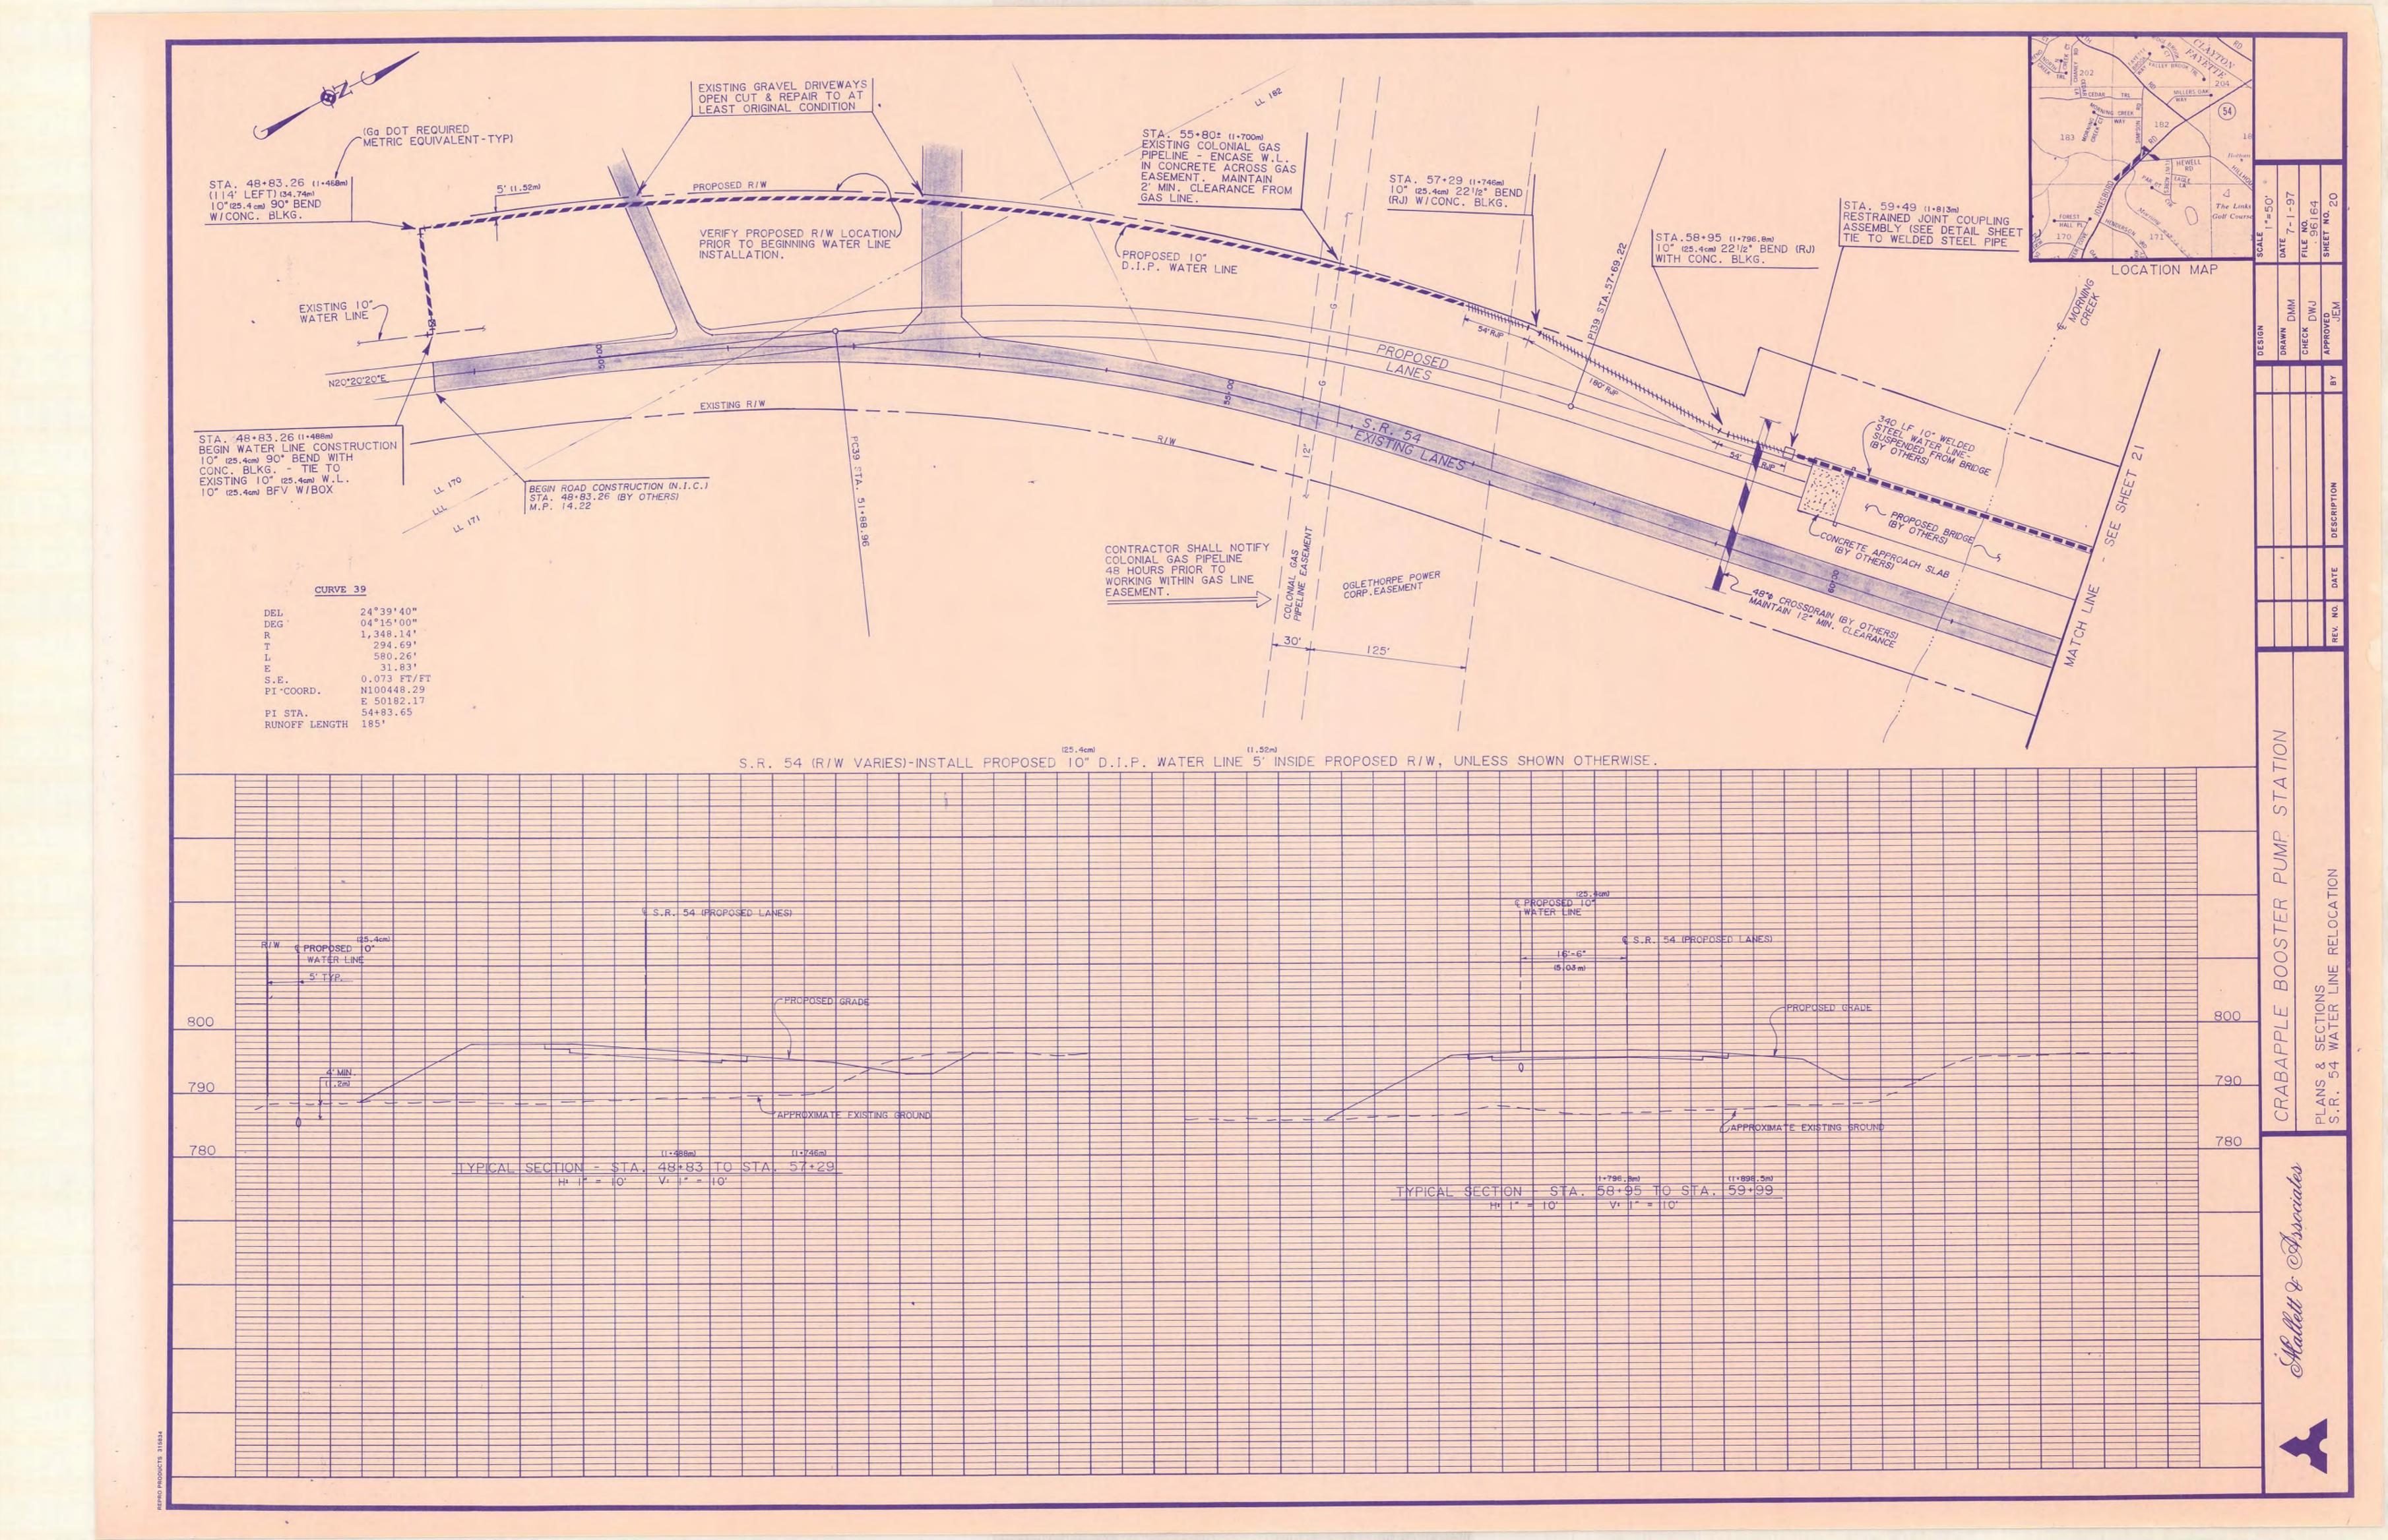
4313 CAMP HIGHLAND RD. SMYRNA, GEORGIA 30080
404/432-5634


LOCATION MAP I" = 2000'


CRABAPPLE BOOSTER'
PUMP STATION

PRV PIT @ HWY. 54

				PRV PIT @ HWY. 54			
						DESIGN	SCALE AS SHOWN
						DRAWN	DATE
					LAND LOT-	DMM	7-1-97
					DISTRICT-	CHECK	FILE NO. 96164
					COUNTY-		SHEET NO.
REV. NO.	DATE	DESCRIPTION	BY	APP'D BY	STATE-	JEM	19



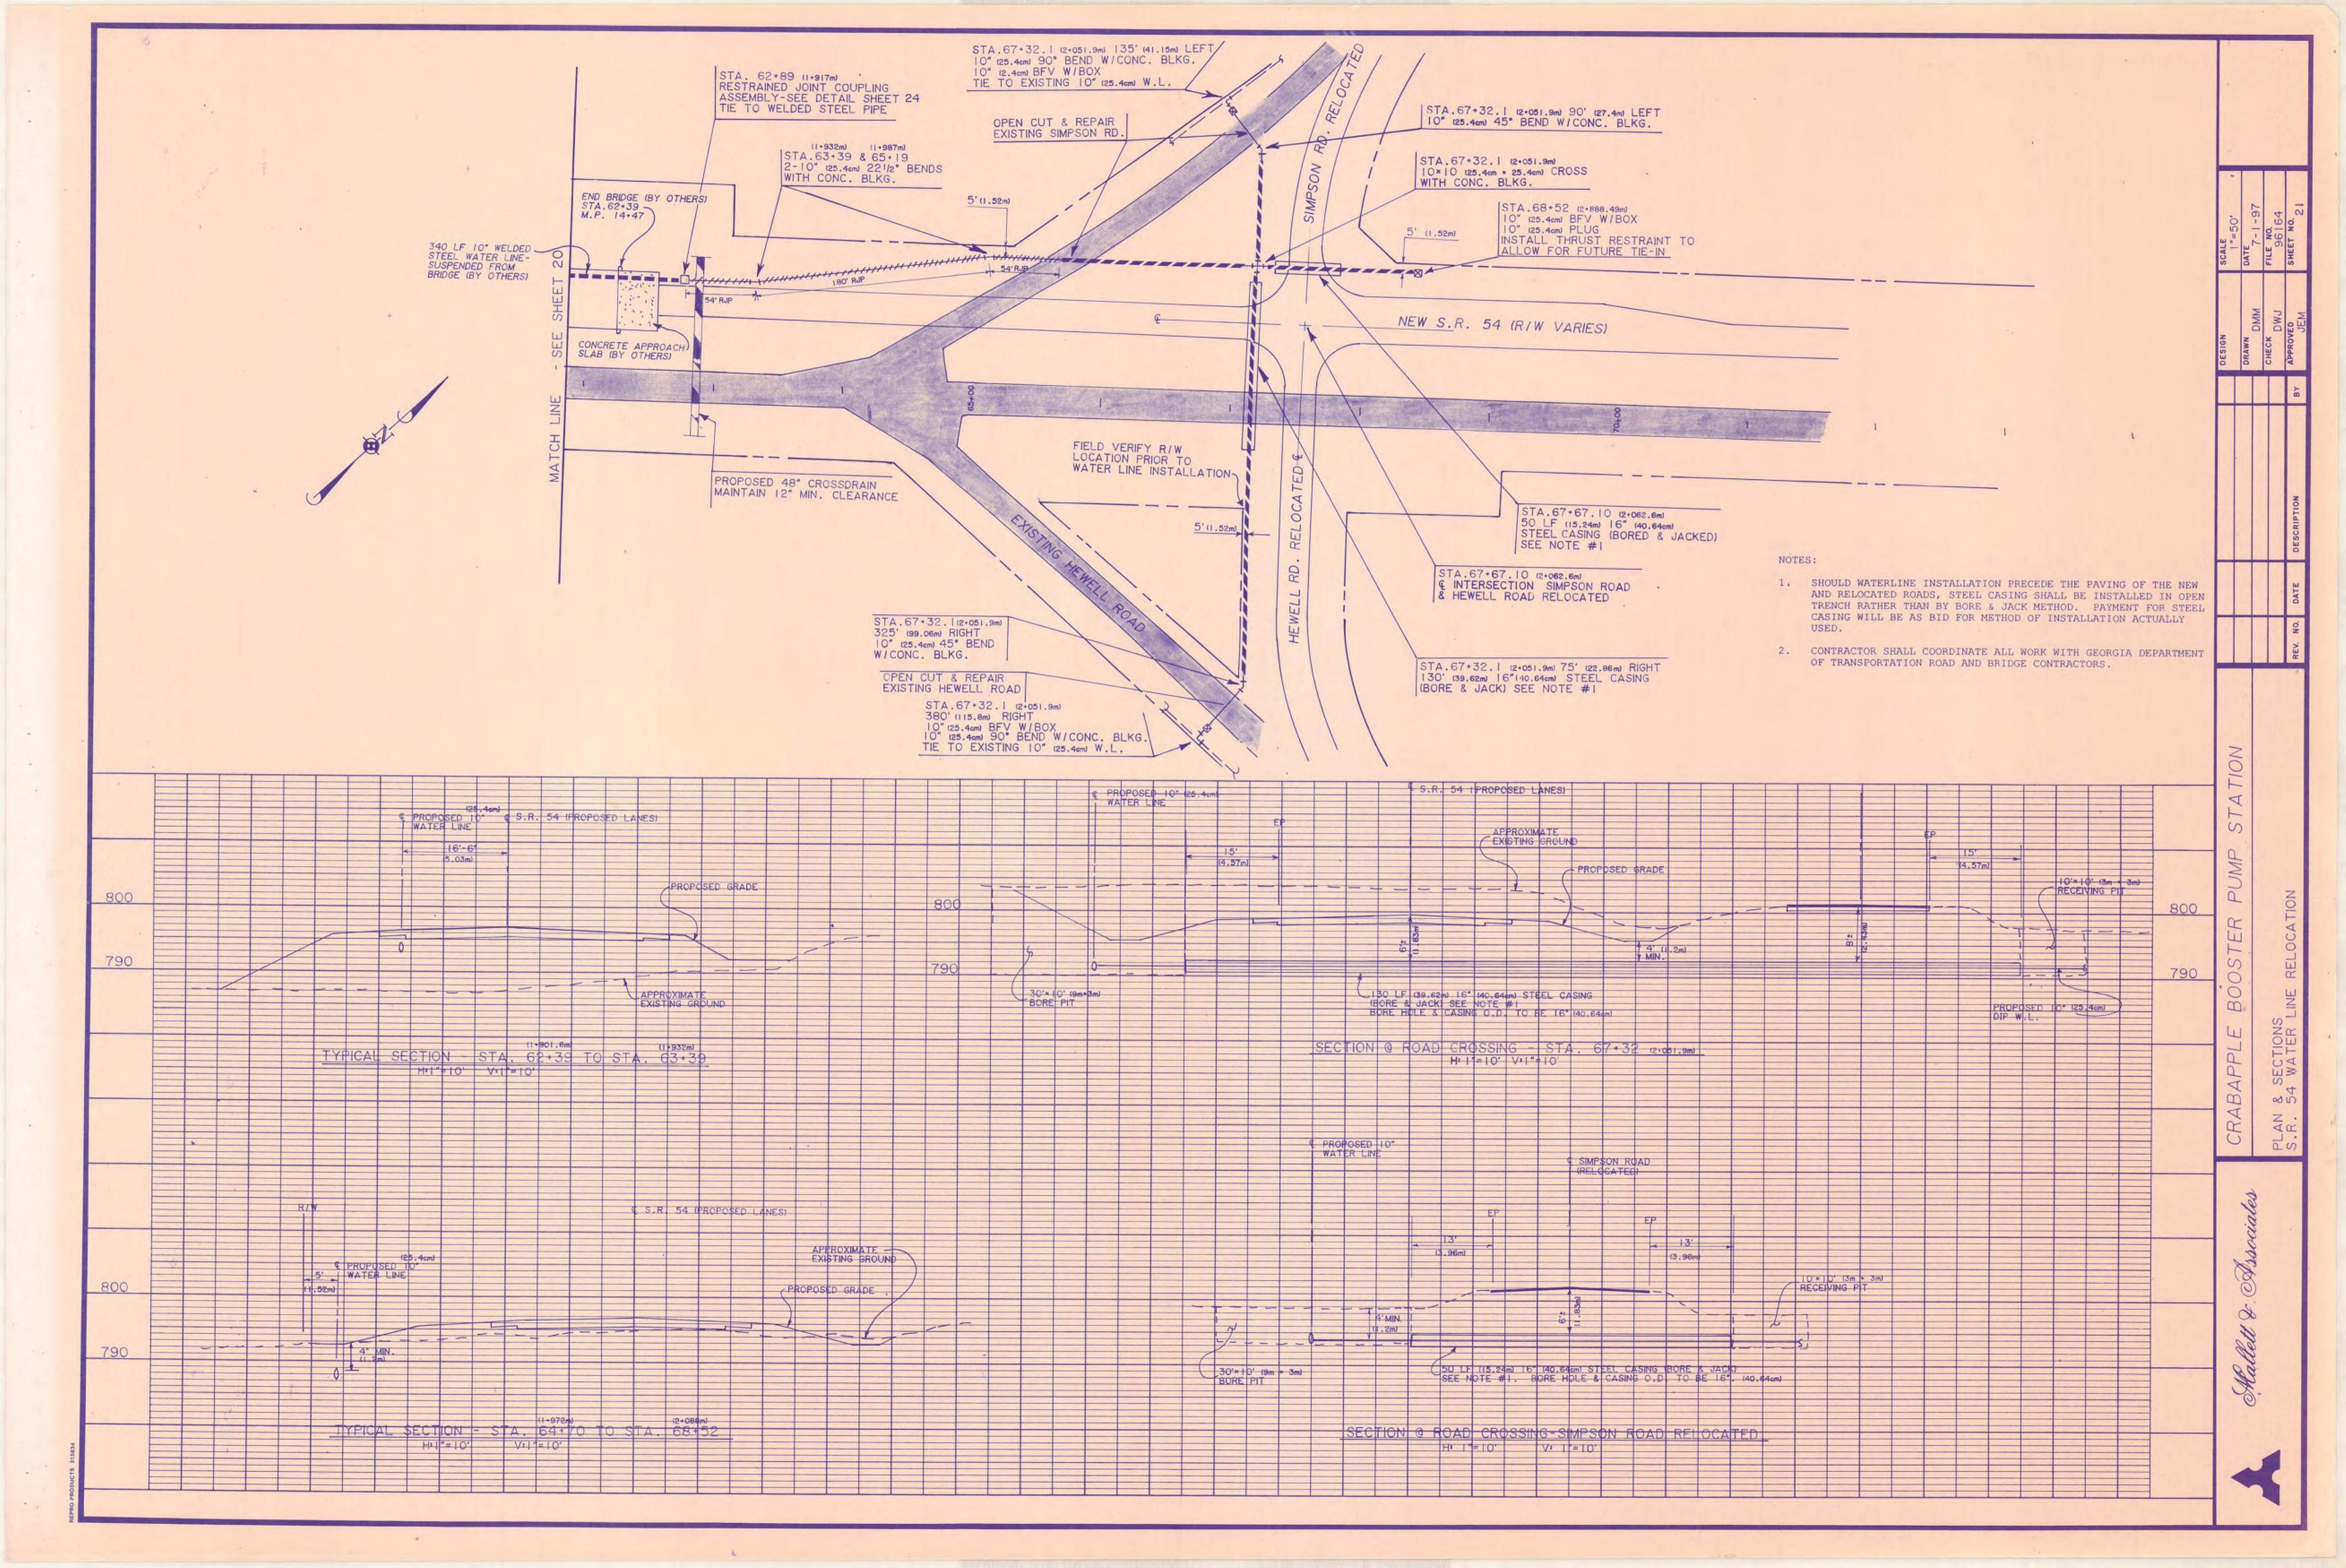

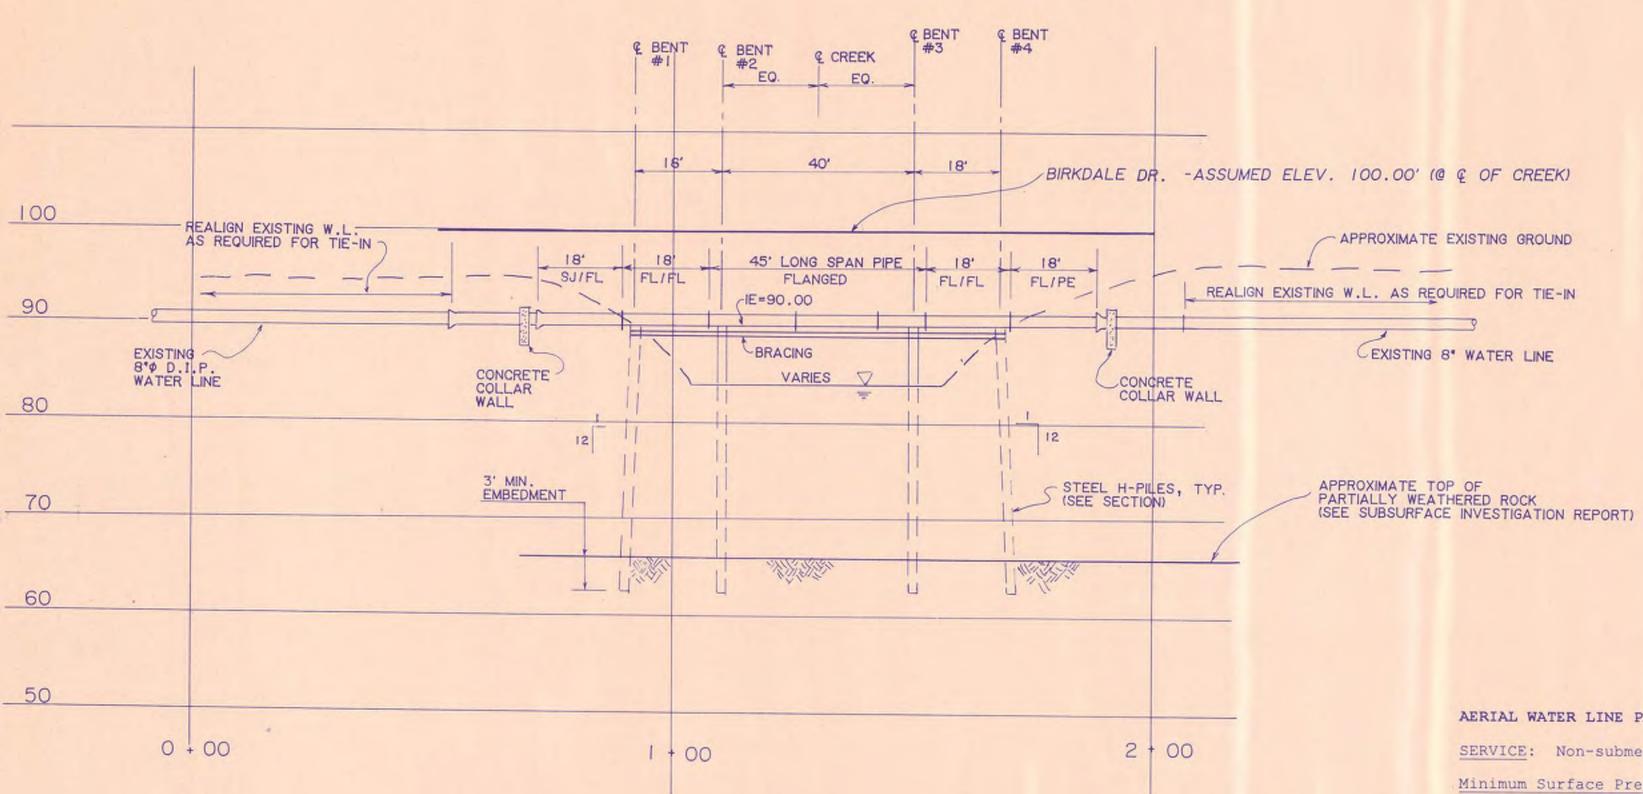

PROFILE - AERIAL CREEK CROSSING, WHITEWATER CREEK @ BIRKDALE DRIVE

H: 1" = 20'

A: 14 = 10,


# AERIAL WATER LINE PAINTING SCHEDULE:


SERVICE: Non-submerged ferrous metal

Minimum Surface Preparation: SSPC-SP6

Generic System Type: Aliphatic Polyurethane

Coat No.	Koppers DFT/Product	Porter DFT/Product
1	2.5/34C GOLD	2.0/#4300
2	2.5/HI-GARD	5.0/#4351
3	2.0/134 H.S.	1.5/#46

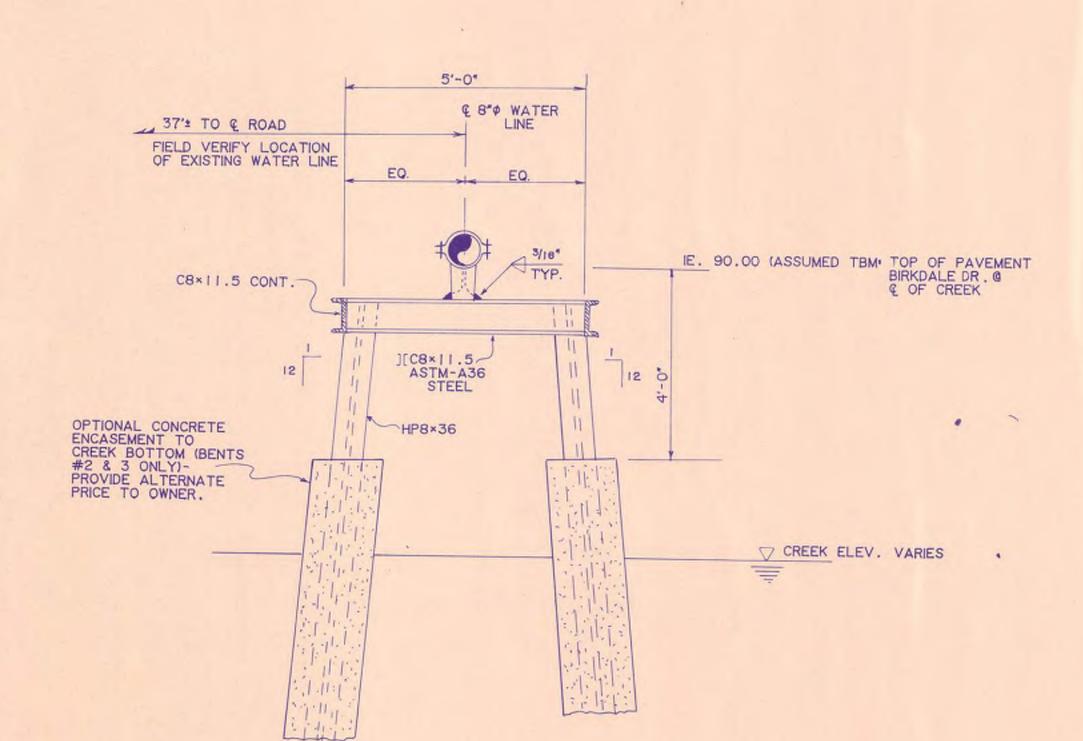

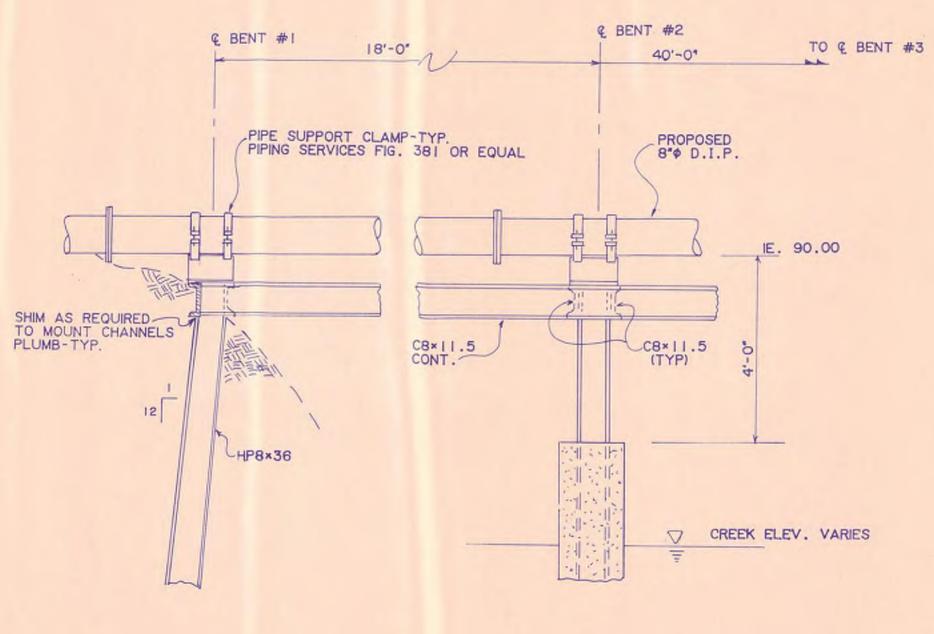

ELEVATION VIEW

1/2" = 1'-0"

LOCATION MAP

## GENERAL NOTES:

- 1. PILING TO BE IN ACCORDANCE WITH THE GEORGIA DEPARTMENT OF TRANSPORTATION STANDARD SPECIFICATIONS SECTION 250 AND
- SECTION 855. 2. PILING SHALL BE DRIVEN IN ACCORDANCE WITH GEORGIA DEPARTMENT OF TRANSPORTATION STANDARD 520, THROUGH THE ALLUVIUM, INTO THE RESIDUAL SOILS AND THEN TO EITHER OF THE FOLLOWING: A. REFUSAL, OR
  - B. 5-TON PILE CAPACITY AND 3' MINIMUM EMBEDMENT INTO PARTIALLY WEATHERED ROCK.
- 3. DRIVING SHOES SHALL BE UTILIZED TO FACILITATE REQUIRED
- EMBEDMENT INTO PARTIALLY WEATHERED ROCK LAYER. 4. ALL PILES SHALL BE COATED WITH A 2P COATING IN ACCORDANCE WITH GEORGIA DEPARTMENT OF TRANSPORTATION SPECIFICATION
- 520.04. EXISTING UTILITIES SHOWN ARE APPROXIMATE AND DO NOT NECESSARILY REPRESENT ALL UTILITIES. CONTRACTOR SHALL LOCATE ALL UTILITIES PRIOR TO BEGINNING WORK. NO ADDITIONAL COMPENSATION WILL BE MADE FOR DAMAGE AND REPAIR TO EXISTING UTILITIES OR FOR CONFLICTS/DELAYS WHICH ARISE FROM LOCATION OF EXISTING UTILITIES.
  - CONCRETE TO BE 3000 PSI MINIMUM.
- ALL STEEL TO BE ASTM A-36. ALL WELDS TO BE MINIMUM 3/16"
- SEAL WELDS. 8. FLANGED PIPE TO BE DUCTILE IRON, CLASS 53, IN ACCORDANCE
- WITH ANSI A21.51. 9. FLANGES TO BE 125 LB. STD., DUCTILE IRON.
- 10. ALL OTHER DUCTILE IRON PIPE TO BE PRESSURE CLASS 300 IN ACCORDANCE WITH ANSI A21.51.
- 11. ALL PIPE SHALL HAVE CEMENT LINING IN ACCORDANCE WITH ANSI A21.4 OR AWWA C205.
- 12. BURIED PIPE SHALL HAVE EXTERIOR BITUMINOUS COATING.
- 13. EXPOSED PIPE SHALL BE PRIMED AT FACTORY.
- 14. CONTRACTOR SHALL REMOVE EXISTING TIMBER PILES AND DAMAGED 8"
- 15. ALL DISTURBED AREAS SHALL BE GRASSED UPON COMPLETION. TEMPORARY GRASSING SHALL BE USED UNTIL PERMANENT GRASSING
- CAN BE ESTABLISHED. 16. EROSION CONTROL MEASURES SHALL INCLUDE SILT FENCE, HAY BALES, AND RIP-RAP AS NECESSARY TO MINIMIZE SILTATION AND EROSION THROUGHOUT THE WORK.


Mallett & Associates, Inc.


CRABAPPLE BOOSTER PUMP STATION

AERIAL CROSSING, WHITEWATER CREEK


	**					@ BIRKDALE DRIVÉ		
							DESIGN DWJ	AS NOTED
ı						LAND LOT-	DMM DMM	7-1-97
						DISTRICT-	CHECK	FILE NO. 96164
١						COUNTY-	APPROVED	SHEET NO.
	REV. NO.	DATE	DESCRIPTION	BY	APP'D BY	STATE-	JEM	22

SECTION @ SUPPORT PIER 1/2" = 1'-0"

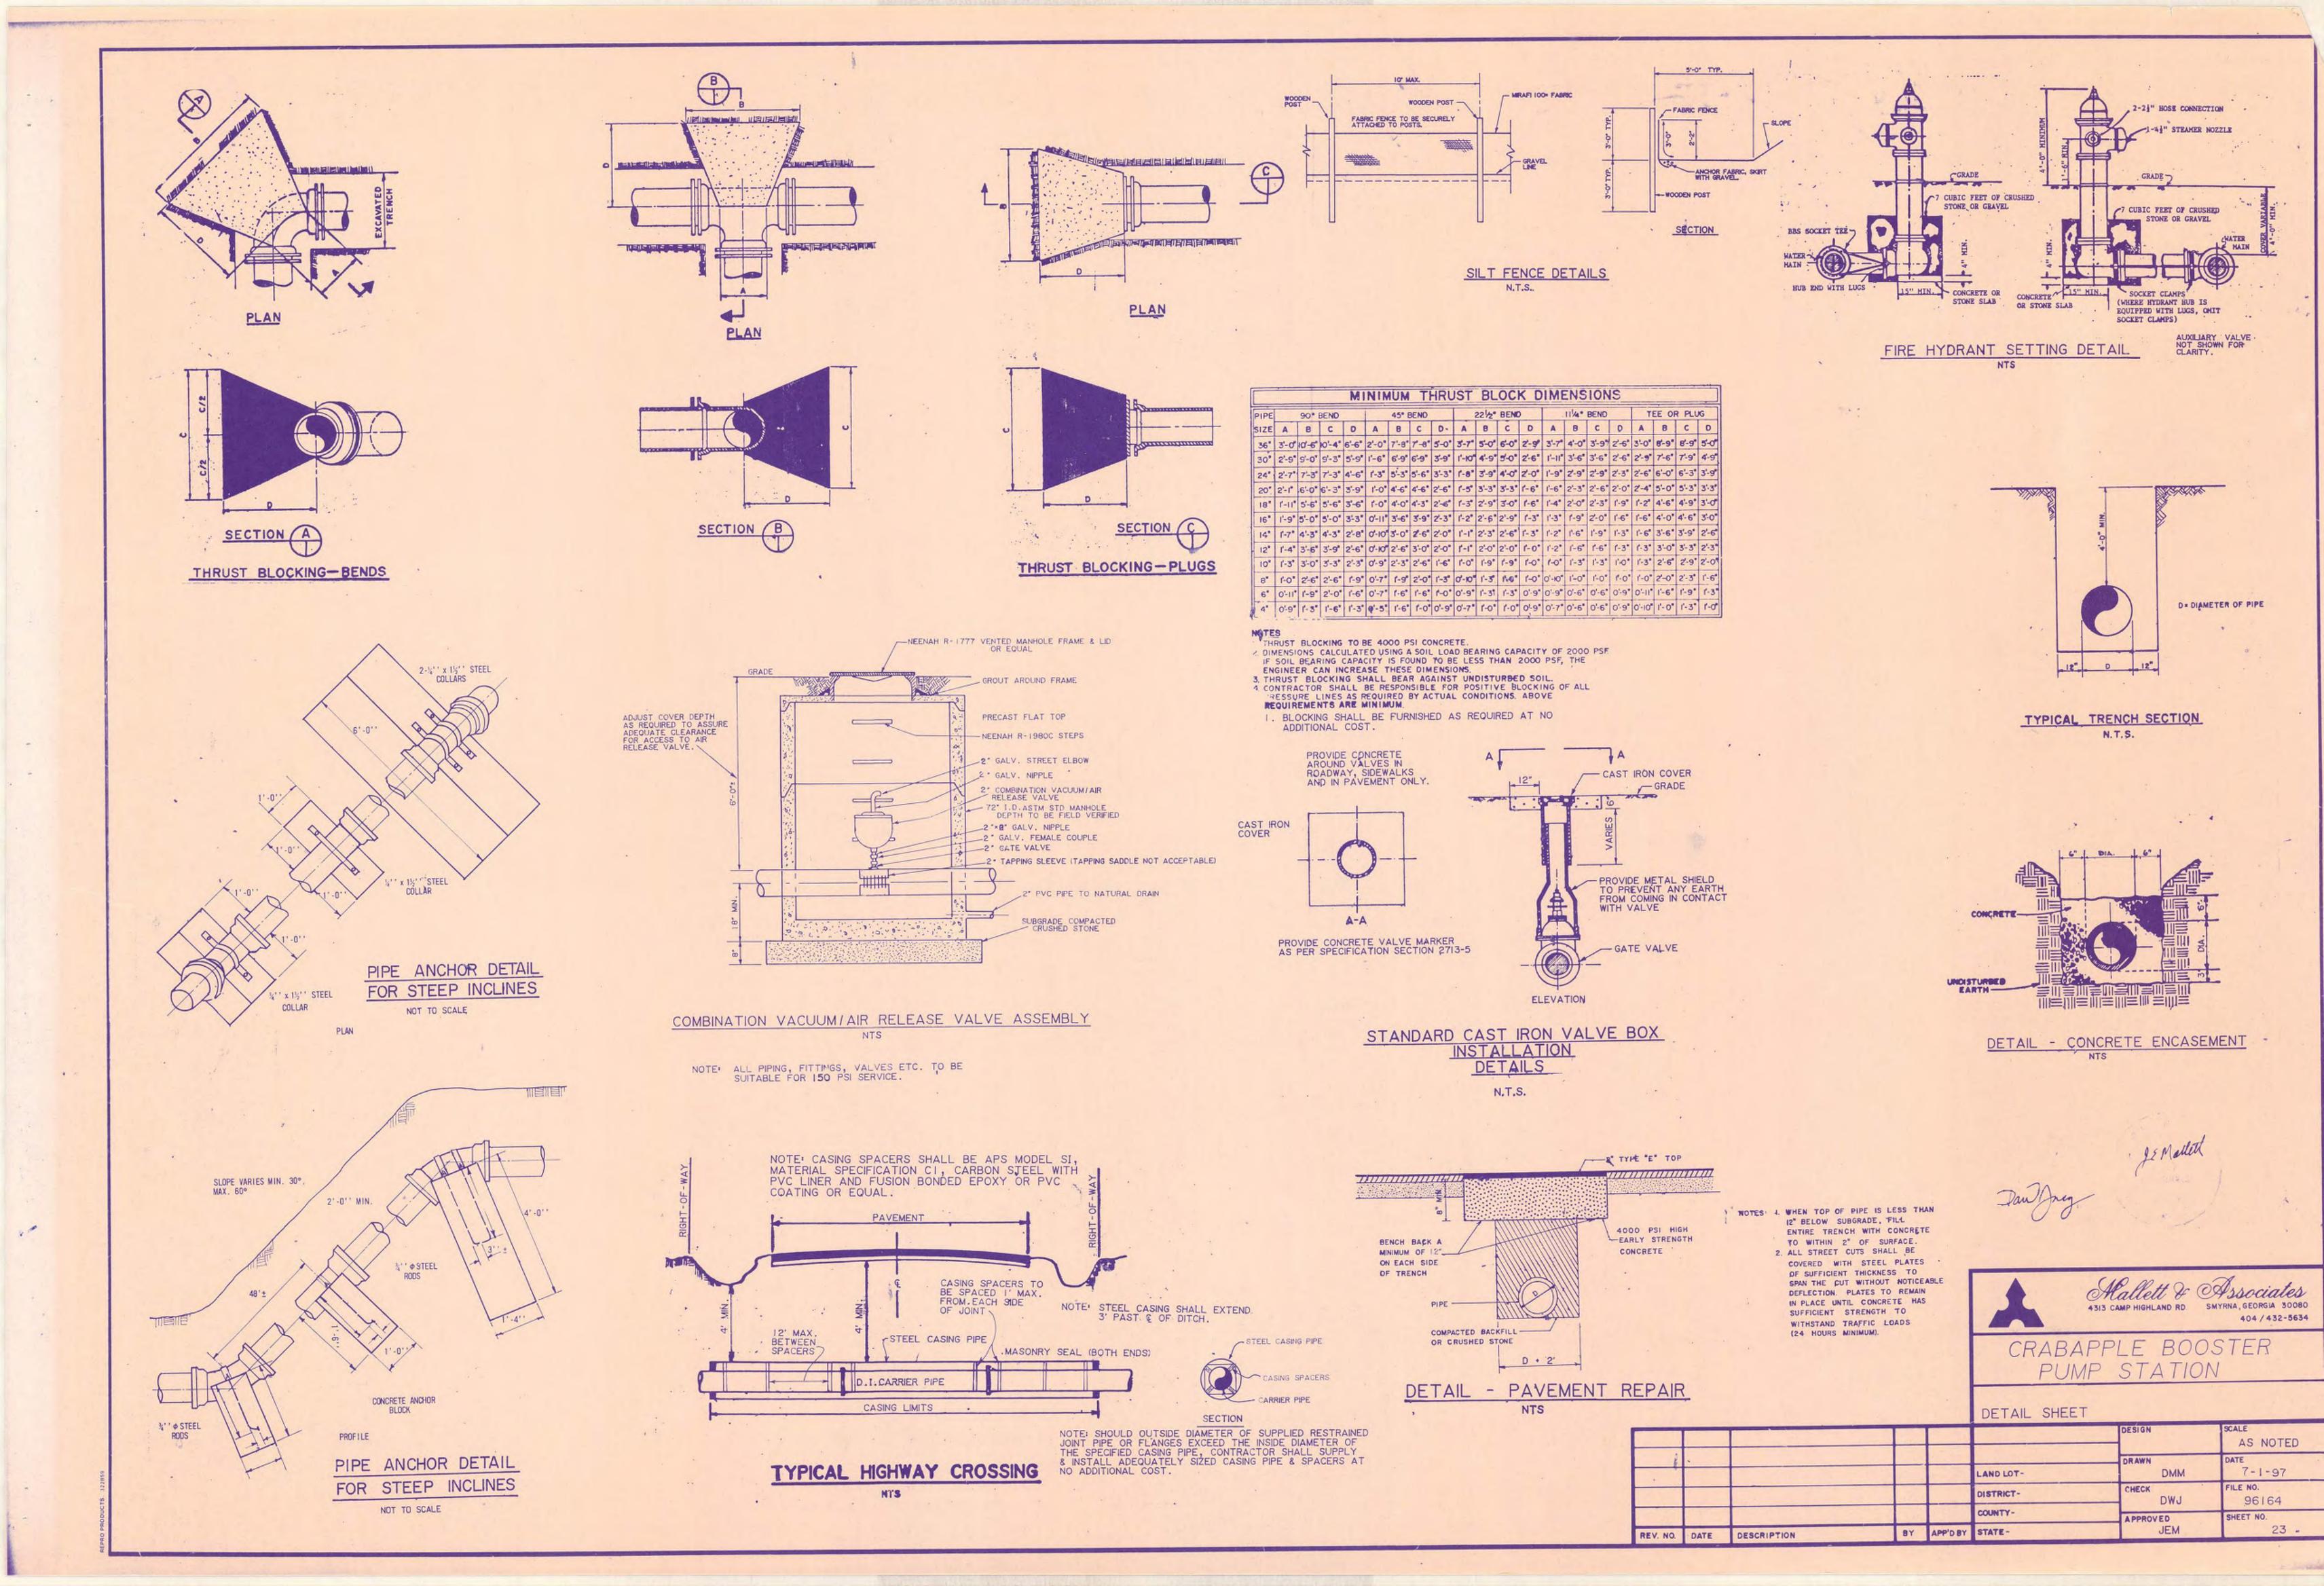

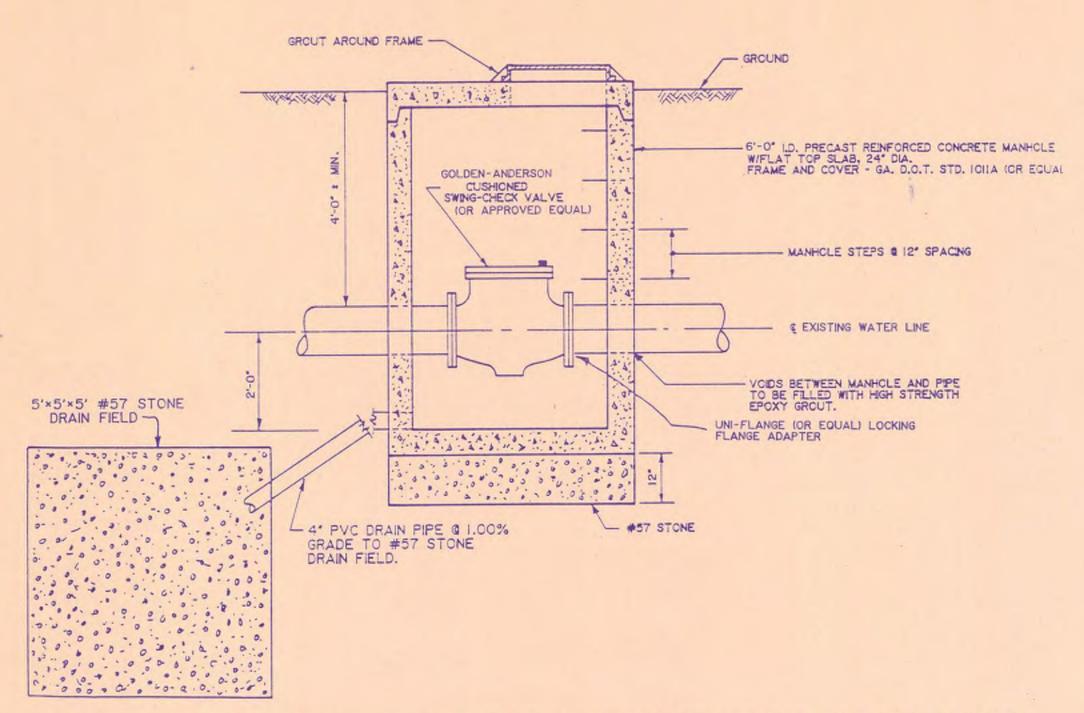


DETAIL-MANHOLE FOR CUSHIONED SWING-CHECK VALVE 1/2" = 1'-0"

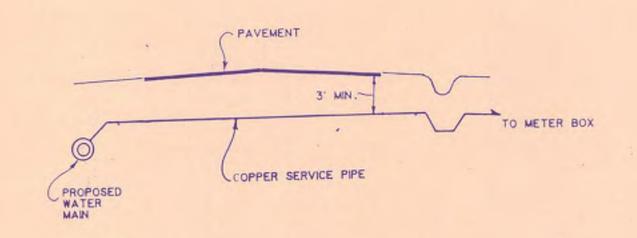


# TYPICAL SERVICE INSTALLATION UNDER ROADWAY

NTS

NOTE: IN THE CASE WHERE TWO 3/4" DOMESTIC METERS ARE FED FROM ONE SERVICE PIPE, THE SERVICE PIPE SHALL BE 1 1/2" DIA. TO THE BRANCH.

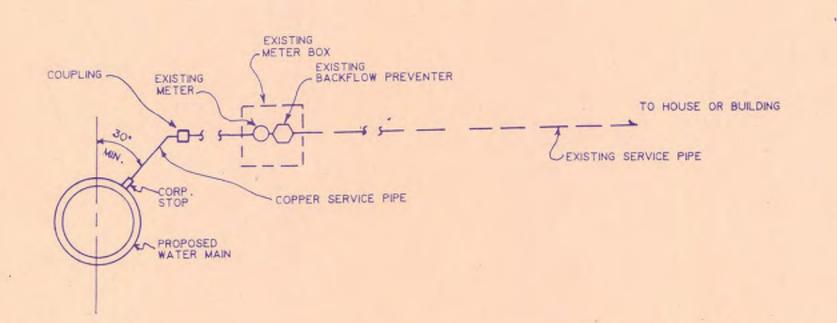

TYPICAL SERVICE TIE-IN NTS

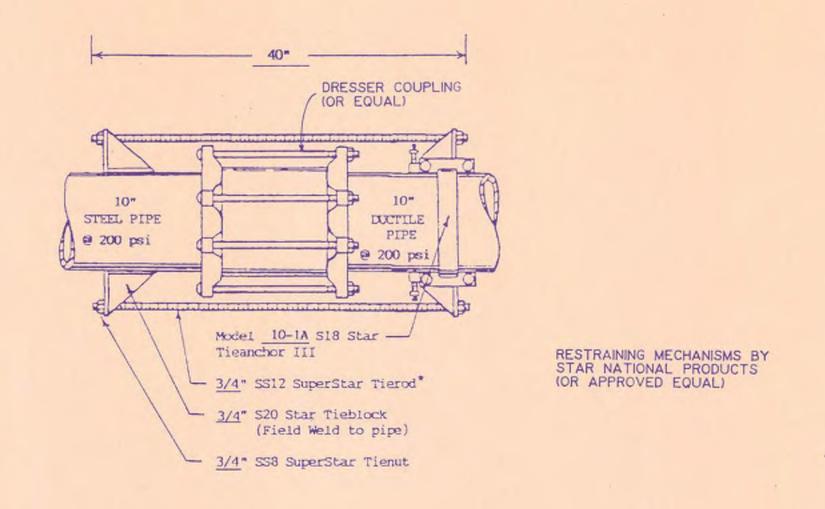

DETAIL-RESTRAINED JOINT COUPLING ASSEMBLY NTS



Mallett & Associates, Inc.

CRABAPPLE BOOSTER PUMP STATION

					DETAIL SHEET			
						DESIGN	AS SHOWN	
						DRAWN	DATE	
					LAND LOT-	DMM	7-1-97	
					DISTRICT-	DWJ	FILE NO. 96164	
					COUNTY-		SHEET NO.	
REV. NO.	DATE	DESCRIPTION	BY	APP'D BY	STATE-	JEM	24	